## **Environmental Statement**







Volume 3 - Figures

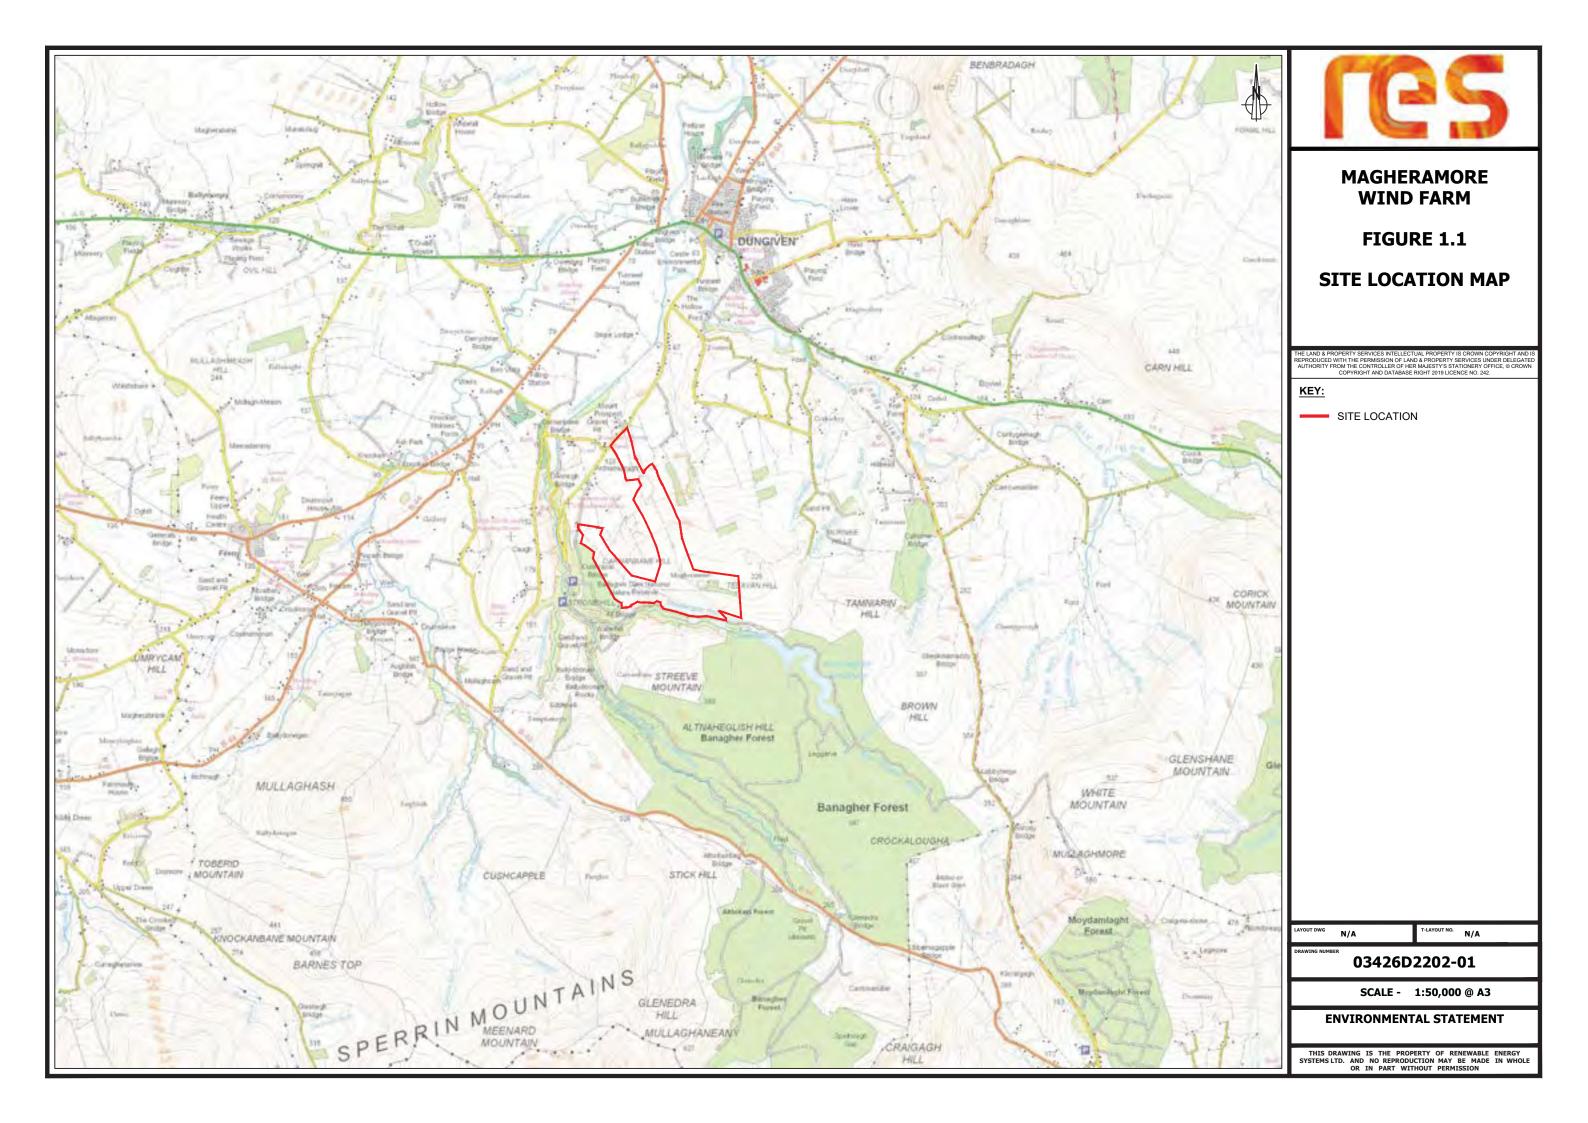


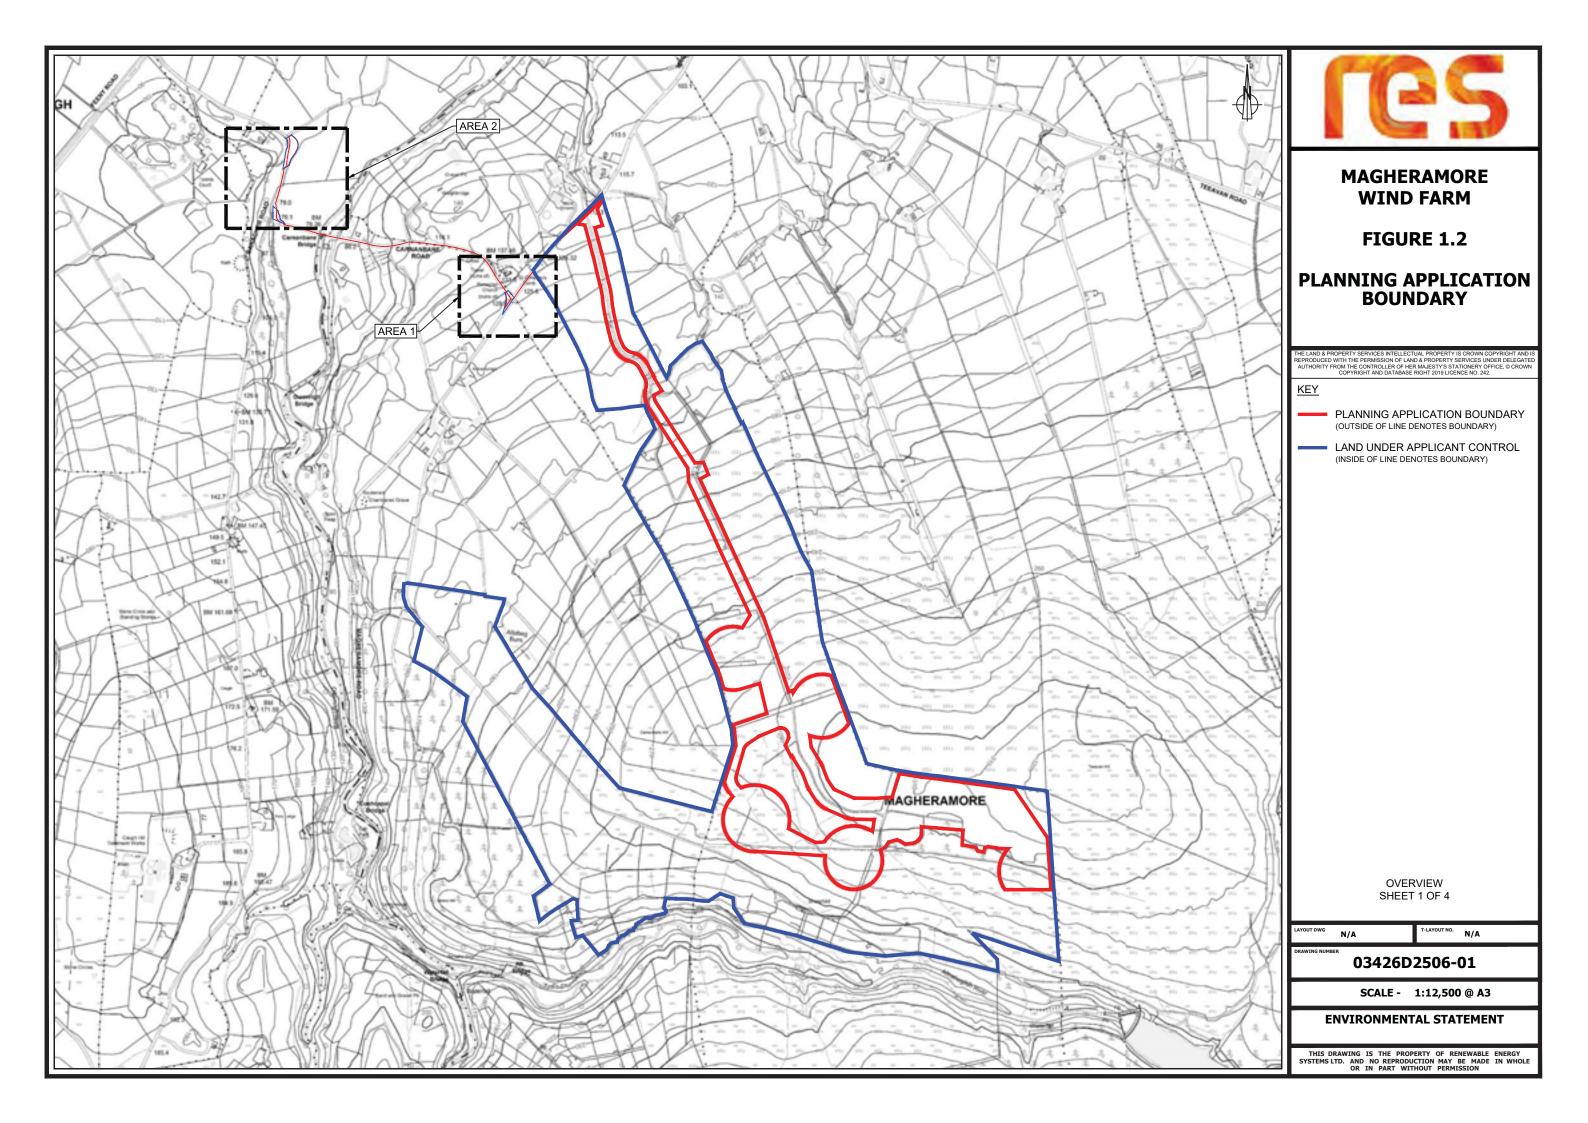


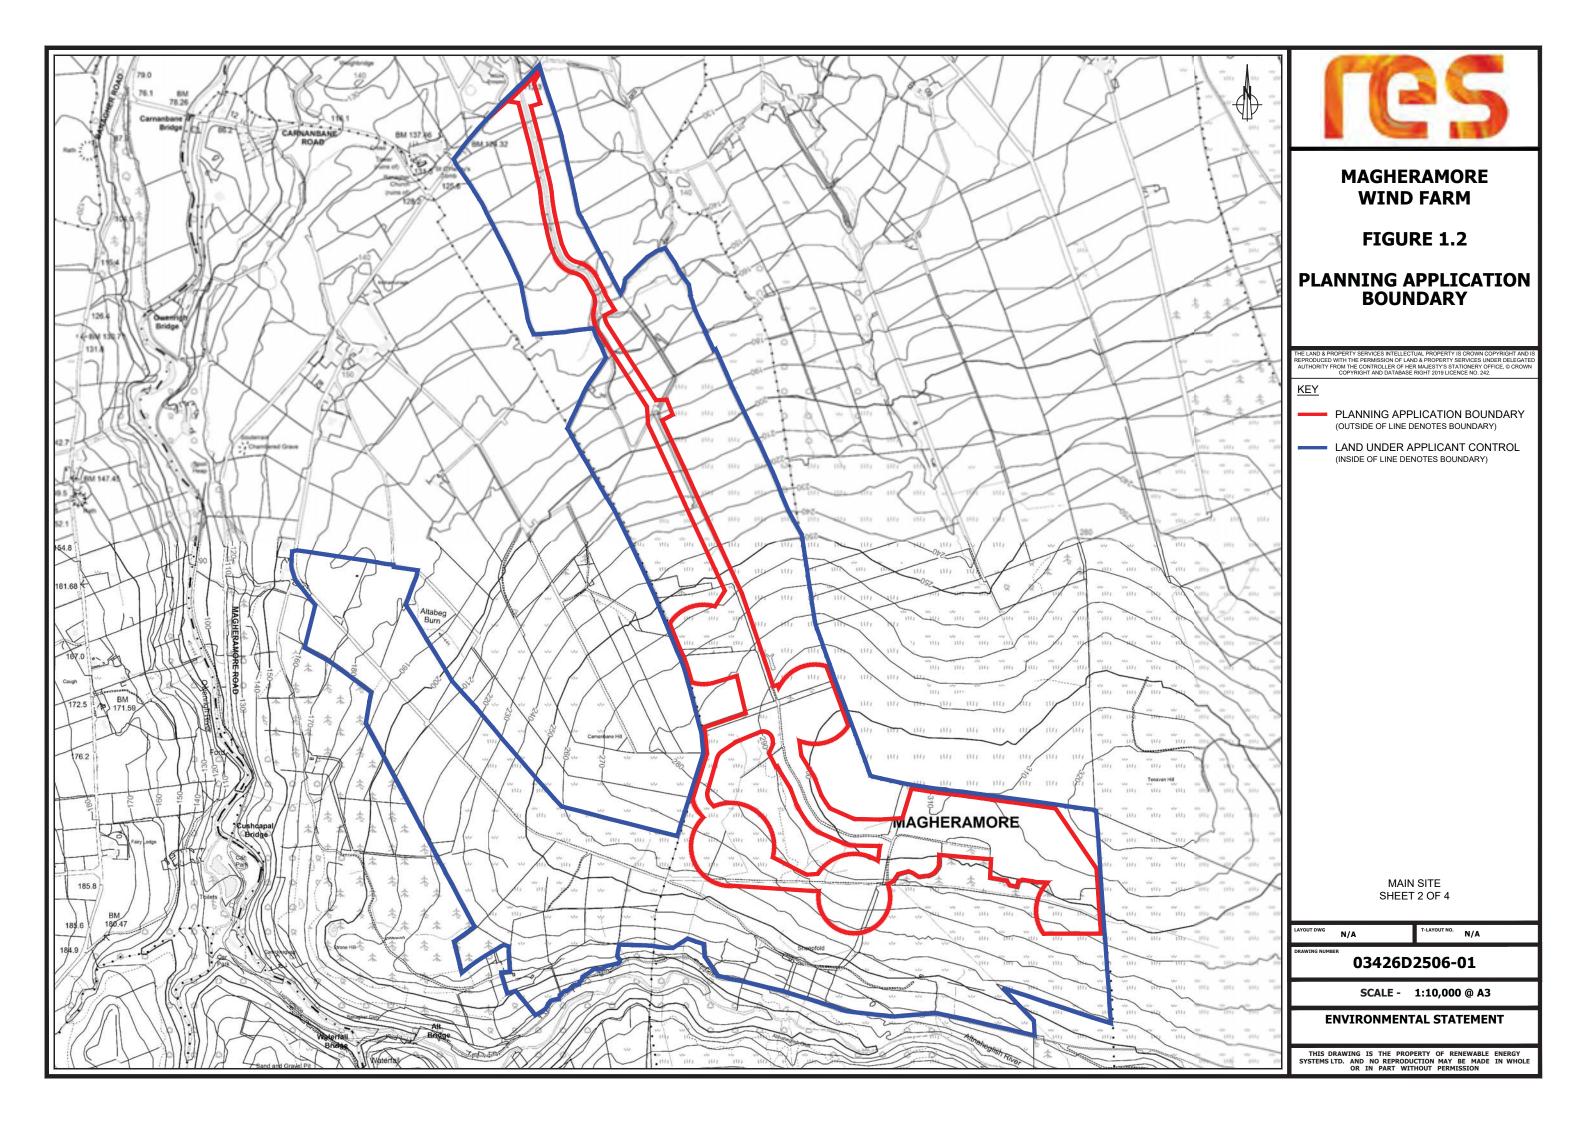
## **Table of Contents**

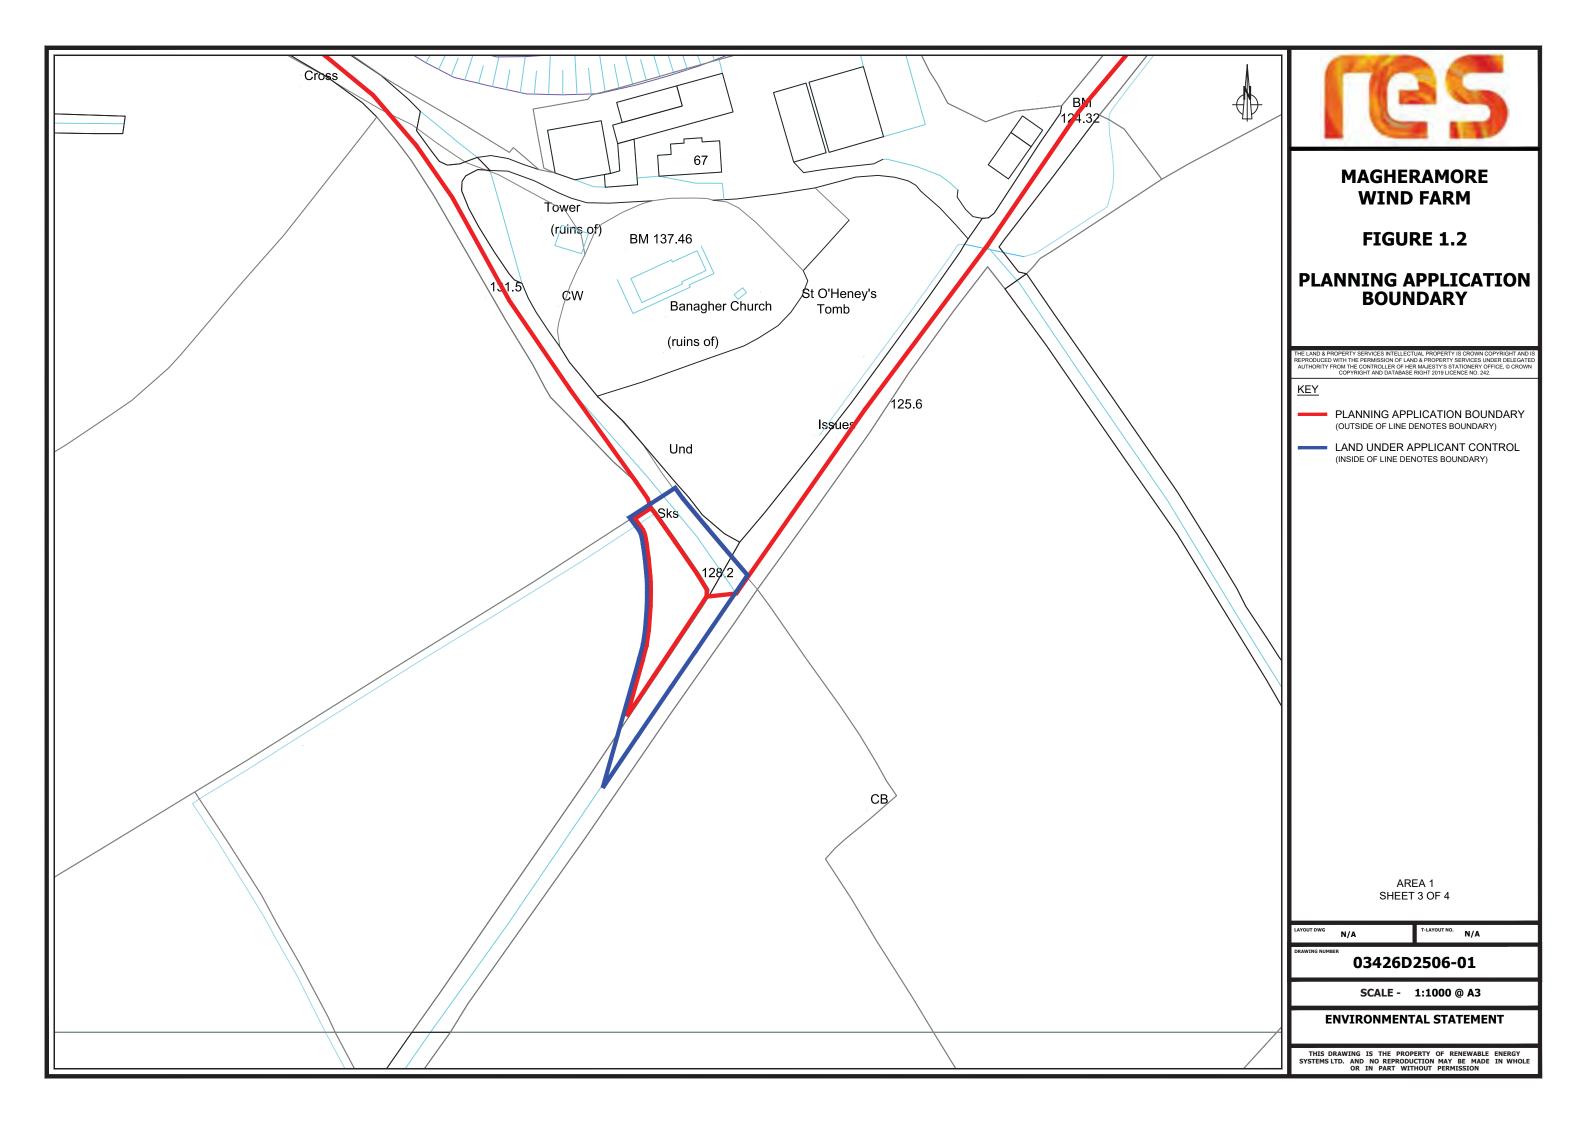
Chapter 1	Introduction & Policy Context
Chapter 2	Proposed Development
Chapter 3	Design Evolution & Alternatives
Chapter 4	Landscape & Visual
Chapter 5	Archaeology & Cultural Heritage
Chapter 6	Ecology
Chapter 7	Ornithology
Chapter 8	Fisheries
Chapter 9	<b>Geology &amp; Water Environment</b>
Chapter 10	Noise
Chapter 11	Traffic & Transport

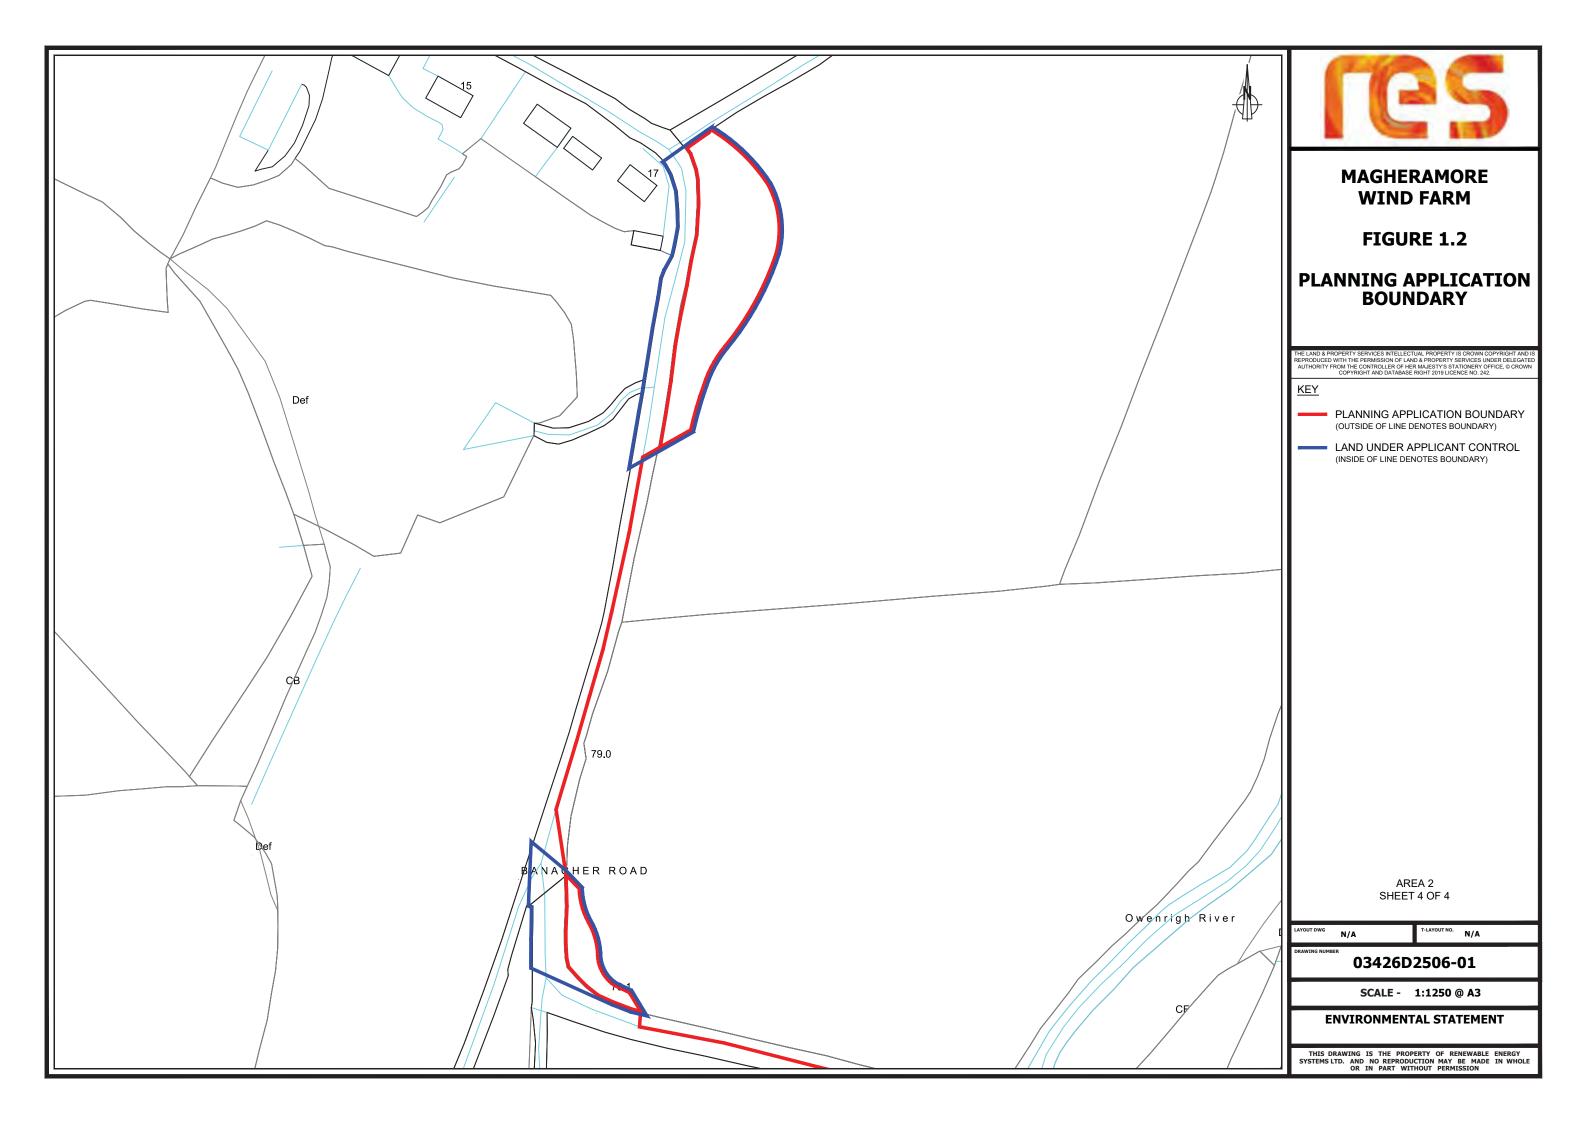
## Introduction & Policy Context













# Proposed Development

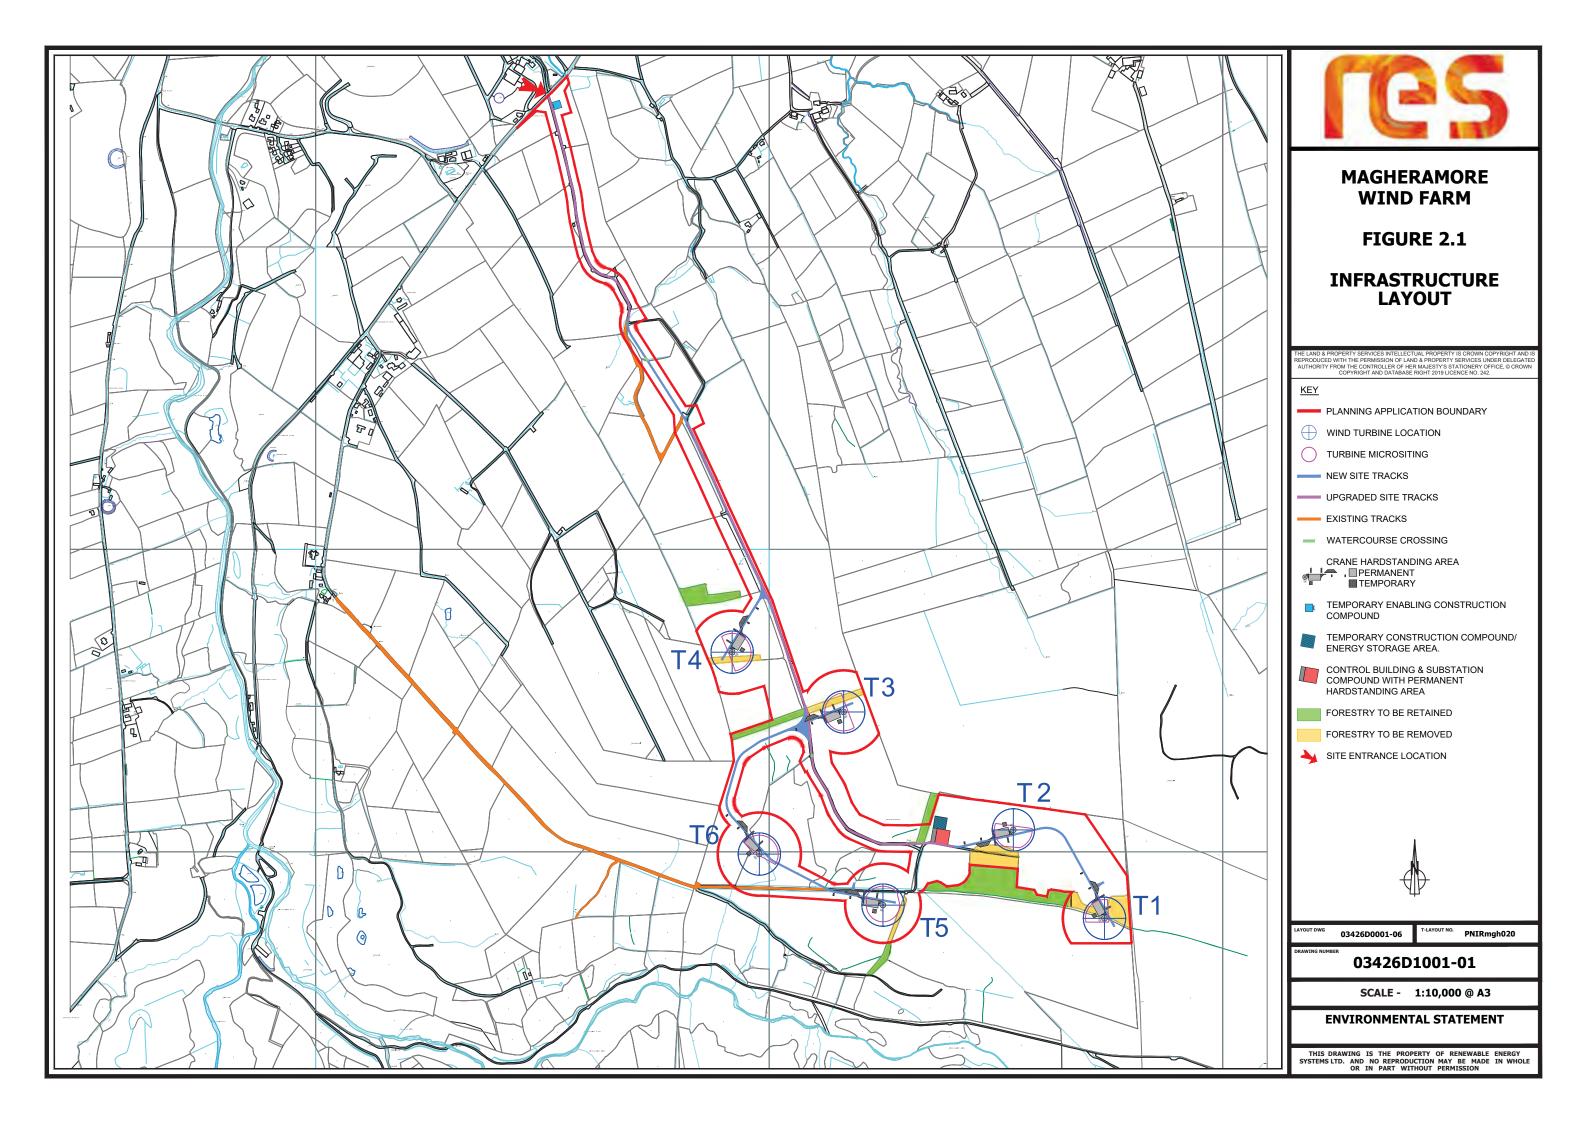

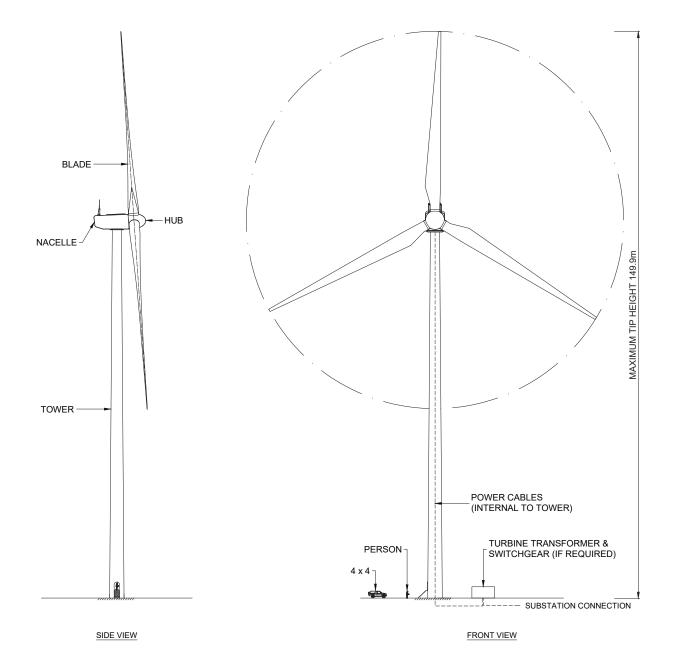



PHOTOGRAPH OF TYPICAL TURBINE



## MAGHERAMORE WIND FARM

FIGURE 2.2

**TURBINE ELEVATION** 

N/A

T-LAYOUT NO. N/A

DRAWING NUMBER

03426D2902-01

SCALE - 1:1000 @ A3

**ENVIRONMENTAL STATEMENT** 

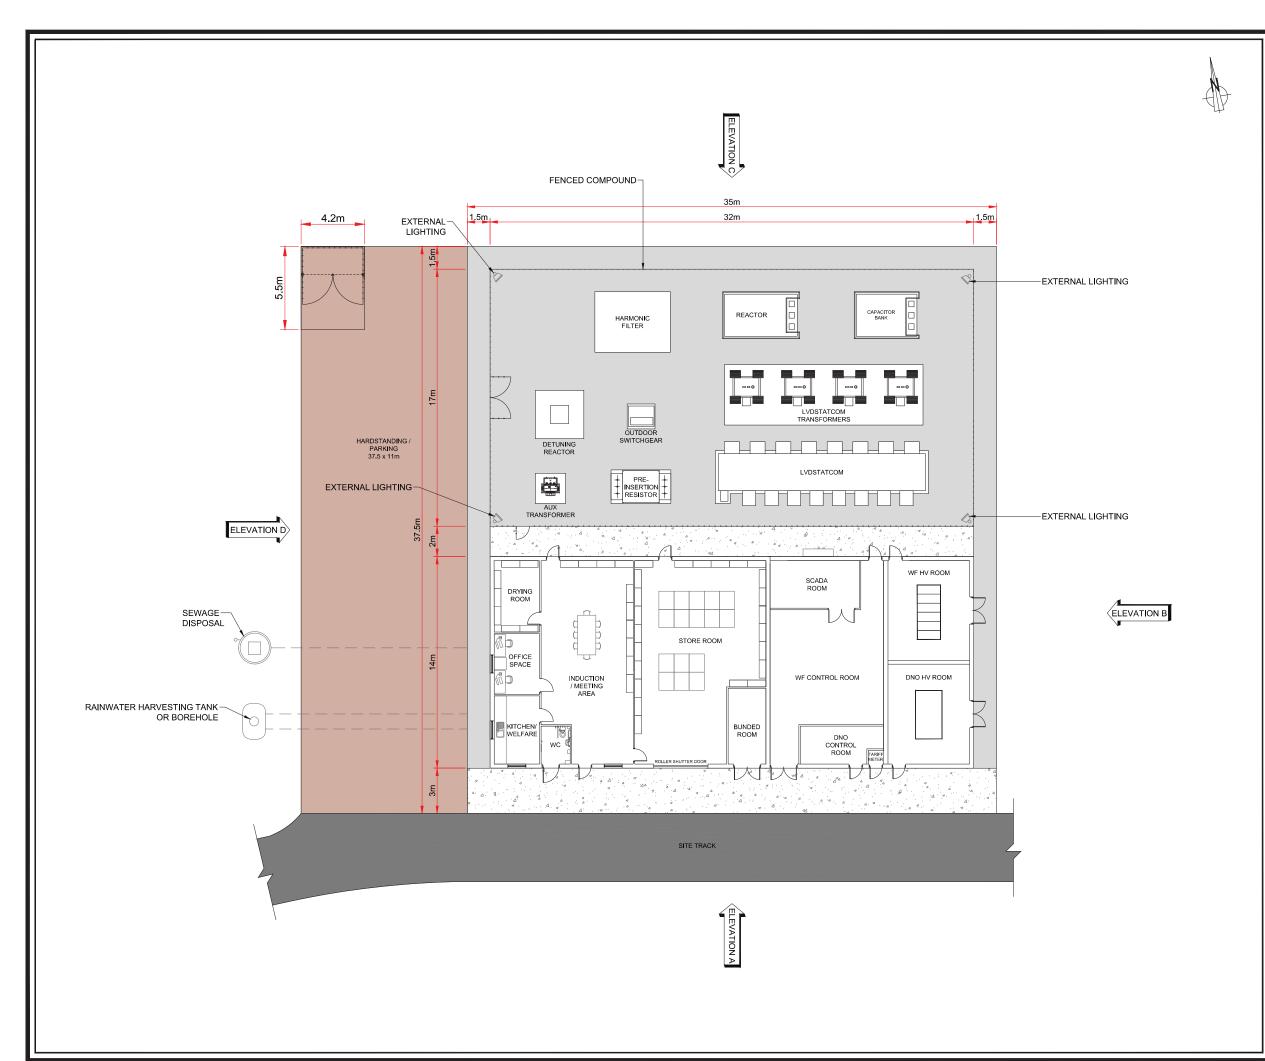




FIGURE 2.3

## CONTROL BUILDING & SUBSTATION COMPOUND LAYOUT PLAN

#### KEY:

--- INDICATIVE MV CABLE DUCTING LAYOUT

S EXTERNAL LIGHTING

1m WIDE GRAVEL PATH

CONCRETE APRON

ELEVATION MARKER

#### NOTES:

- FULL CONVERTOR SOLUTIONS ARE NOW REQUIRED FOR GRID CODE COMPLIANCE.
- 2. REACTORS ARE INCLUDED FOR BALANCING CABLE CAPACITIVE EXPORT
- 3. CONTROL BUILDING ROOM LAYOUT & COMPOUND LAYOUT IS INDICATIVE ONLY AND MAY CHANGE.
- I. STONED HARDSTAND AREA FOR CRANE DURING INSTALLATION PHASE AND PARKING DURING OPERATIONAL PHASE
- 5. ALL ELECTRICAL EQUIPMENT TO HAVE A MINIMUM SEPARATION OF 1m.

N/A

T-LAYOUT NO. N/A

DRAWING NUMB

03426D2203-01

SCALE - 1:250 @ A3

#### **ENVIRONMENTAL STATEMENT**

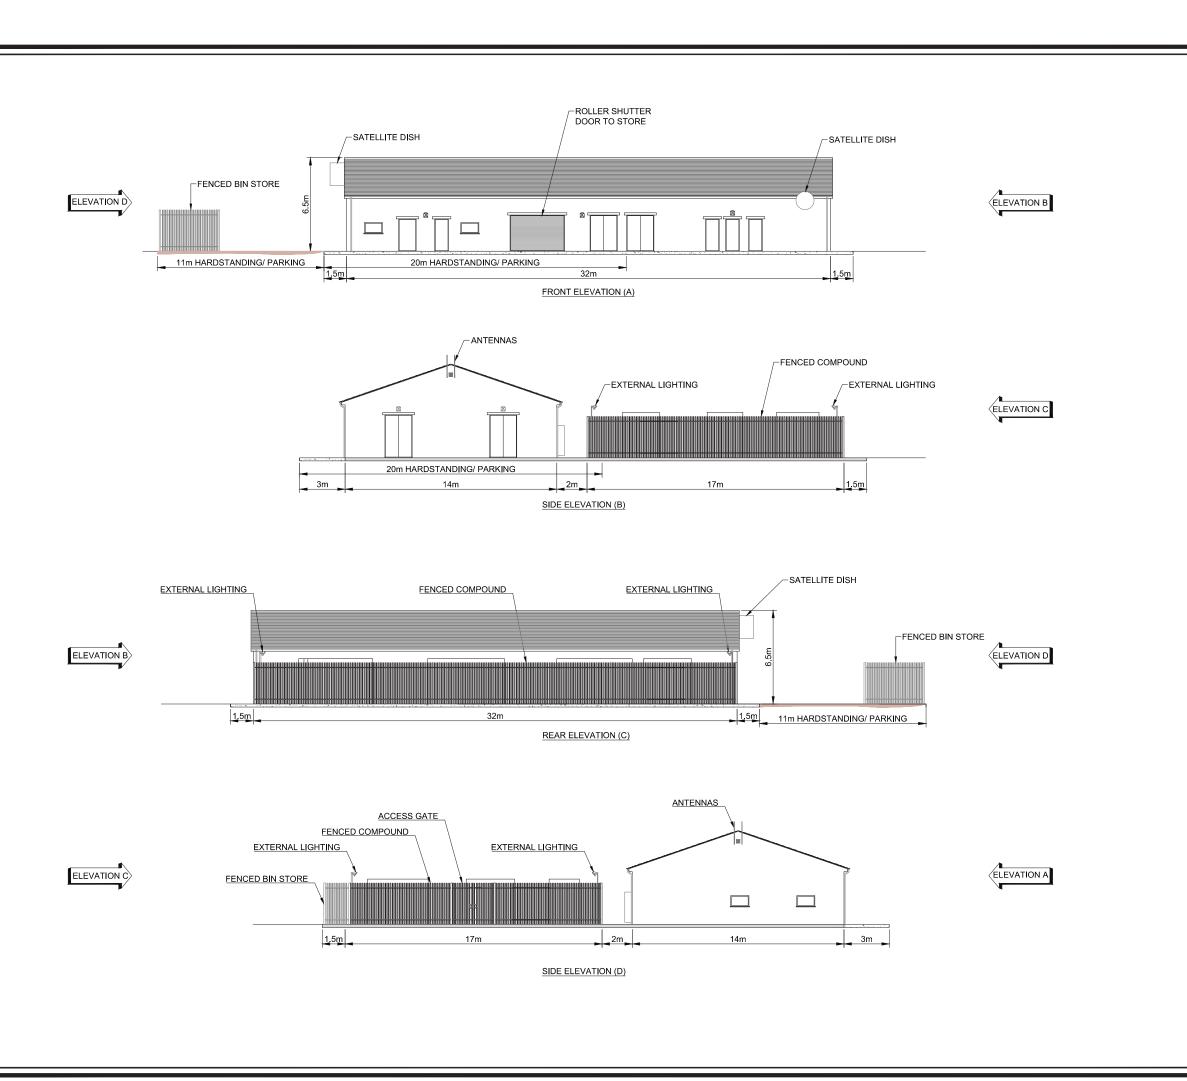




FIGURE 2.4

CONTROL BUILDING ELEVATIONS

N/A

T-LAYOUT NO. N/A

DRAWING NUMBER

03426D2204-01

SCALE - 1:250 @ A3

**ENVIRONMENTAL STATEMENT** 

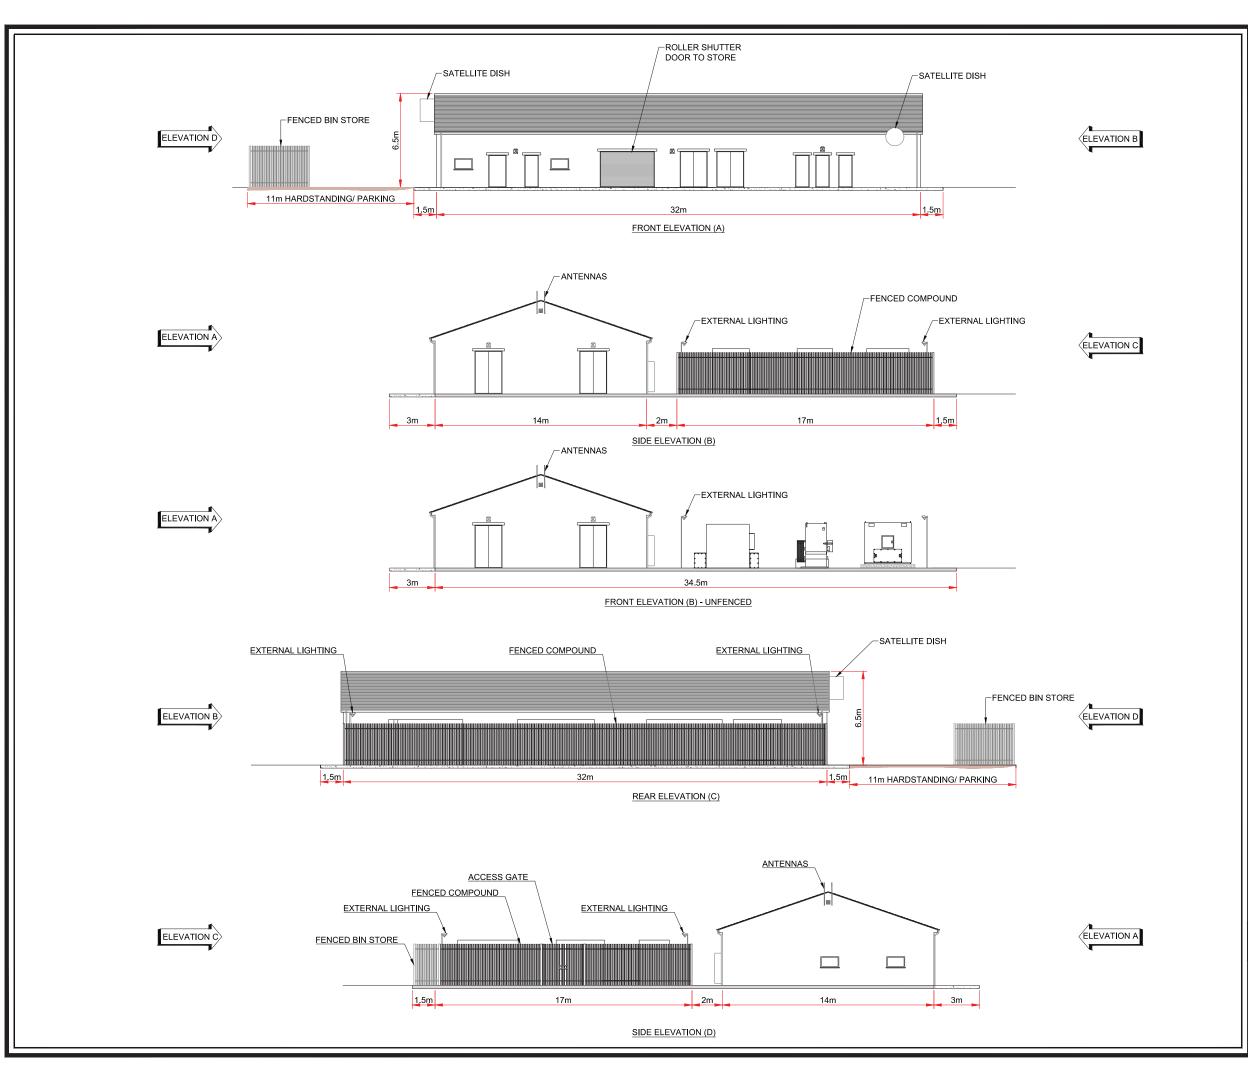




FIGURE 2.5

## CONTROL BUILDING & SUBSTATION COMPOUND ELEVATIONS

#### NOTE

1. REFER TO SHEETS 3 - 12 FOR INFORMATION ON INDICATIVE COMPOUND COMPONENTS.

COMPOUND ELEVATIONS
SHEET 1 OF 12

N/A

T-LAYOUT NO. N/A

DRAWING NUMBER

03426D2205-01

SCALE - 1:250 @ A3

#### **ENVIRONMENTAL STATEMENT**

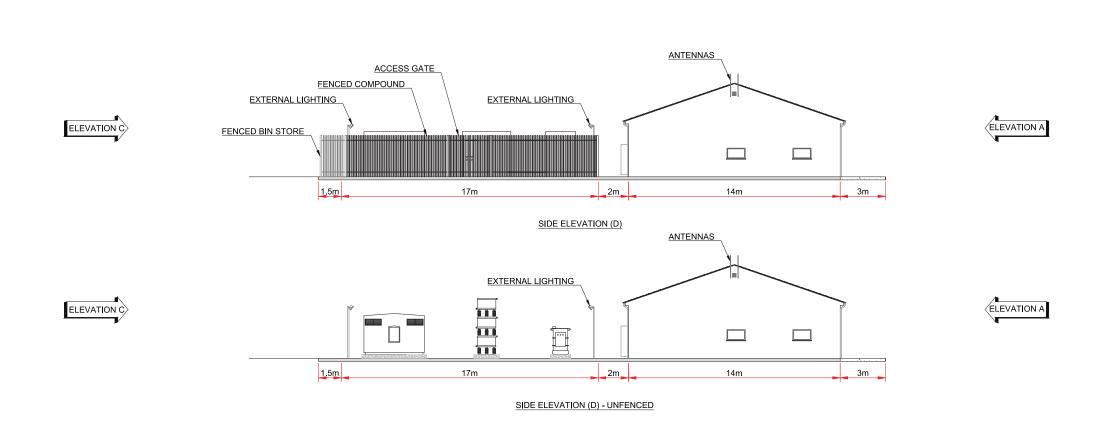




FIGURE 2.5

## CONTROL BUILDING & SUBSTATION COMPOUND ELEVATIONS

#### NOTE

- REFER TO SHEETS 3 12 FOR INFORMATION ON INDICATIVE COMPOUND COMPONENTS.
- WARNING SIGNAGE TO COMPLY WITH RELEVANT H&S LEGISLATION; TO BE BE DISPLAYED ON FENCE ENTRANCE.

COMPOUND ELEVATIONS
SHEET 2 OF 12

YOUT DWG N/A

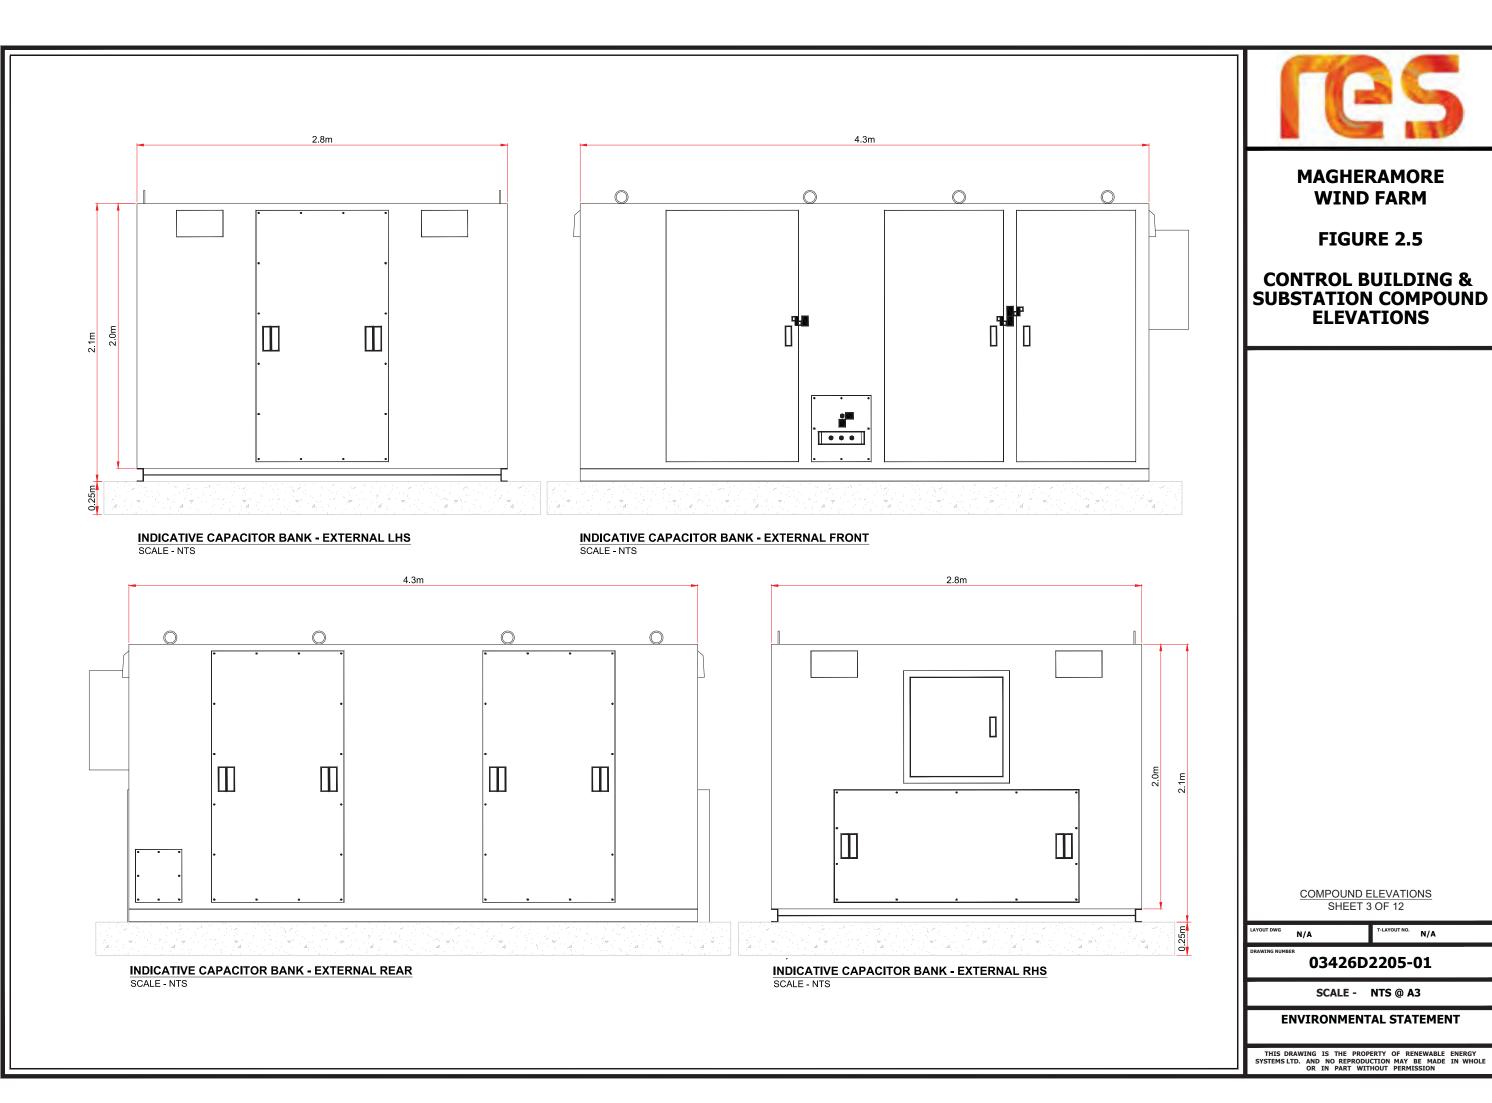
T-LAYOUT NO.

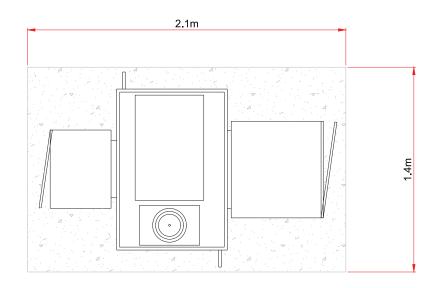
DRAWING NUMBER

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SCALE - 1:250 @ A3


**ENVIRONMENTAL STATEMENT** 






#### INDICATIVE AUXILIARY TRANSFORMER - PLAN VIEW

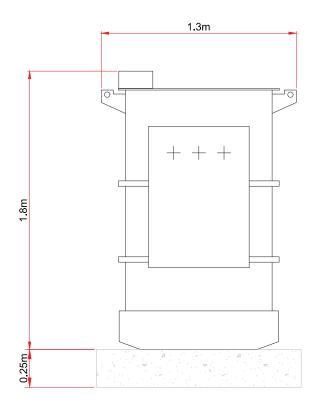SCALE - 1:25



## INDICATIVE AUXILIARY TRANSFORMER - SIDE ELEVATION

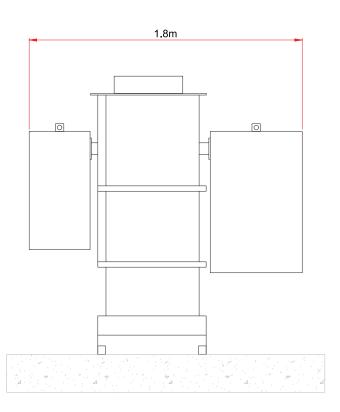SCALE - 1:25



#### INDICATIVE AUXILIARY TRANSFORMER - FRONT ELEVATION

SCALE - 1:25



## MAGHERAMORE WIND FARM

FIGURE 2.5

CONTROL BUILDING & SUBSTATION COMPOUND ELEVATIONS

COMPOUND ELEVATIONS
SHEET 4 OF 12

N/A

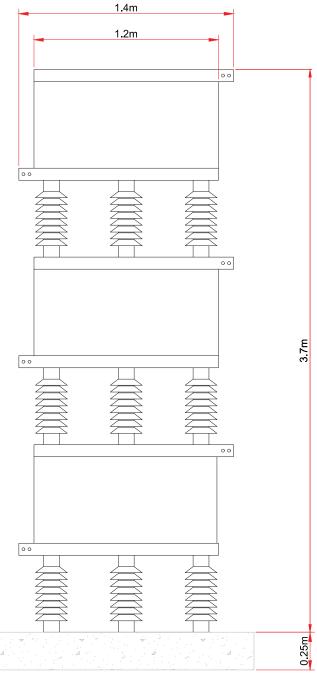
T-LAYOUT NO. N/A

DRAWING NUMBER

03426D2205-01


SCALE - 1:25 @ A3

#### **ENVIRONMENTAL STATEMENT**



INDICATIVE DETUNING REACTOR - SIDE ELEVATION

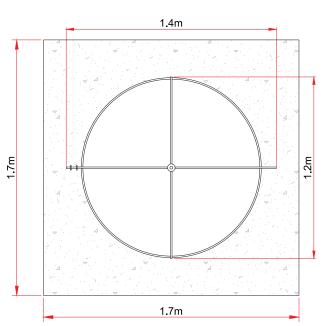SCALE - 1:25



INDICATIVE DETUNING REACTOR - SIDE ELEVATION

SCALE - 1:25



## MAGHERAMORE WIND FARM

FIGURE 2.5

CONTROL BUILDING & SUBSTATION COMPOUND ELEVATIONS

COMPOUND ELEVATIONS
SHEET 5 OF 12

AYOUT DWG N/A

T-LAYOUT NO. N/A

DRAWING NUMBER

03426D2205-01

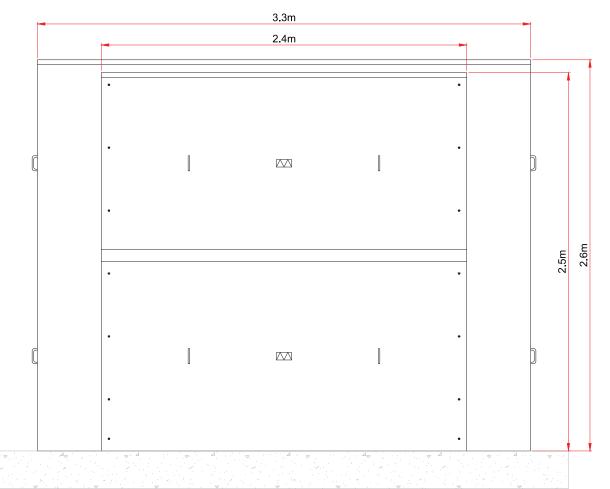
SCALE - 1:25 @ A3

**ENVIRONMENTAL STATEMENT** 

# 


#### INDICATIVE PRE-INSERTION RESISTOR - PLAN VIEW

SCALE - 1:25



#### INDICATIVE PRE-INSERTION RESISTOR - FRONT ELEVATION

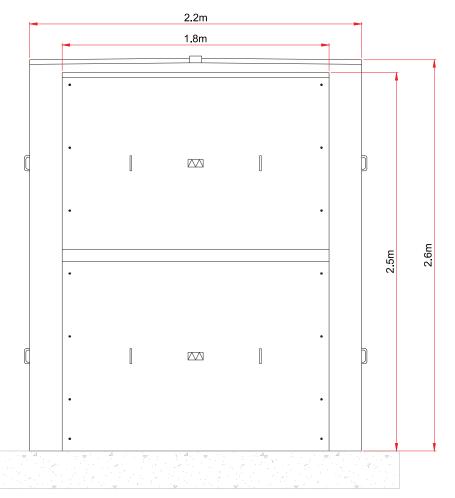SCALE - 1:25



INDICATIVE PRE-INSERTION RESISTOR - SIDE ELEVATION

SCALE - 1:25



## MAGHERAMORE WIND FARM

FIGURE 2.5

CONTROL BUILDING & SUBSTATION COMPOUND ELEVATIONS

COMPOUND ELEVATIONS
SHEET 6 OF 12

N/A

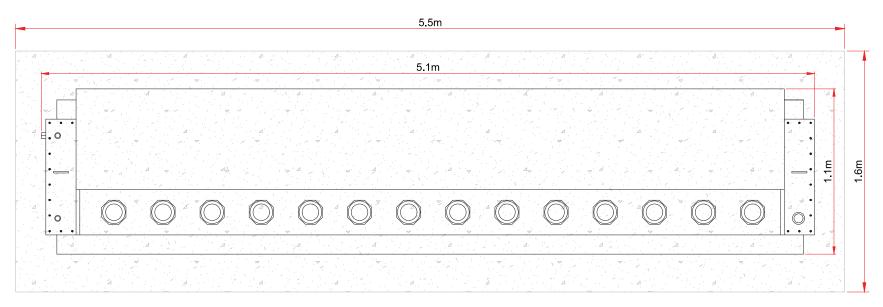
T-LAYOUT NO. N/A

DRAWING NUMBER

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SCALE - 1:25 @ A3


#### **ENVIRONMENTAL STATEMENT**



**INDICATIVE SHUNT REACTOR -**


**PLAN VIEW** 

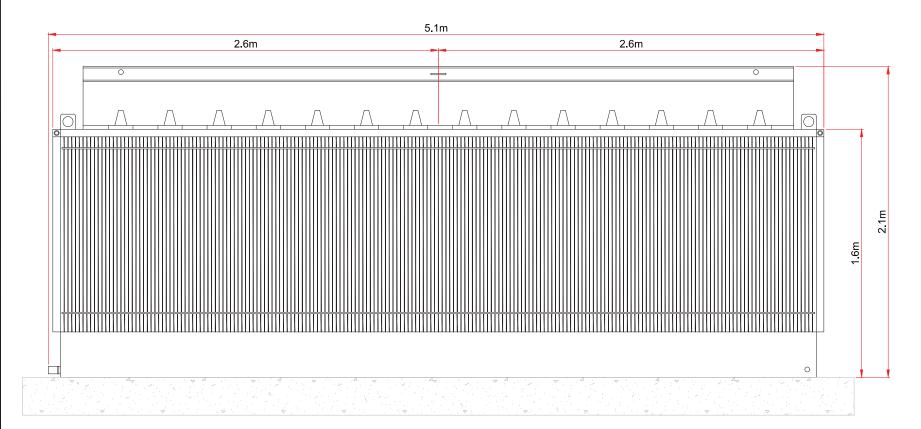SCALE - 1:25



**INDICATIVE SHUNT REACTOR -**FRONT ELEVATION

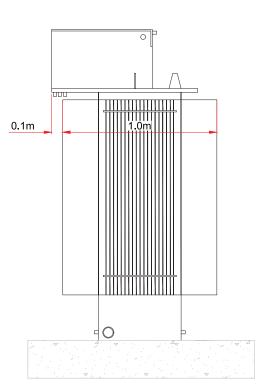SCALE - 1:25



**INDICATIVE SHUNT REACTOR -**SIDE ELEVATION

SCALE - 1:25



**MAGHERAMORE WIND FARM** 

FIGURE 2.5

**CONTROL BUILDING & SUBSTATION COMPOUND ELEVATIONS** 

> COMPOUND ELEVATIONS SHEET 7 OF 12

N/A

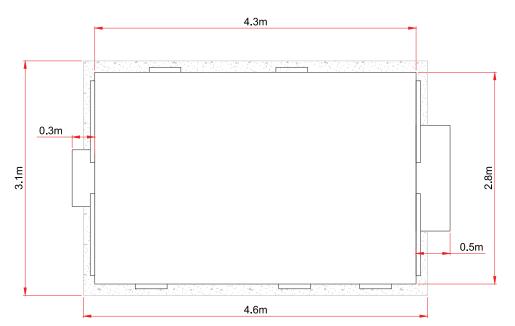
r-LAYOUT NO. N/A

03426D2205-01

SCALE - 1:25 @ A3

**ENVIRONMENTAL STATEMENT** 

# 0.3m 4.3m 0.5m WE:1 WE:1 WE:0





#### INDICATIVE HARMONIC FILTER - FRONT ELEVATION

SCALE - 1:50

#### INDICATIVE HARMONIC FILTER - PLAN VIEW

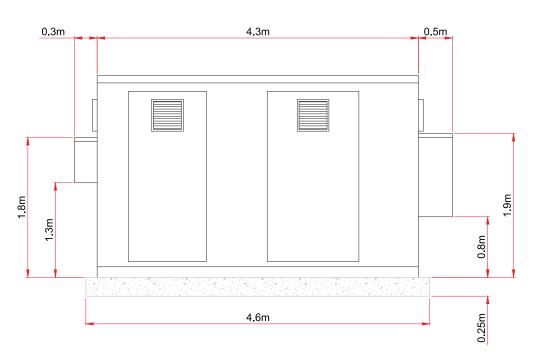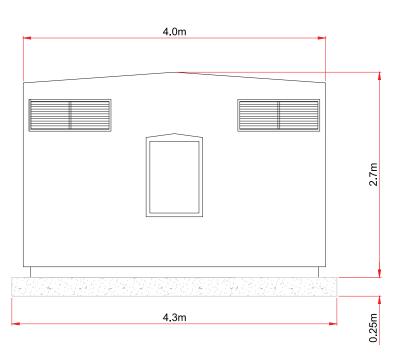SCALE - 1:50





#### INDICATIVE HARMONIC FILTER - REAR ELEVATION

SCALE - 1:50

INDICATIVE HARMONIC FILTER - SIDE ELEVATION

SCALE - 1:50

# res

## MAGHERAMORE WIND FARM

FIGURE 2.5

CONTROL BUILDING & SUBSTATION COMPOUND ELEVATIONS

COMPOUND ELEVATIONS
SHEET 8 OF 12

YOUT DWG N/A

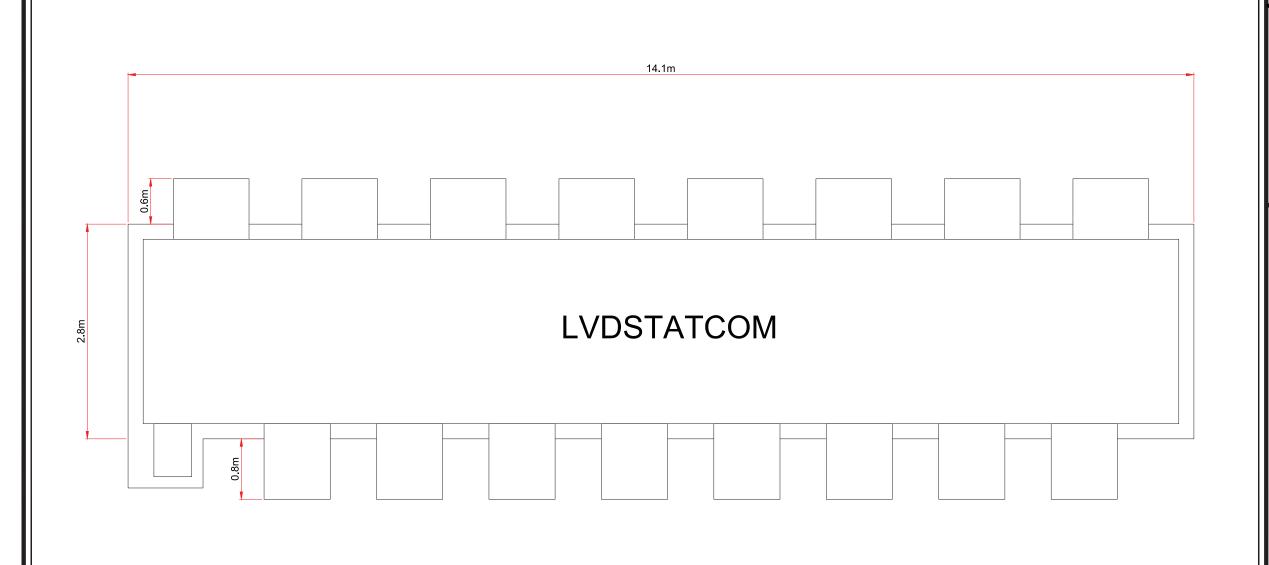
T-LAYOUT NO. N/A

DRAWING NUMBER

03426D2205-01

SCALE - 1:50 @ A3

**ENVIRONMENTAL STATEMENT** 



**INDICATIVE LVDSTATCOM -**

PLAN VIEW SCALE - 1:25



## MAGHERAMORE WIND FARM

FIGURE 2.5

CONTROL BUILDING & SUBSTATION COMPOUND ELEVATIONS

COMPOUND ELEVATIONS
SHEET 9 OF 12

N,

T-LAYOUT NO. N/A

DRAWING NUMBER

03426D2205-01

SCALE - 1:25 @ A3

**ENVIRONMENTAL STATEMENT** 

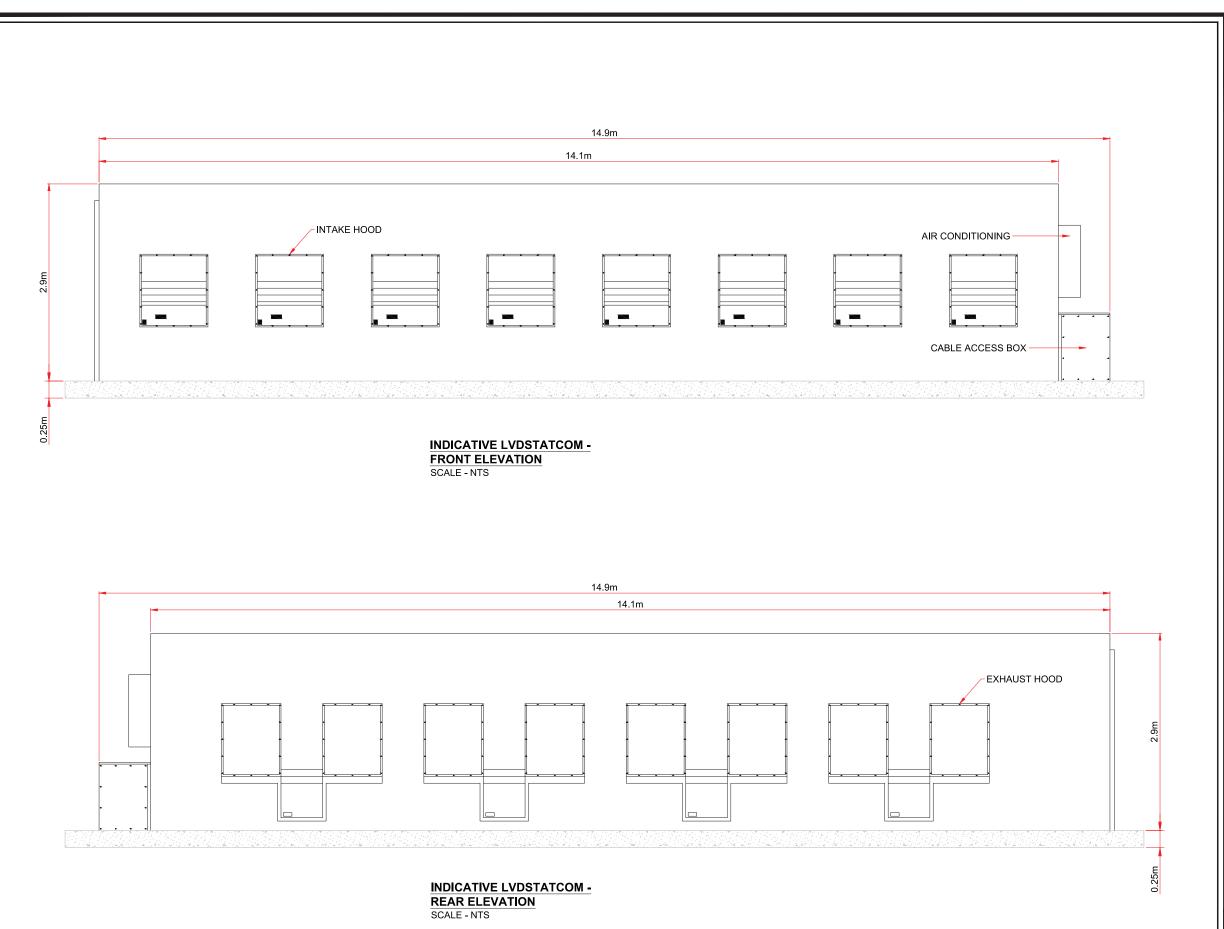




FIGURE 2.5

CONTROL BUILDING & SUBSTATION COMPOUND ELEVATIONS

COMPOUND ELEVATIONS
SHEET 10 OF 12

N/A


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DRAWING NUMBER
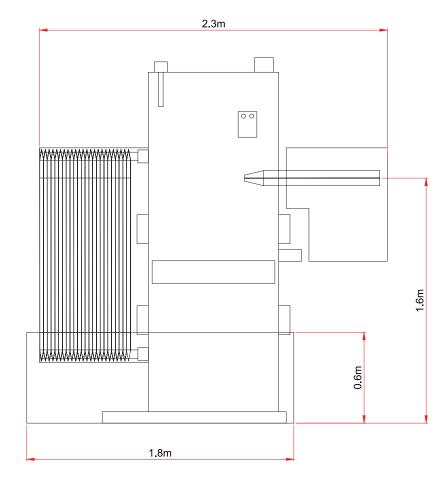
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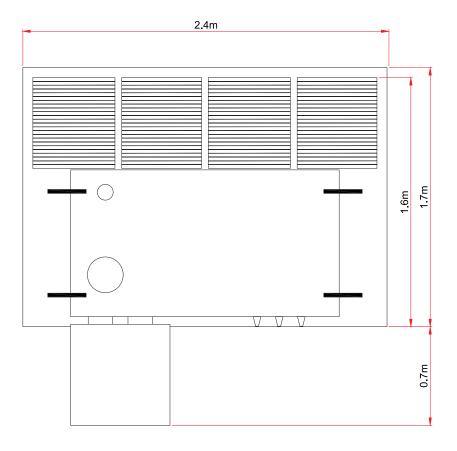
SCALE - NTS @ A3

**ENVIRONMENTAL STATEMENT** 



INDICATIVE LVDSTATCOM TRANSFORMER - SIDE ELEVATION

SCALE - 1:25



 $\frac{\textbf{INDICATIVE LVDSTATCOM TRANSFORMER-}}{\textbf{PLAN VIEW}}$ 

SCALE - 1:25



## MAGHERAMORE WIND FARM

FIGURE 2.5

CONTROL BUILDING & SUBSTATION COMPOUND ELEVATIONS

COMPOUND ELEVATIONS
SHEET 11 OF 12

N/A

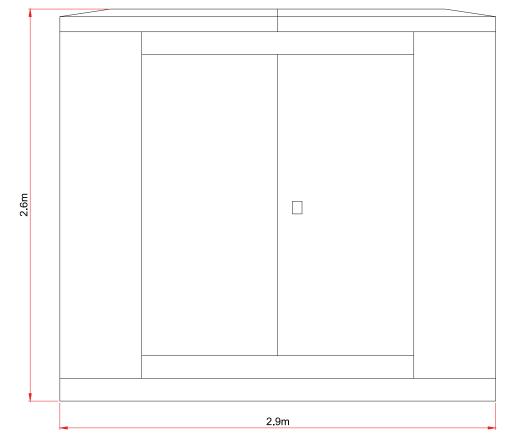
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RAWING NUMBER

03426D2205-01


SCALE - 1:25 @ A3

**ENVIRONMENTAL STATEMENT** 



#### INDICATIVE OUTDOOR SWITCHGEAR - SIDE ELEVATION

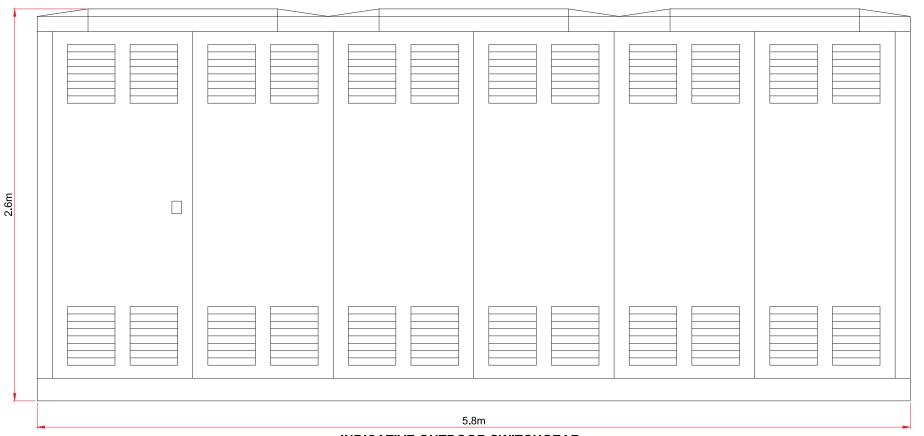SCALE - 1:25



INDICATIVE OUTDOOR SWITCHGEAR - FRONT ELEVATION

SCALE - 1:25



## MAGHERAMORE WIND FARM

FIGURE 2.5

CONTROL BUILDING & SUBSTATION COMPOUND ELEVATIONS

COMPOUND ELEVATIONS
SHEET 12 OF 12

LAYOUT DWG N/A

T-LAYOUT NO. N/A

DRAWING NUMB

03426D2205-01

SCALE - 1:25 @ A3

**ENVIRONMENTAL STATEMENT** 


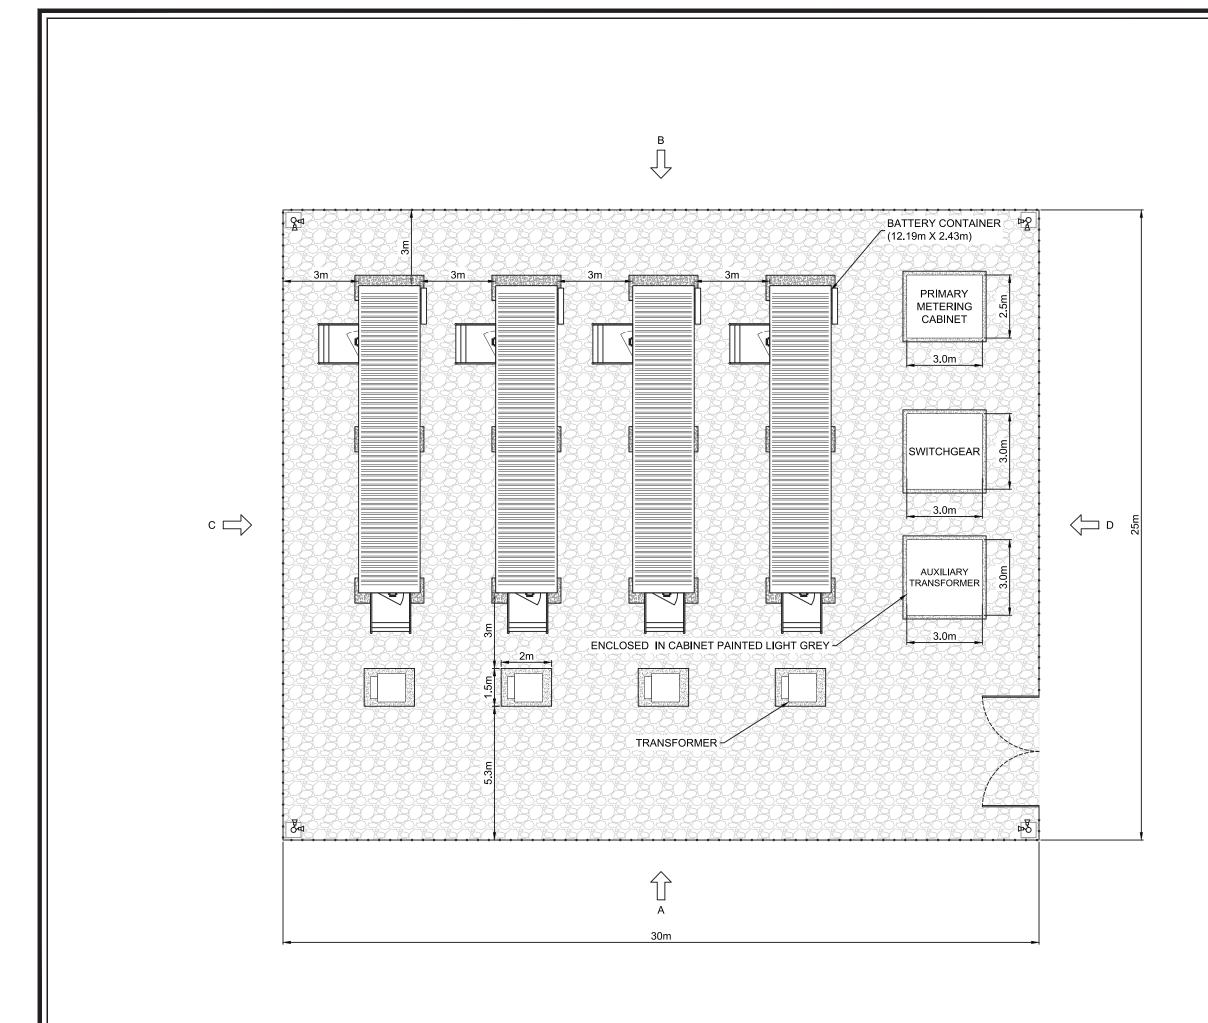




FIGURE 2.6

#### ENERGY STORAGE COMPOUND **PLAN & ELEVATION** (SHEET 1 OF 3) **LAYOUT PLAN**

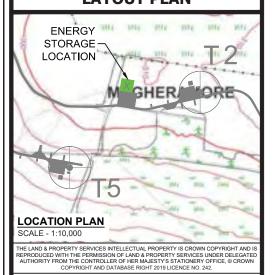

INFRASTRUCTURE

18-25mm GRADE, 150mm DEEP, CLEAN CRUSHED ROCK

→ PALISADE FENCE 2.4m HIGH

MAX. 4.5m HIGH 50W HALIDE LAMP OR SIMILAR. COLUMNS SHALL BE TELESCOPIC, HINGED OR SIMILAR TO FACILITATE GROUND LEVEL BULB REPLACEMENT. EXACT POSITIONS TBC BASED ON SELECTED PRODUCT(S).

■ ENERGY STORAGE LOCATION

1. ALL DIMENSIONS ARE MAXIMUM ANTICIPATED AND SUBJECT TO DETAILED DESIGN.

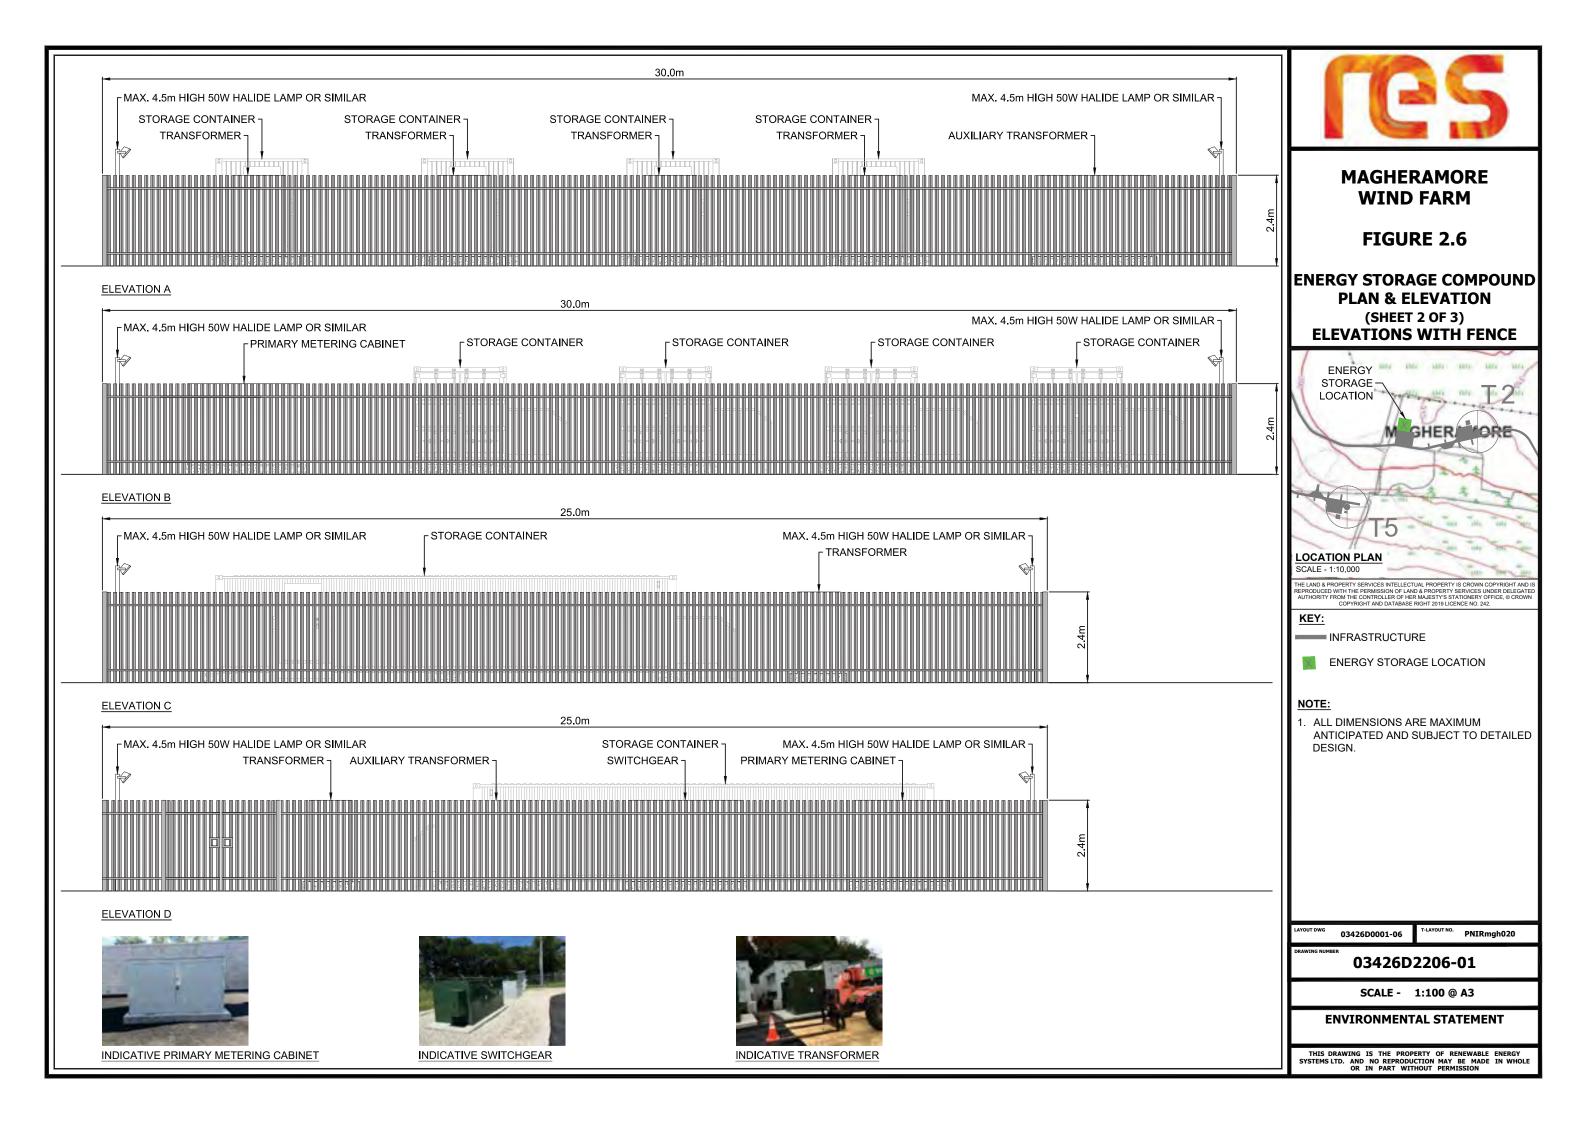
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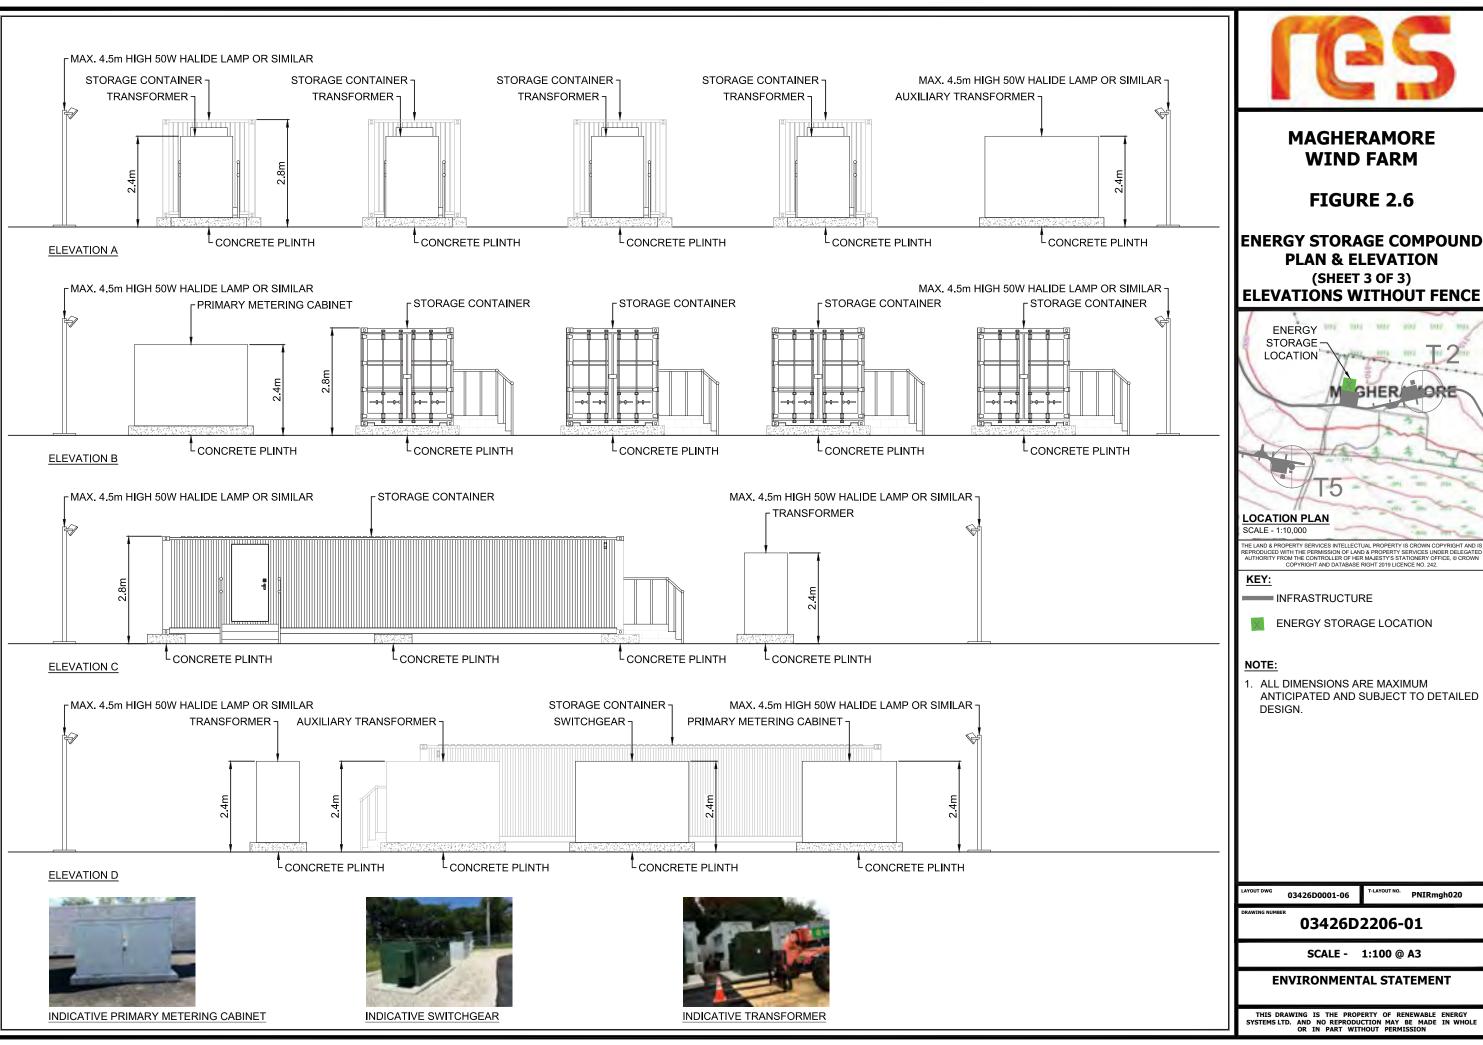
PNIRmgh020

03426D2206-01

SCALE - 1:150 @ A3


#### **ENVIRONMENTAL STATEMENT**







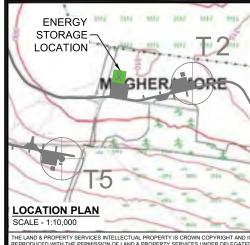
ENERGY STORAGE COMPOUND **PLAN & ELEVATION** 



ANTICIPATED AND SUBJECT TO DETAILED

AYOUT NO. PNIRmgh020

**ENVIRONMENTAL STATEMENT** 

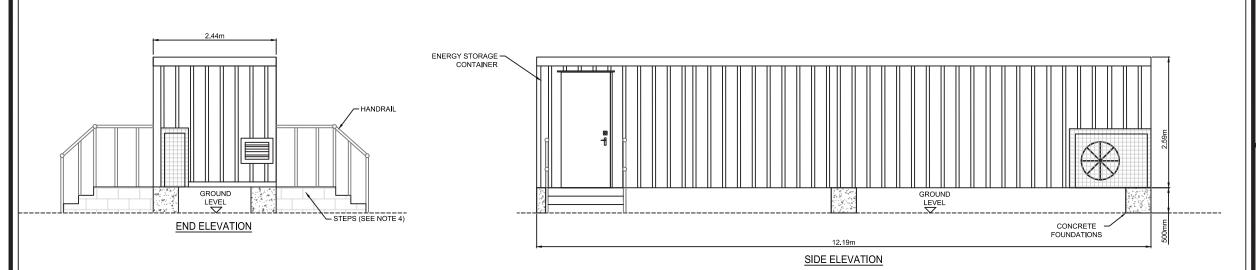





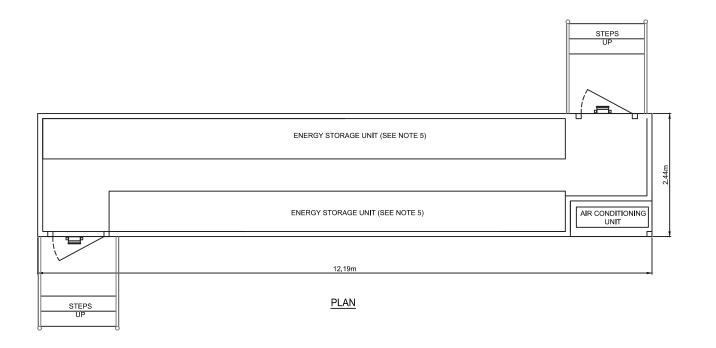




FIGURE 2.7

#### TYPICAL ENERGY STORAGE CONTAINER ELEVATION

#### NOTES:

- . ALL DIMENSIONS ARE MAXIMUM ANTICIPATED AND SUBJECT TO DETAILED DESIGN
- DOOR AND STEPS POSITIONS ARE INDICATIVE AND SUBJECT TO DETAILED DESIGN.
- APPROXIMATE FINISHED FLOOR LEVEL 500mm ABOVE EXISTING GROUND LEVEL.
- 4. STEPS TO BE EITHER CONSTRUCTED ON SITE FROM MASS CONCRETE OR MASONRY BLOCKS OR PREFABRICATED OFF SITE AND INSTALLED ON SITE FOLLOWING POSITIONING OF THE STORAGE UNIT.
- 5. THE LOCATION AND SIZE OF ENERGY STORAGE UNIT WITHIN THE CONTAINER TO BE DETERMINED AT DETAILED DESIGN STAGE.
- 5. EXTERNAL COLOUR OF ENERGY STORAGE UNIT TO BE AGREED WITH PLANNING AUTHORITY

#### KFY



PASSIVE INFRARED LIGHTING (PLAN)

PASSIVE INFRARED LIGHTING (ELEVATION)

N/A

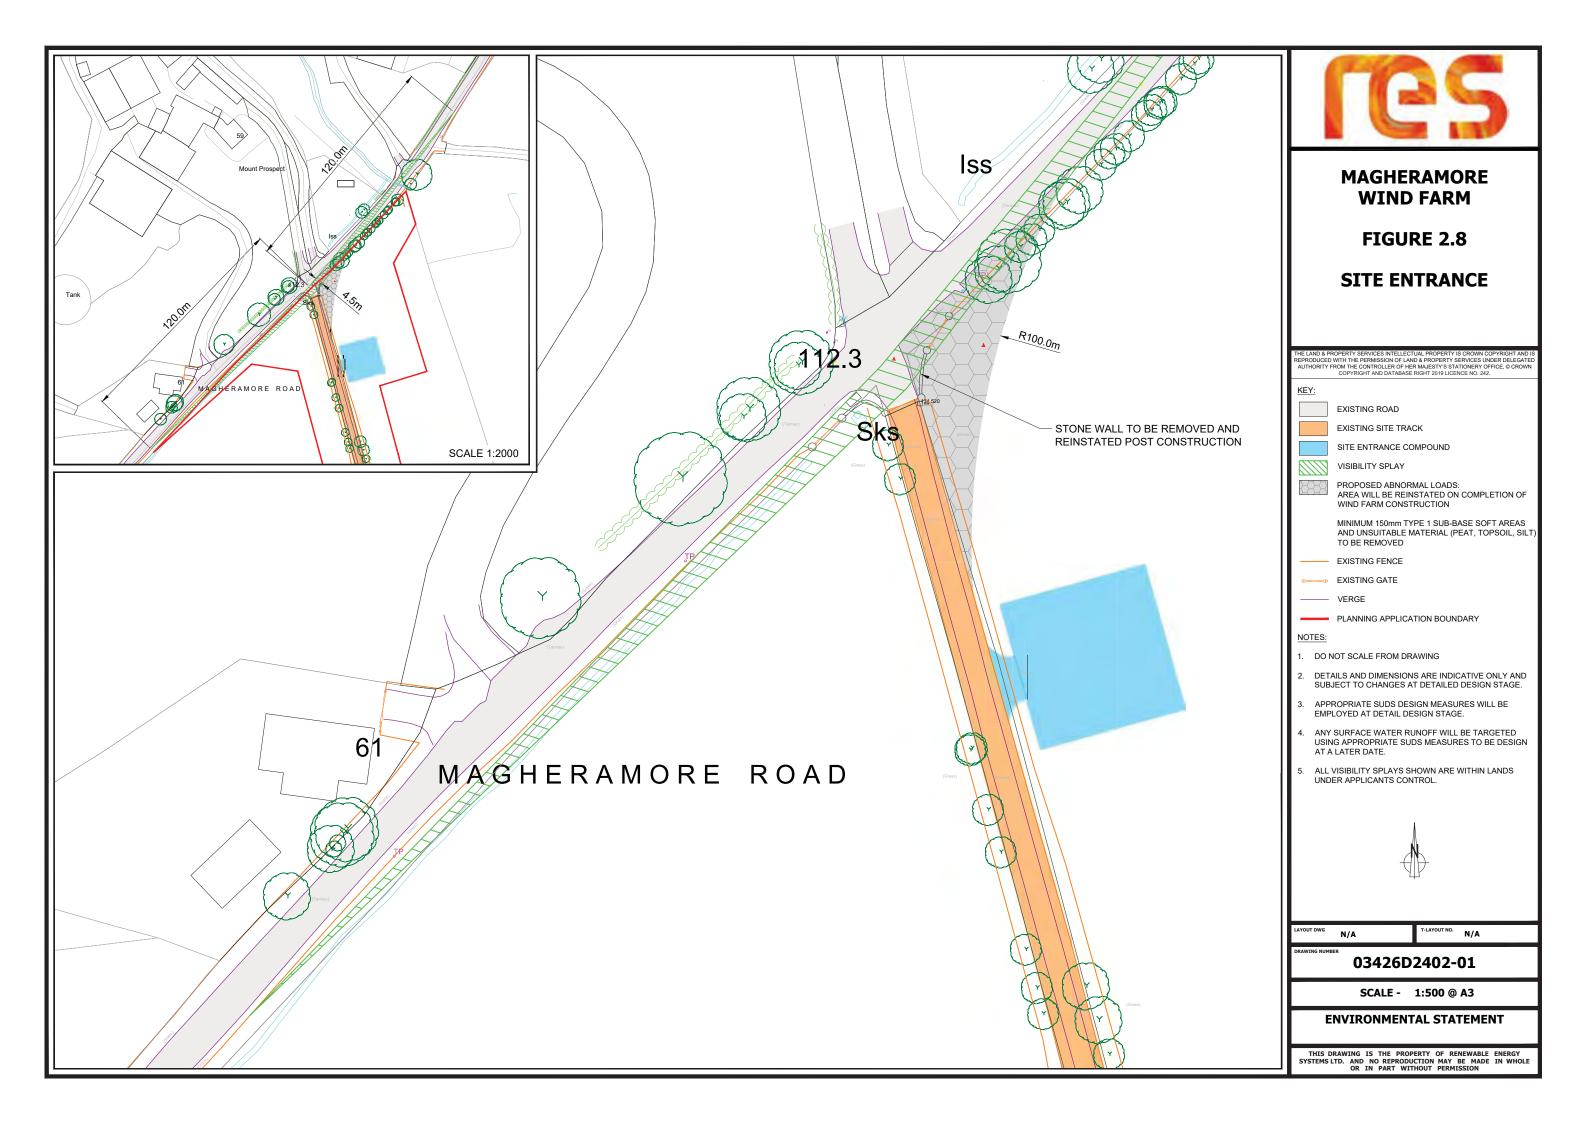
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DRAWING NUMBER


03426D2207-01

SCALE - 1:75 @ A3

#### **ENVIRONMENTAL STATEMENT**



#### KEY: RUNNING SURFACE BASE/CAPPING LAYER TOPSOIL **SUBGRADE** PEAT LAYER/SOFT GROUND ---- GEOGRID EXISTING GROUND LEVEL SNOW POLES (WHERE REQUIRED) **RUNNING WIDTH** SHOULDER-SHOULDER DRAINAGE SWALE DRAINAGE SWALE SOIL STORAGE BUND CABLE TRENCH-(SEE NOTE 4) TYPICAL TRACK SECTION

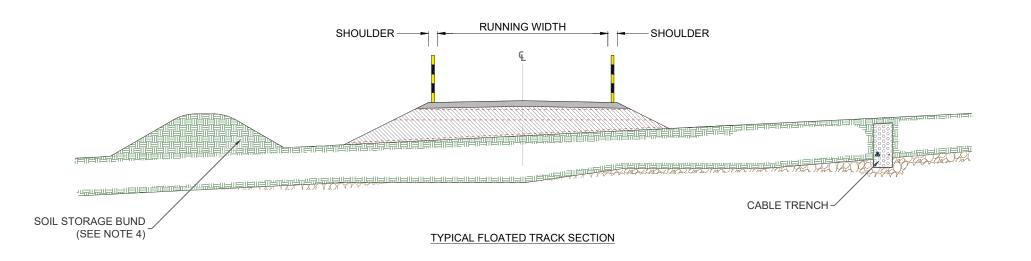



## MAGHERAMORE WIND FARM

FIGURE 2.9

ACCESS TRACK
TYPICAL DETAILS

#### NOTES:

- 1. DO NOT SCALE FROM THIS DRAWING.
- 2. TRACK WIDTH TO INCREASE ON BENDS AND PASSING PLACES.
- 3. ALL EMBANKMENT SLOPES TO BE PROVIDED AT A STABLE ANGLE BASED ON THE PROPERTIES OF THE MATERIAL ENCOUNTERED ON SITE.
- EXCAVATED MATERIAL WILL BE PLACED IN AGREED LOCATIONS. REINSTATEMENT AND/OR SPOIL MANAGEMENT PLANS WILL BE DEVELOPED IN LINE WITH CURRENT BEST PRACTICE.
- 5. TRACK CONSTRUCTION TYPE TO BE DETERMINED DURING DETAILED DESIGN. LAYOUT OF DRAINAGE, CABLE TRENCHES AND STORAGE BUNDS MAY VARY.
- 6. RUNNING SURFACE AND BASE/CAPPING LAYER TO BE FORMED FROM SUITABLE MATERIALS COMPACTED IN LAYERS.
- 7. GEOSYNTHETIC REINFORCEMENT OR SOIL STABILISATION MAY BE USED TO REDUCE THE DEPTH OF TRACK CONSTRUCTION. REQUIREMENT TO BE DETERMINED DURING DETAILED DESIGN.

N/A


T-LAYOUT NO. N/A

DRAWING NUMBER

03426D2302-01

SCALE - NOT TO SCALE

**ENVIRONMENTAL STATEMENT** 

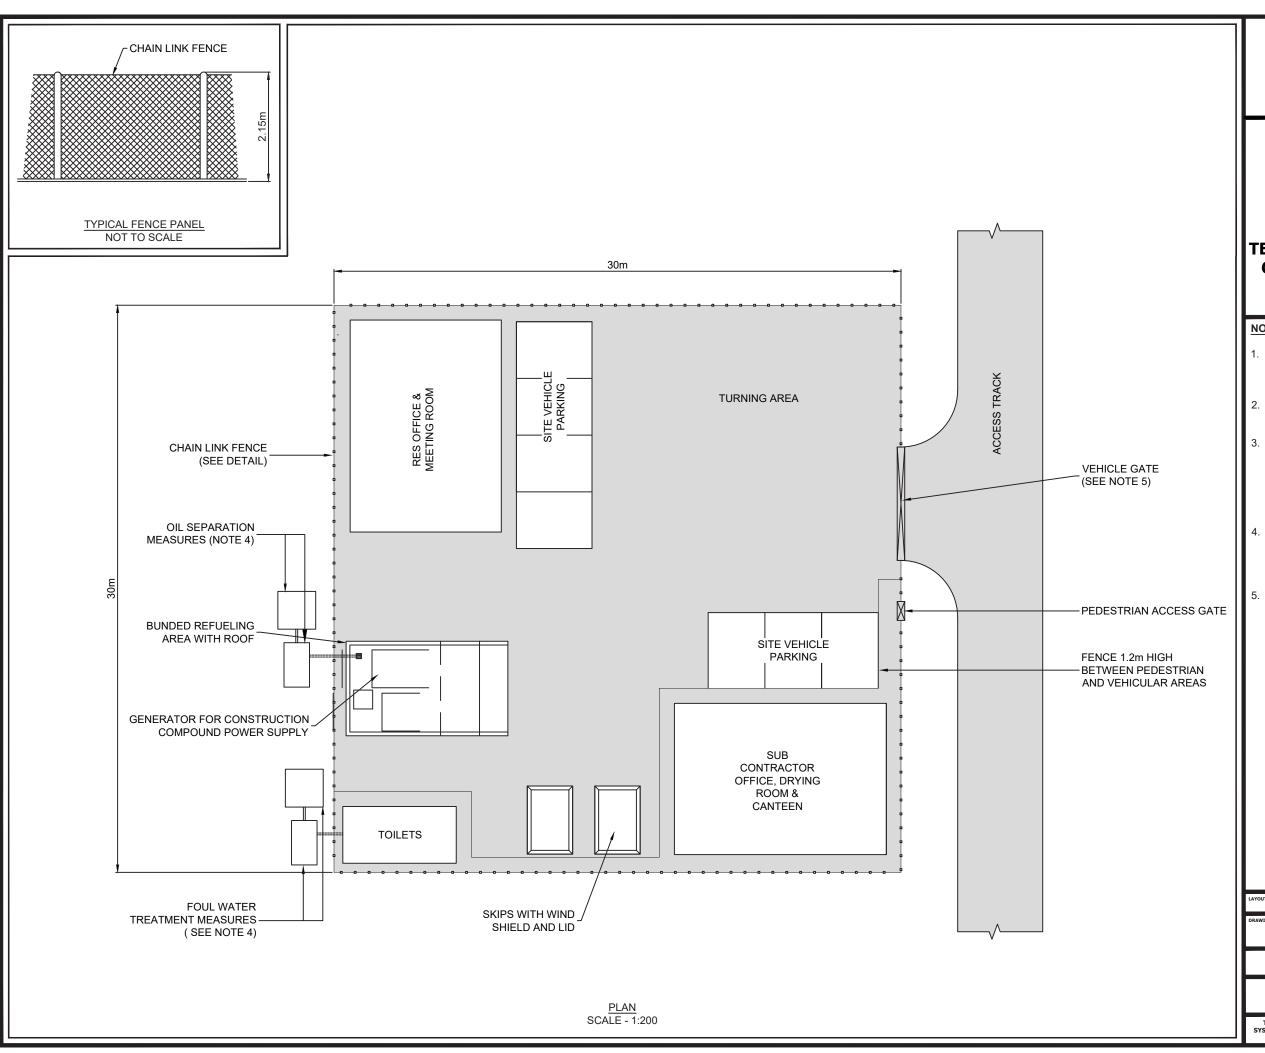



**FIGURE 2.10** 

## TEMPORARY CONSTRUCTION COMPOUND LAYOUT PLAN

#### NOTES:

- SIZE, NUMBER AND LOCATION OF COMPOUND EQUIPMENT AND FACILITIES ARE INDICATIVE ONLY
- 2. STRUCTURE TO BE TEMPORARY AND TO BE REMOVED AFTER CONSTRUCTION.
- 3. COMPOUND HARDSTANDING
  CONSISTING OF COMPACTED STONE
  OVER A LAYER OF GEOTEXTILE TO
  PROVIDE A CLEAN, FIRM, LEVEL AND
  FREE DRAINING SURFACE SUITABLE
  FOR CABINS AND HEAVY TRAFFIC.
- 4. APPROPRIATE MEASURES FOR SEPARATION OF OILS AND TREATMENT OF FOUL WATER TO BE AGREED WITH THE RELEVANT AUTHORITIES.
- 5. VEHICULAR GATES TO BE 6m WIDE CONSISTING OF 2 x 3m LEAVES

N/A

T-LAYOUT NO. N/A

DRAWING NUMBER

03426D2208-01


SCALE - AS SHOWN @ A3

**ENVIRONMENTAL STATEMENT** 



**FIGURE 2.11** 

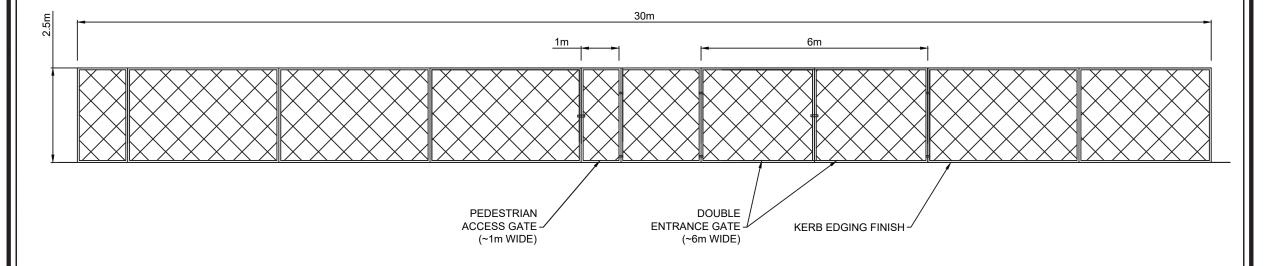TEMPORARY CONSTRUCTION COMPOUND ELEVATION



SECURITY FENCE ELEVATION
SCALE - 1:100

N/A


r-LAYOUT NO. N/A

DRAWING NUMBER

03426D2209-01

SCALE - AS SHOWN @ A3

**ENVIRONMENTAL STATEMENT** 

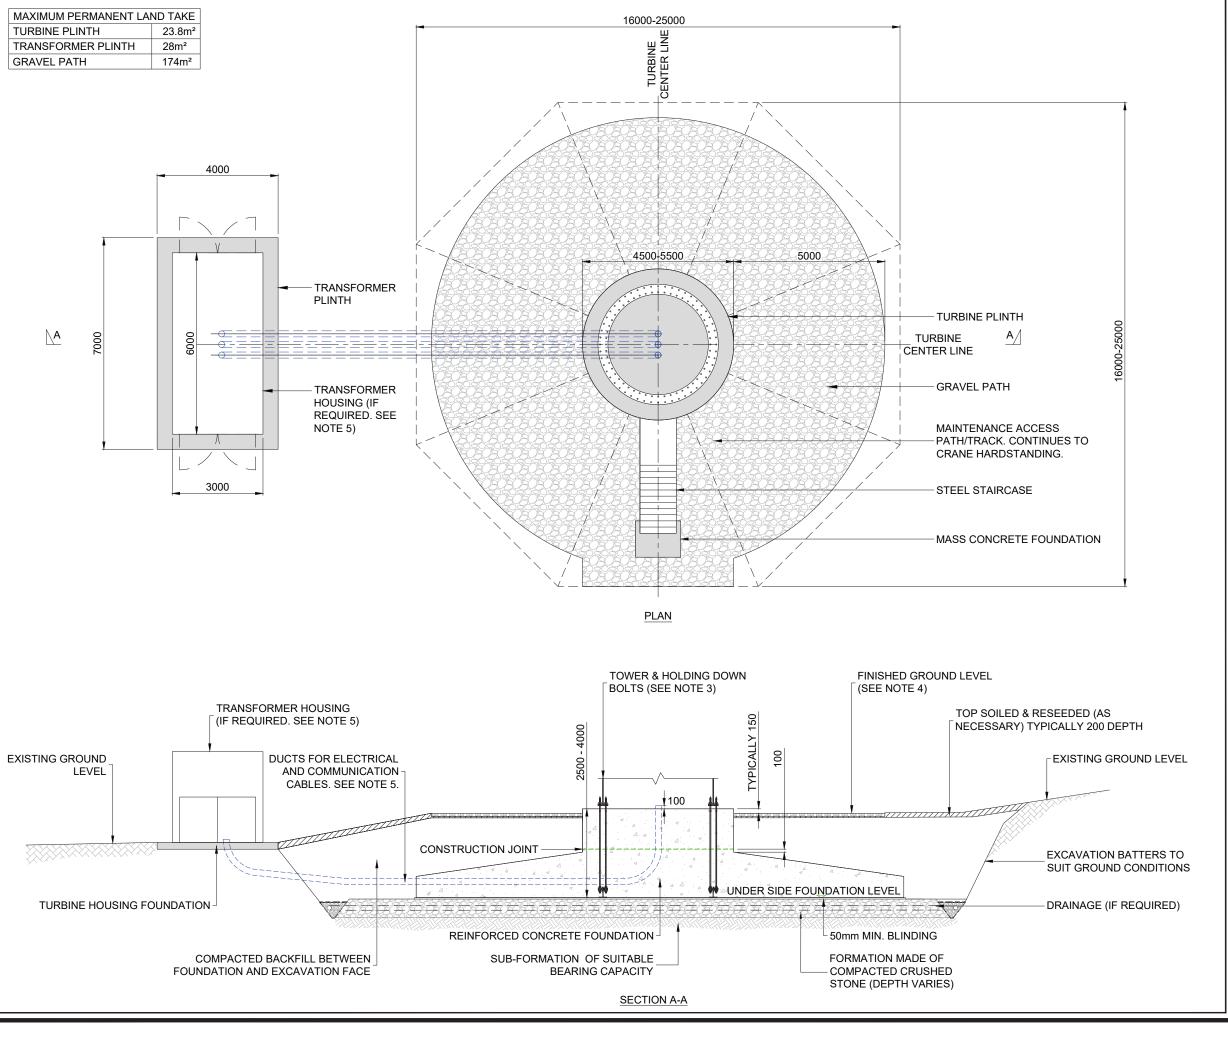



**FIGURE 2.12** 

#### WIND TURBINE FOUNDATION

#### NOTES:

- DIMENSIONS AND DETAILS ARE INDICATIVE ONLY AND MAY VARY DUE TO SPECIFIC TURBINE OR GROUND CONDITIONS.
- 2. ALL DIMENSIONS IN MILLIMETRES UNLESS OTHERWISE STATED
- 3. THE HOLDING DOWN BOLT
  ARRANGEMENT SHOWN ON THIS
  DRAWING IS TYPICAL. HOWEVER
  ALTERNATIVE CAST IN ARRANGEMENTS
  ARE AVAILABLE AND MAY BE
  SUBSTITUTED DEPENDING ON ACTUAL
  TURBINE SELECTION.
- GRADIENT OF FINISHED GROUND LEVEL OVER TURBINE BASE, MAX 1:12.
- 5. EXTERNAL TRANSFORMER NOT REQUIRED FOR ALL TURBINES AND NEED FOR TRANSFORMER HOUSING WILL DEPEND ON THE TURBINE SELECTED DURING DETAILED DESIGN.
- 6. MATERIALS ARISING FROM
  EXCAVATIONS TO BE SEGREGATED AND
  PLACED IN AGREED LOCATIONS
  ADJACENT TO THE WORKING AREA FOR
  RE-USE. REINSTATEMENT AND /OR PEAT
  MANAGEMENT PLANS WILL BE
  DEVELOPED DURING THE DETAILED
  DESIGN OF SITE INFRASTRUCTURE, IN
  LINE WITH CURRENT BEST PRACTICE.

N/A


T-LAYOUT NO. N/A

DRAWING NUMBER

03426D2303-01

SCALE - 1:125 @ A3

#### **ENVIRONMENTAL STATEMENT**

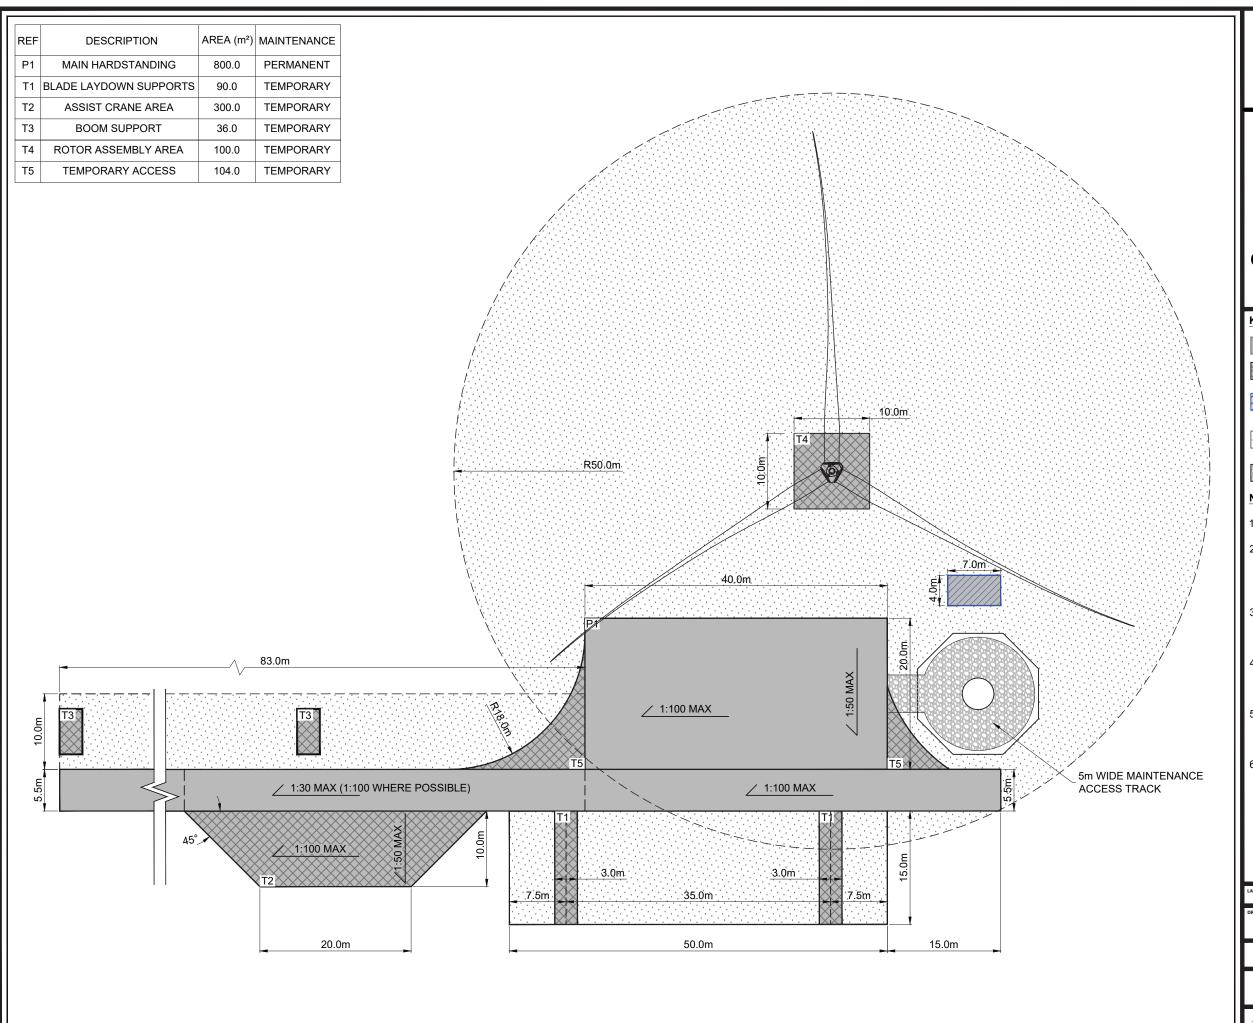



**FIGURE 2.13** 

#### **CRANE HARDSTANDING GENERAL ARRANGEMENT**

#### KEY:

PERMANENT WORKS

TEMPORARY WORKS



ZEXTERNAL TRANSFORMER AND SWITCHGEAR ENCLOSURE



AREA TO BE FREE FROM TOPOGRAPHICAL CONSTRAINTS



MAINTENANCE ACCESS TRACK

#### NOTES:

- 1. ALL DIMENSIONS IN METRES.
- 2. HARDSTANDING ARRANGEMENT SUBJECT TO CHANGE DEPENDENT ON SPECIFIC WIND TURBINE MODEL SELECTED FOR CONSTRUCTION.
- 3. ALL HARDSTANDINGS TO BE CONSTRUCTED ON SUITABLE FOUNDATION MATERIAL.
- 4. ALL HARDSTANDINGS TO BE FINISHED WITH CRUSHED ROCK, FORMING A FREE DRAINING SURFACE.
- 5. TRACK ADJACENT TO CRANE HARDSTANDING TO BE DESIGNED TO ACCEPT CRANE OUTRIGGER LOADING.
- 6. THE PRELIMINARY CRANE HARDSTANDING LAYOUT HAS BEEN DEVELOPED TO ACCOMMODATE EITHER A SINGLE BLADE LIFT OR FULL ROTOR LIFT.

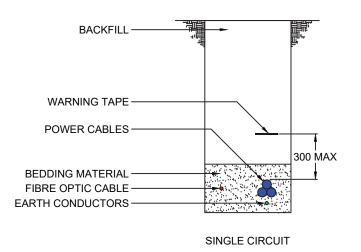
N/A

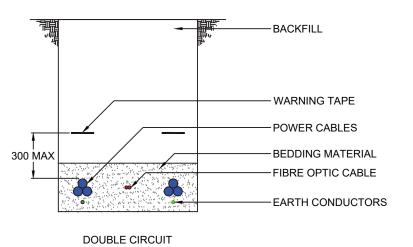
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03426D2304-02

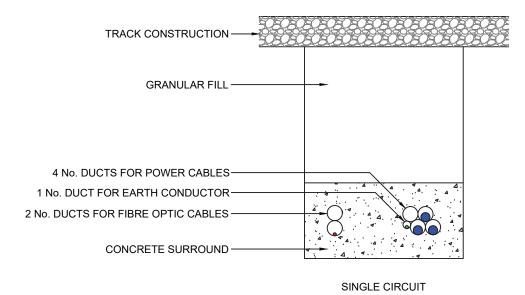
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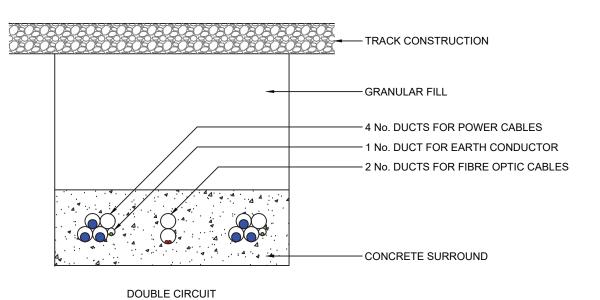
**ENVIRONMENTAL STATEMENT** 





TYPICAL CABLE TRENCHES





TYPICAL TRACK CROSSINGS



**FIGURE 2.14** 

## CROSS SECTION OF UNDERGROUND CABLE TRENCH

#### NOTES:

- THIS DRAWING IS INDICATIVE ONLY AND IS SUBJECT TO CHANGE AT THE DETAILED DESIGN STAGE.
- 2. ALL DIMENSIONS IN mm.
- CABLES MAY BE INSTALLED BY CABLE
   PLOUGH FOR DISTANCES GREATER THAN
   1km

N/A

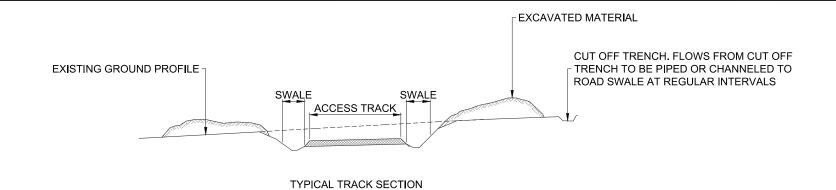
-LAYOUT NO. N/A

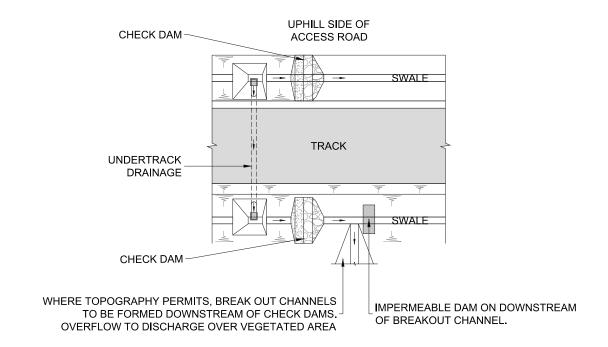
PRAWING NUMBER

03426D2305-01


SCALE - NOT TO SCALE

**ENVIRONMENTAL STATEMENT** 





TYPICAL TRACK PLAN

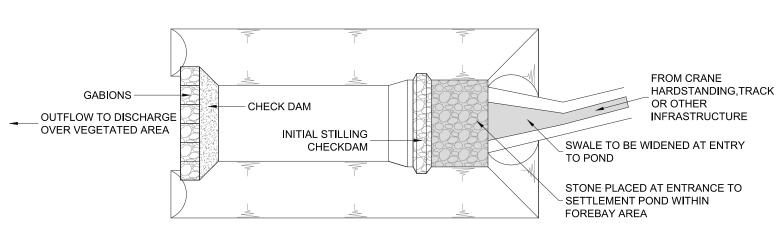

TYPICAL SETTLEMENT POND



TYPICAL UNDER TRACK DRAINAGE



TYPICAL CHECK DAM



TYPICAL SETTLEMENT POND



## MAGHERAMORE WIND FARM

**FIGURE 2.15** 

## TYPICAL DRAINAGE DETAILS

#### NOTES:

- 1. SUDS SYSTEM TO BE CONSTRUCTED PRIOR TO, OR AT THE SAME TIME AS THE ACCESS ROAD.
- SUSTAINABLE PREVENTION MEASURES SHOULD BE IN PLACE AT ALL TIMES TO PREVENT THE CONVEYANCE OF SILTS TO RECEIVING WATERCOURSE.
- DRAINAGE SWALES TO BE EXCAVATED ADJACENT TO THE ACCESS TRACK.
  REGULAR CROSS DRAINS TO BE LOCATED ALONG ACCESS TRACKS TO PREVENT EXCESSIVE VOLUMES OF WATER COLLECTING IN THE SWALES.
- MOADSIDE SWALES TO BE SHALLOW WITH MODERATE GRADIENTS TO PREVENT SCOURING. IN STEEP AREAS CHECK DAMS WILL BE DESIGNED TO REDUCE FLOW RATE AND PROVIDE SOURCE CONTROL SILT CONTAINMENT. WHERE NECESSARY THESE WILL BE DESIGNED IN CONJUNCTION WITH SETTLEMENT PONDS AND/OR CROSS DRAINS.
- 5. BUILD UP OF SILT LEVELS AT CHECK DAMS TO BE REMOVED AND DISPOSED OF APPROPRIATELY. SILT LEVELS AT CHECK DAMS TO BE VISUALLY INSPECTED AS PART OF AN ONGOING MAINTENANCE PROGRAMME.
- SPACING AND FREQUENCY OF CHECK DAMS WILL BE DEPENDENT UPON LONGITUDINAL GRADIENT OF SWALE.

N/A

r-LAYOUT NO. N/A


DRAWING NUMBER

03426D2306-01

SCALE - NOT TO SCALE

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# MAGHERAMORE WIND FARM

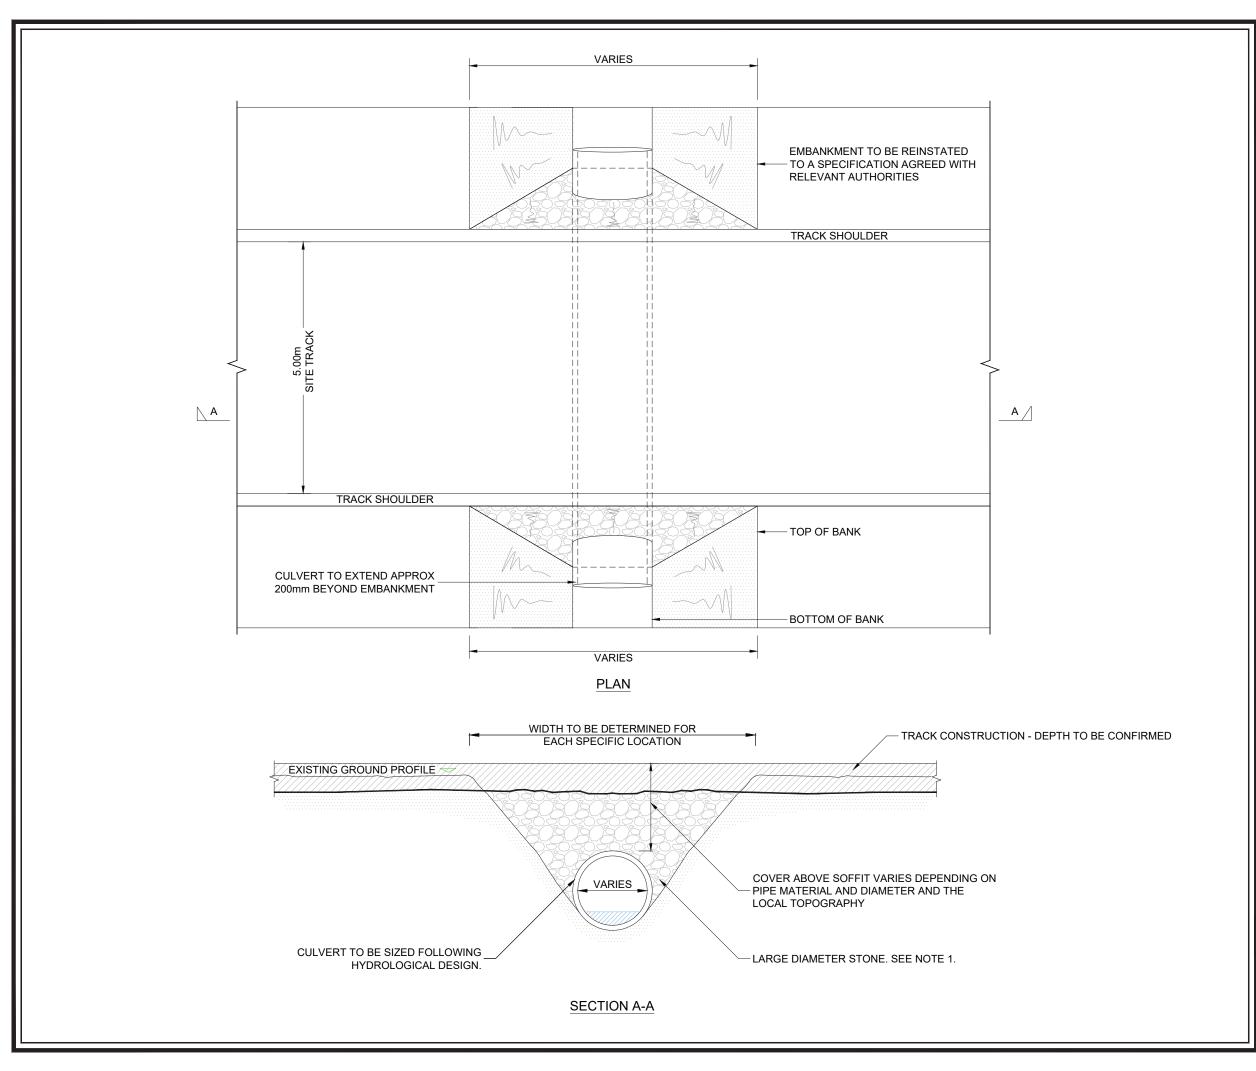**FIGURE 2.16** 

## TYPICAL WATER CROSSING DESIGN

#### NOTES:

- FINAL SPECIFICATION AND INSTALLATION METHOD TO BE IN ACCORDANCE WITH THE REQUIREMENTS OF THE RELEVANT AUTHORITIES.
- CULVERT TYPE AND SIZING TO BE DEFINED DURING DESIGN OF ON-SITE DRAINAGE SYSTEMS.
- 3. INFILL MATERIAL TO BE CLEAN CRUSHED ROCK.

N/A

T-LAYOUT NO. N/A


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PLAN SCALE 1:200



# MAGHERAMORE WIND FARM

**FIGURE 2.17** 
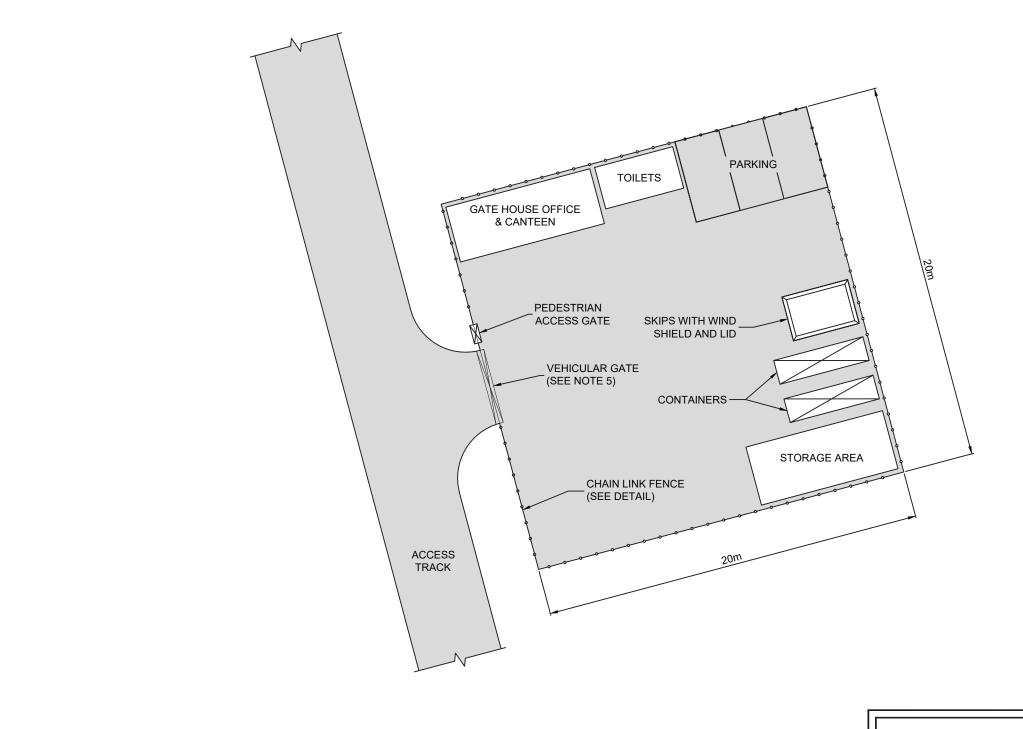
## ENABLING WORKS COMPOUND LAYOUT PLAN

#### <u>NOTES</u>

- 1. DO NOT SCALE FROM THIS DRAWING.
- SIZE, NUMBER AND LOCATION OF
  COMPOUND EQUIPMENT AND FACILITIES
  ARE INDICATIVE ONLY AND SUBJECT TO
  CHANGE TO SUIT SITE CONDITIONS.
- 3. COMPOUND HARDSTANDING TO BE REMOVED FOLLOWING CONSTRUCTION WORKS BEING COMPLETED AND GROUND REINSTATED TO ORIGINAL CONDITION.
- 4. APPROPRIATE MEASURES FOR SEPARATION OF OILS AND TREATMENT OF FOUL WATER TO BE AGREED WITH THE RELEVANT AUTHORITIES
- 5. VEHICULAR GATES TO BE 6m WIDE CONSISTING OF 2 x 3m LEAVES.
- 6. COMPOUND HARDSTANDING TO CONSIST OF COMPACTED STONE OVER A LAYER OF GEOTEXTILE TO PROVIDE A CLEAN, FIRM, LEVEL AND FREE DRAINING SURFACE SUITABLE FOR CABINS/HEAVY TRAFFIC.
- 7. FOLLOWING MOBILISATION OF THE MAIN CONSTRUCTION COMPOUND, ALL STRUCTURES, WITH EXCEPTION OF THE GATE HOUSE OFFICE, SHALL BE REMOVED AND THE HARDSTANDING AREA WILL BE USED AS A TEMPORARY CAR PARK FOR CONTRACTORS STAFF

CHAIN LINK FENCE

TYPICAL FENCE PANEL

NTS

N/A

T-LAYOUT NO. N/A

DRAWING NUMBER

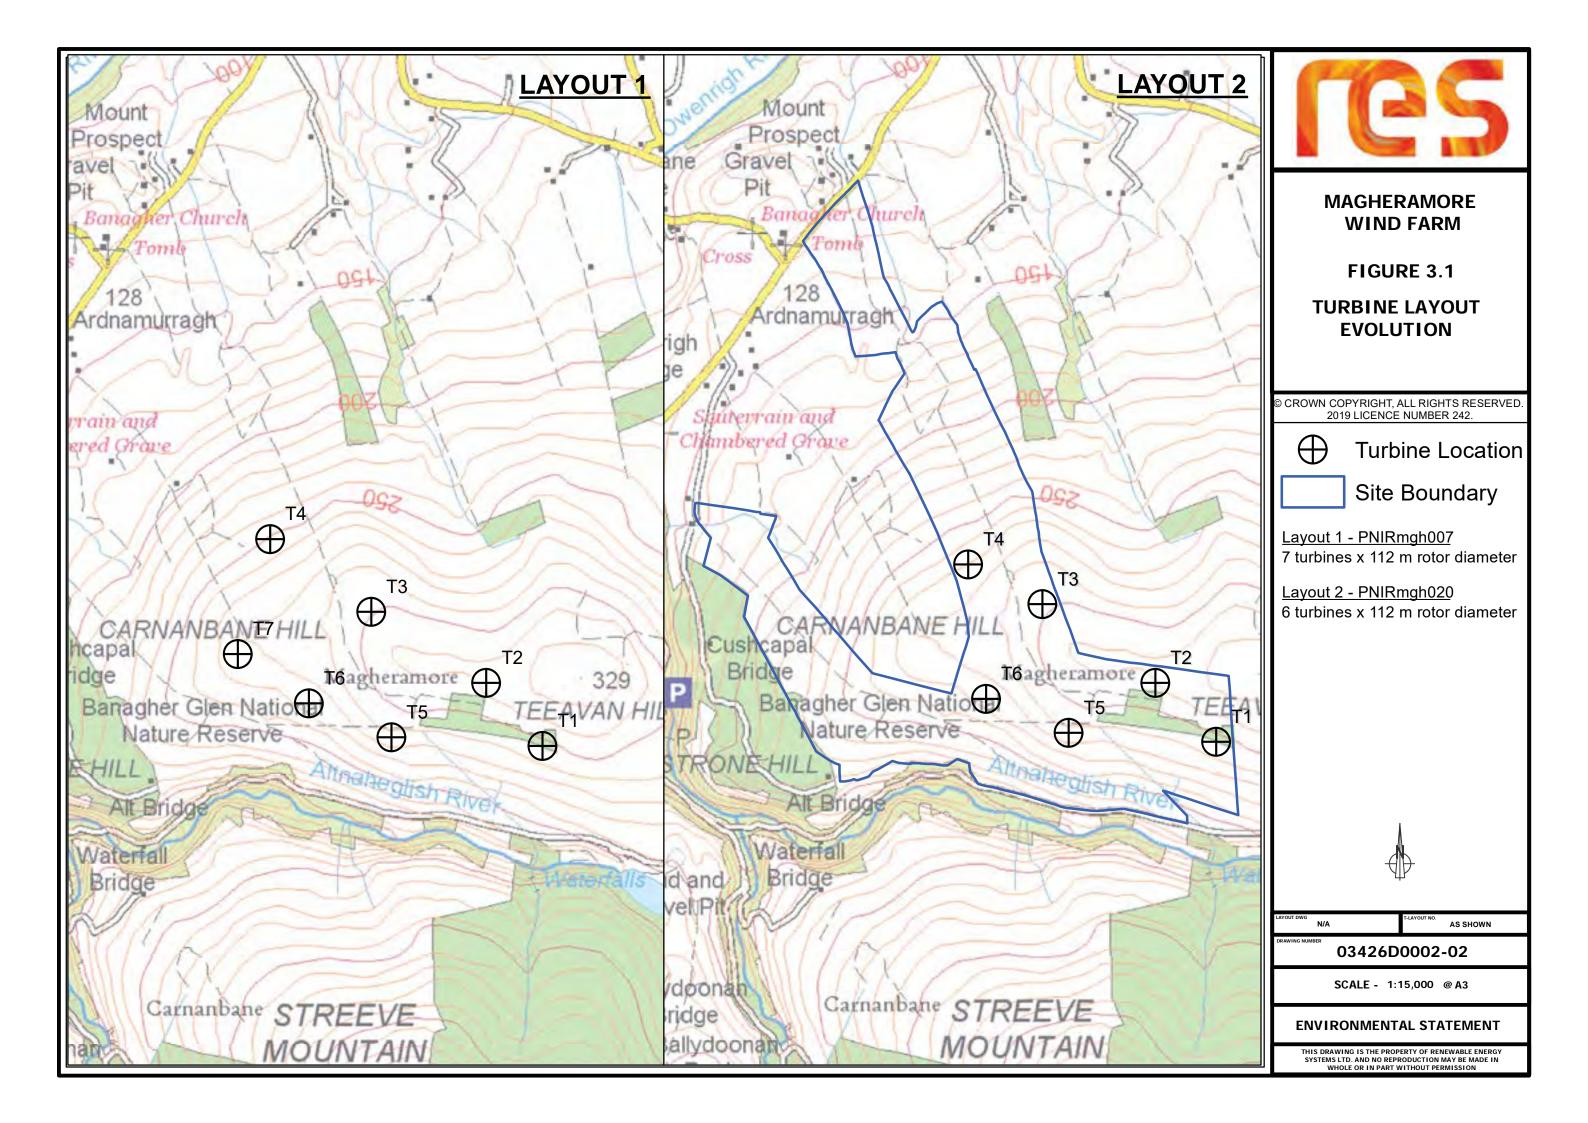
03426D2224-01

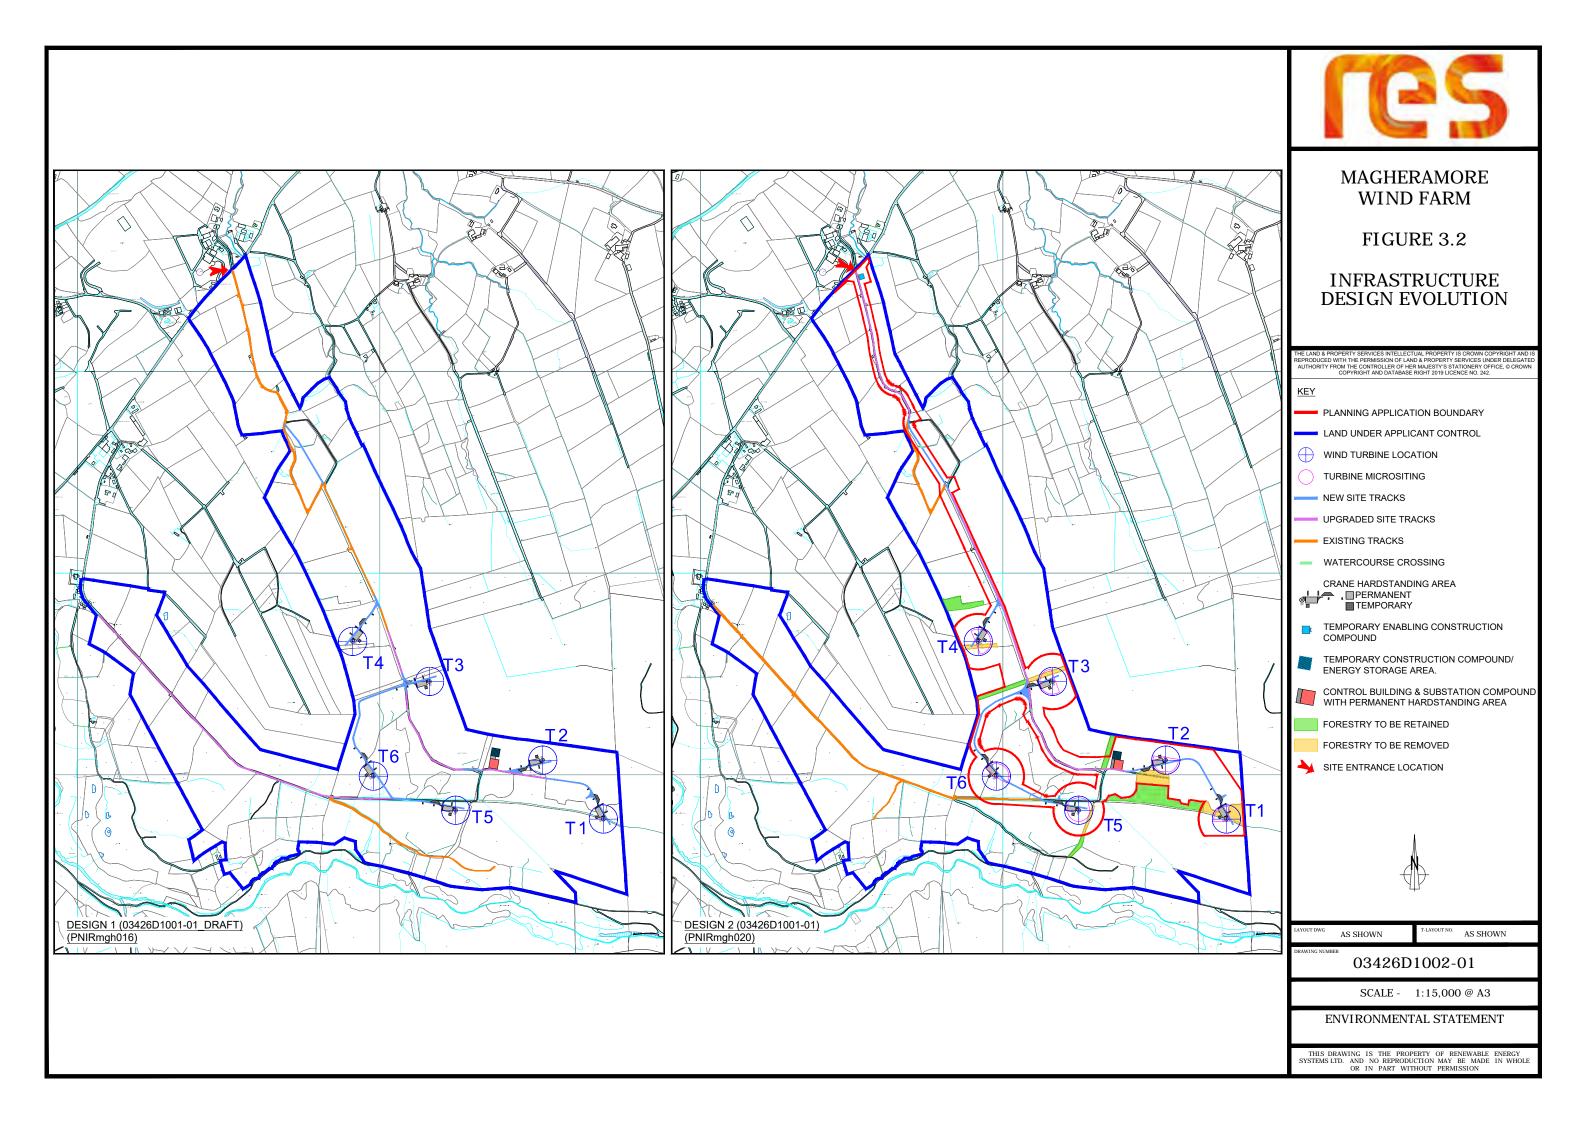
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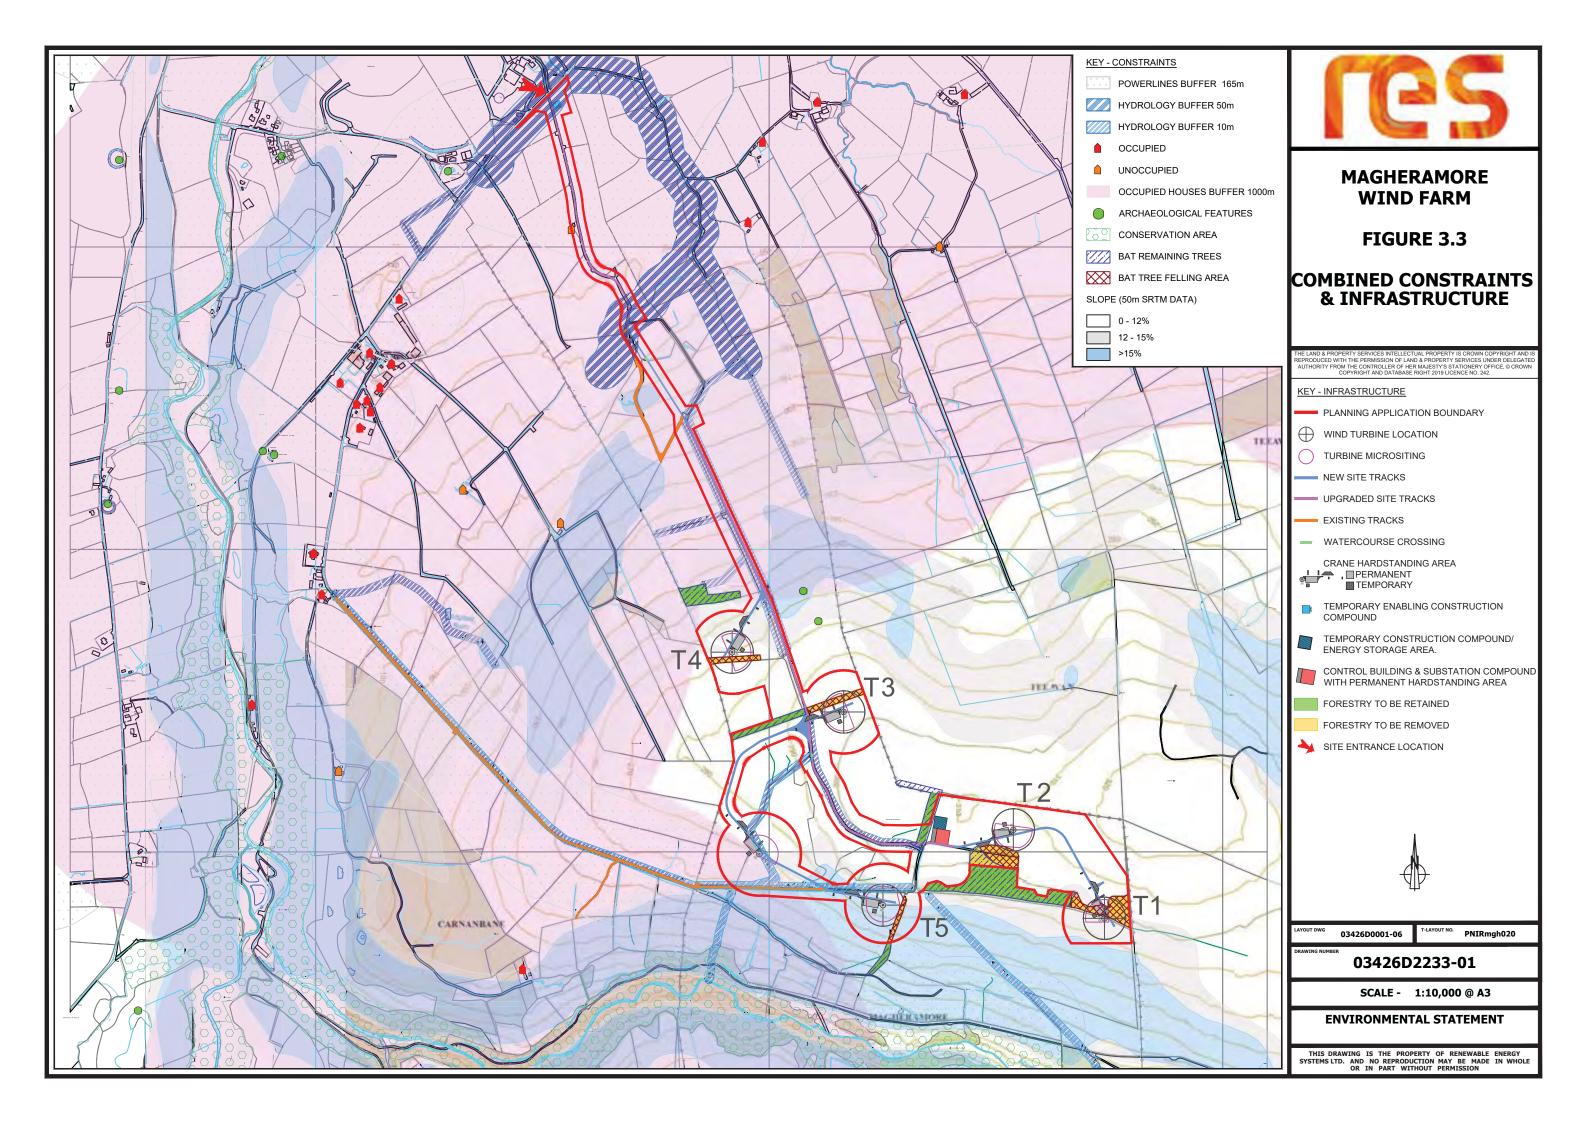
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# Design Evolution & Alternatives







# Landscape & Visual

#### PURPOSE AND UNDERSTANDING OF THESE FIGURES:

These map-based Figures provide information on the baseline conditions within the 30 km Study Area that has been used for this Landscape and Visual Impact Assessment. They must be viewed in conjunction with the analysis of landscape and visual effects contained in Chapter 4 of the Environmental Statement and the detailed methodology for the preparation of visualisations contained in Technical Appendix 4.2.

For ease of reference, the Reverse Zone of Theoretical Visibility (ZTV) is shown on Figures 4.2 and 4.4. The shaded areas indicate parts of the Study Area which would experience no blade tip visibility of the Development. The same is illustrated in Figure 4.10: Reverse Blade Tip ZTV and the means of understanding ZTV diagrams are further explained on the cover sheet preceding the ZTV Figures 4.6 - 4.12.

Figure 4.1 collates key information from other LVIA Figures. It provides an overview of the key landscape and visual characteristics of the Study Area. More detailed information on the baseline conditions in the Study Area are provided on the other Figures in this section.

Figure 4.2 illustrates the location of statutory landscape designations defined by planning policy and Development Plans. These provide evidence of the value placed on various parts of the Study Area for landscape and/ or visual characteristics and which may be subject to particular development control or planning policies. Non-statutory classifications, such as tourist routes and visitor attractions within the Study Area are also mapped on this figure. These give an indication of the wider value of the Study Area to society although these classifications may not equate to any statutory protection.

Landscape Character Areas are presented separately on Figure 4.3. These are defined by a published Landscape Character Assessment for Northern Ireland which defines areas of distinct, recognisable or common character. LCAs are further analysed by site survey and, where they are not deemed to be of relevance to this Development, this is indicated on the figure.

Figure 4.4 illustrates the location of Provisional Viewpoints that were used to gain an initial understanding of the visual characteristics of the Development within the Study Area. It also illustrates the location of final Viewpoints that were chosen to provide a representative sample of viewers (receptors) and types of views of the Development across the Study Area and, most importantly, to demonstrate potential views of the Development rather than to show the screening effect of landscape features. A full and detailed description of the viewpoint selection process is provided in Technical Appendix 4.4 and should be referred to in conjunction with this figure.

Figure 4.5 illustrates the locations of other wind farms and single turbines that are considered to form the 'Cumulative Baseline' for this LVIA which comprises existing, consented and proposed (in-planning) wind farms which are likely to be visible from the selected Viewpoints (see Figures 4.13 – 4.33). A full description of the Cumulative Baseline is provided in Technical Appendix 4.5.




#### MAGHERAMORE WIND FARM


**FIGURES 4.1 - 4.5** 


**BASELINE ASSESSMENT FIGURES** 




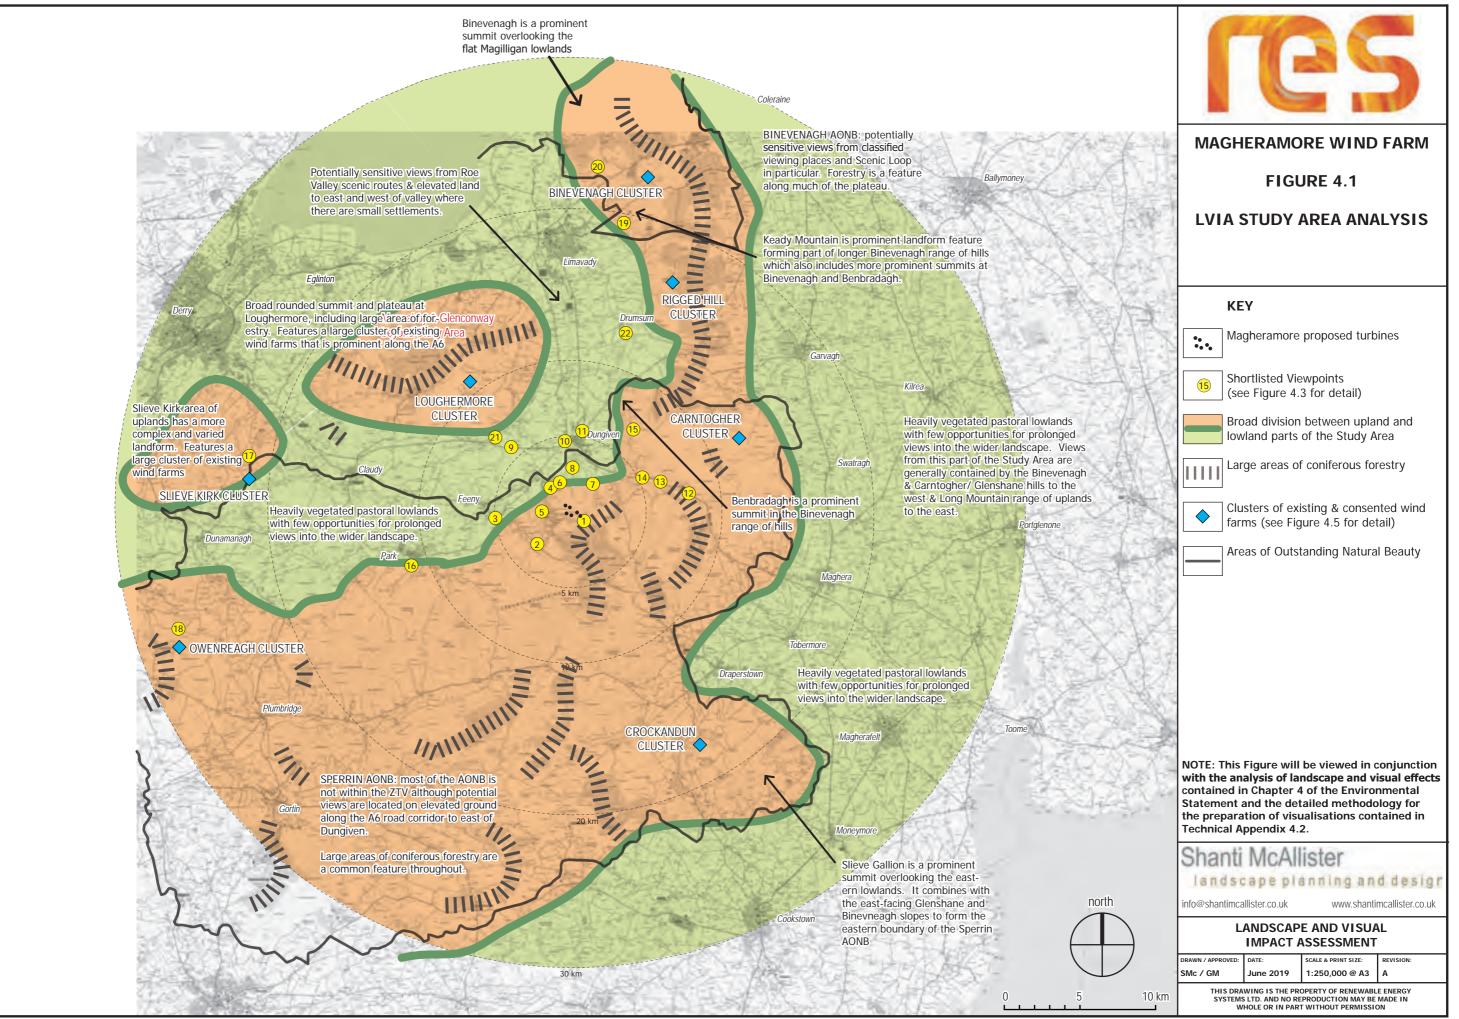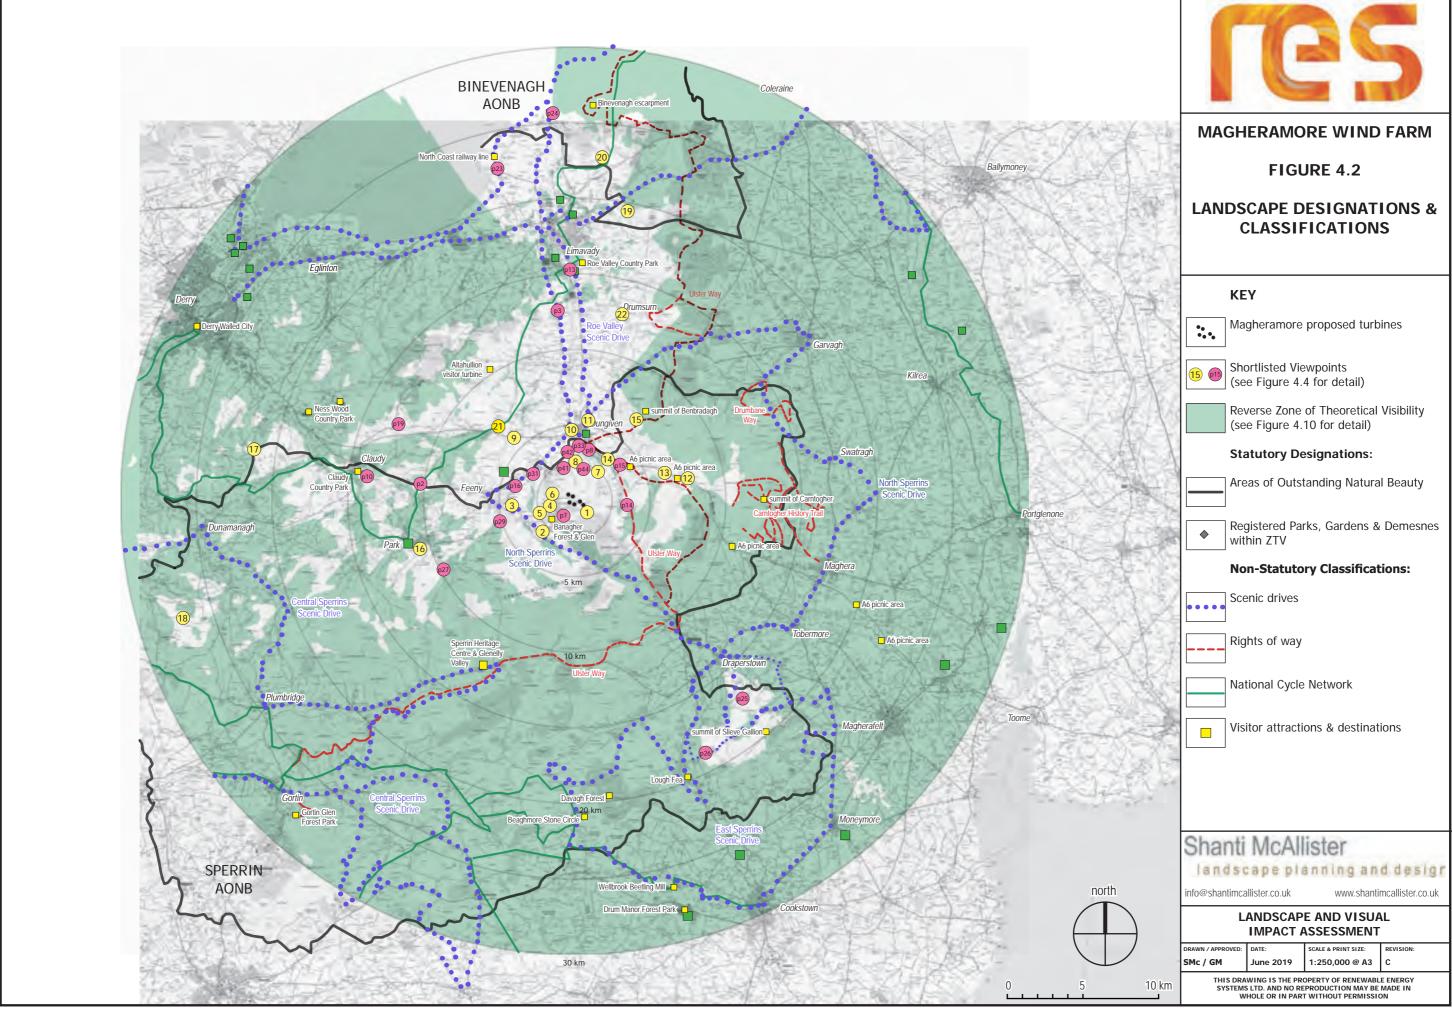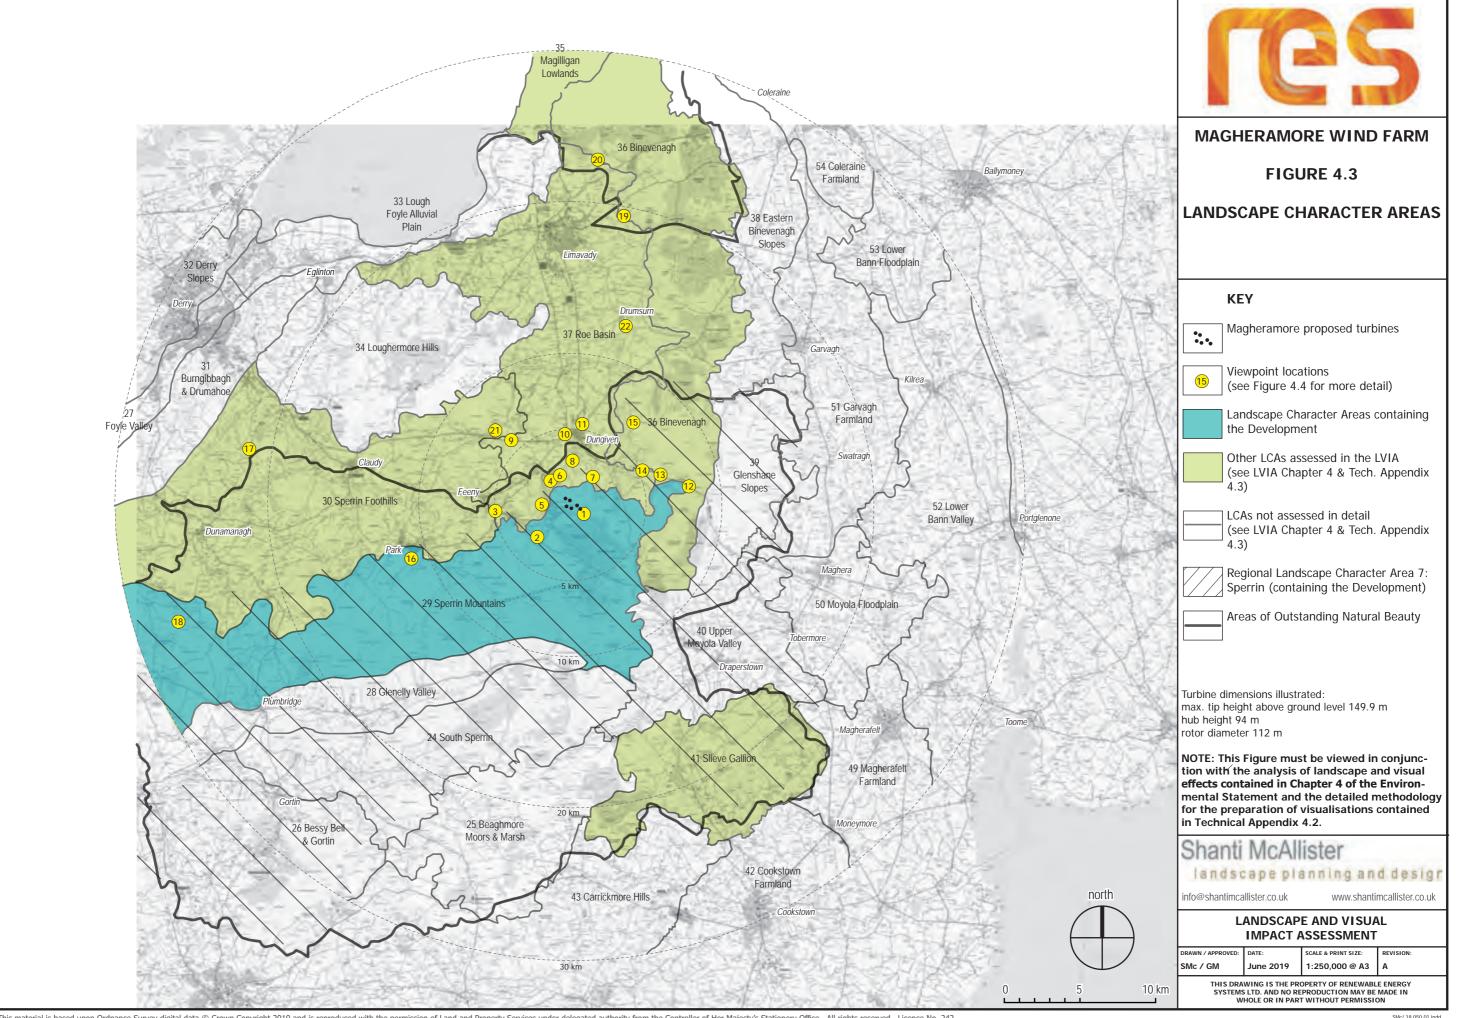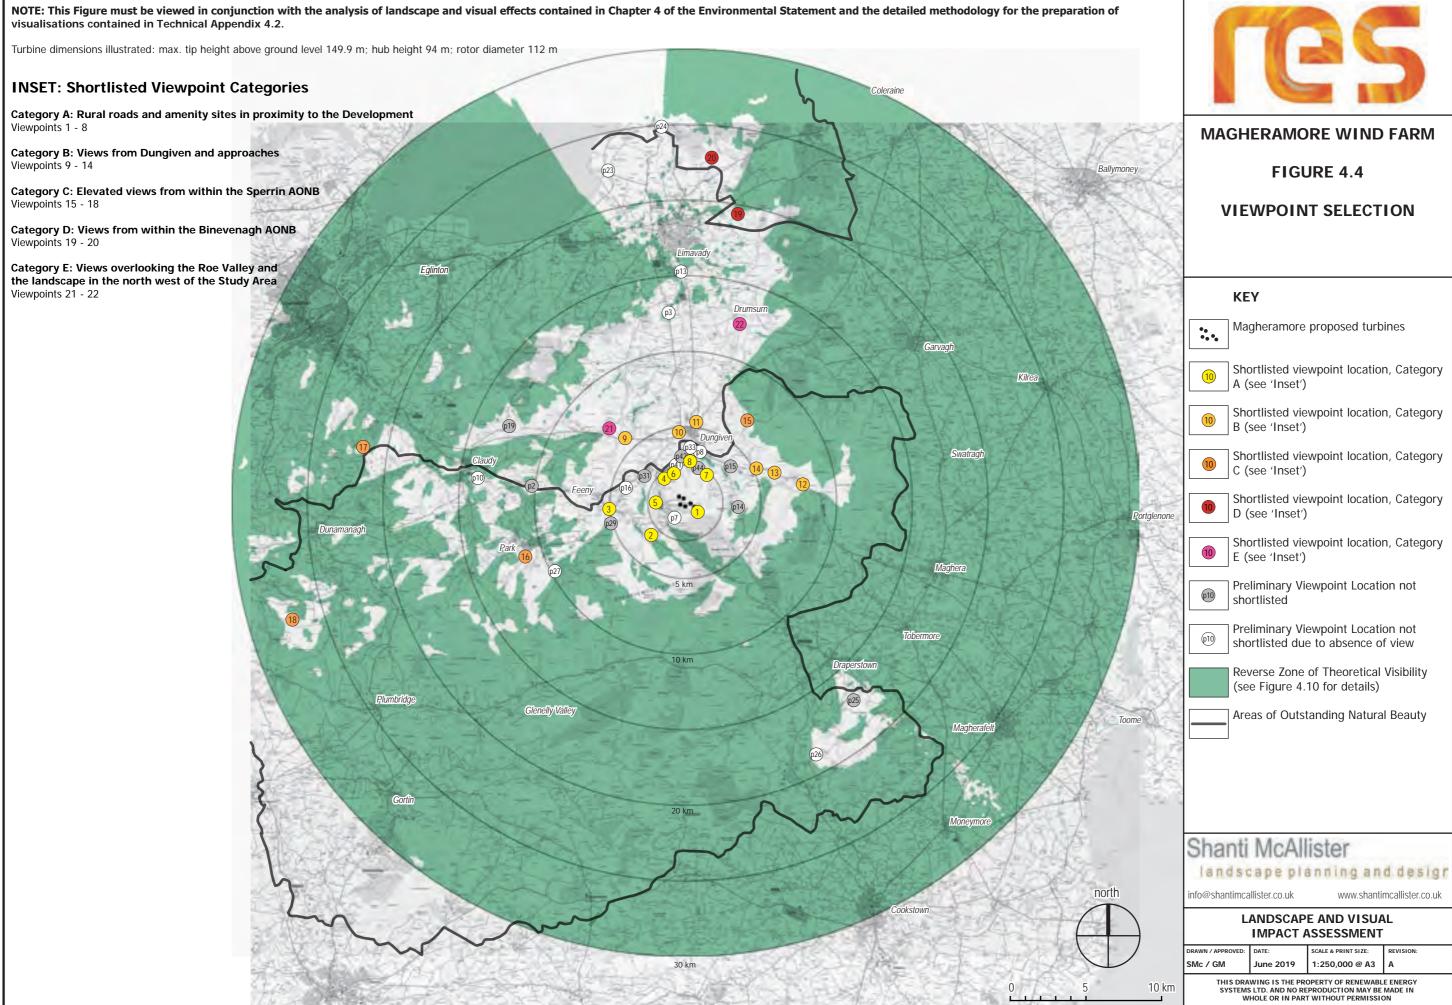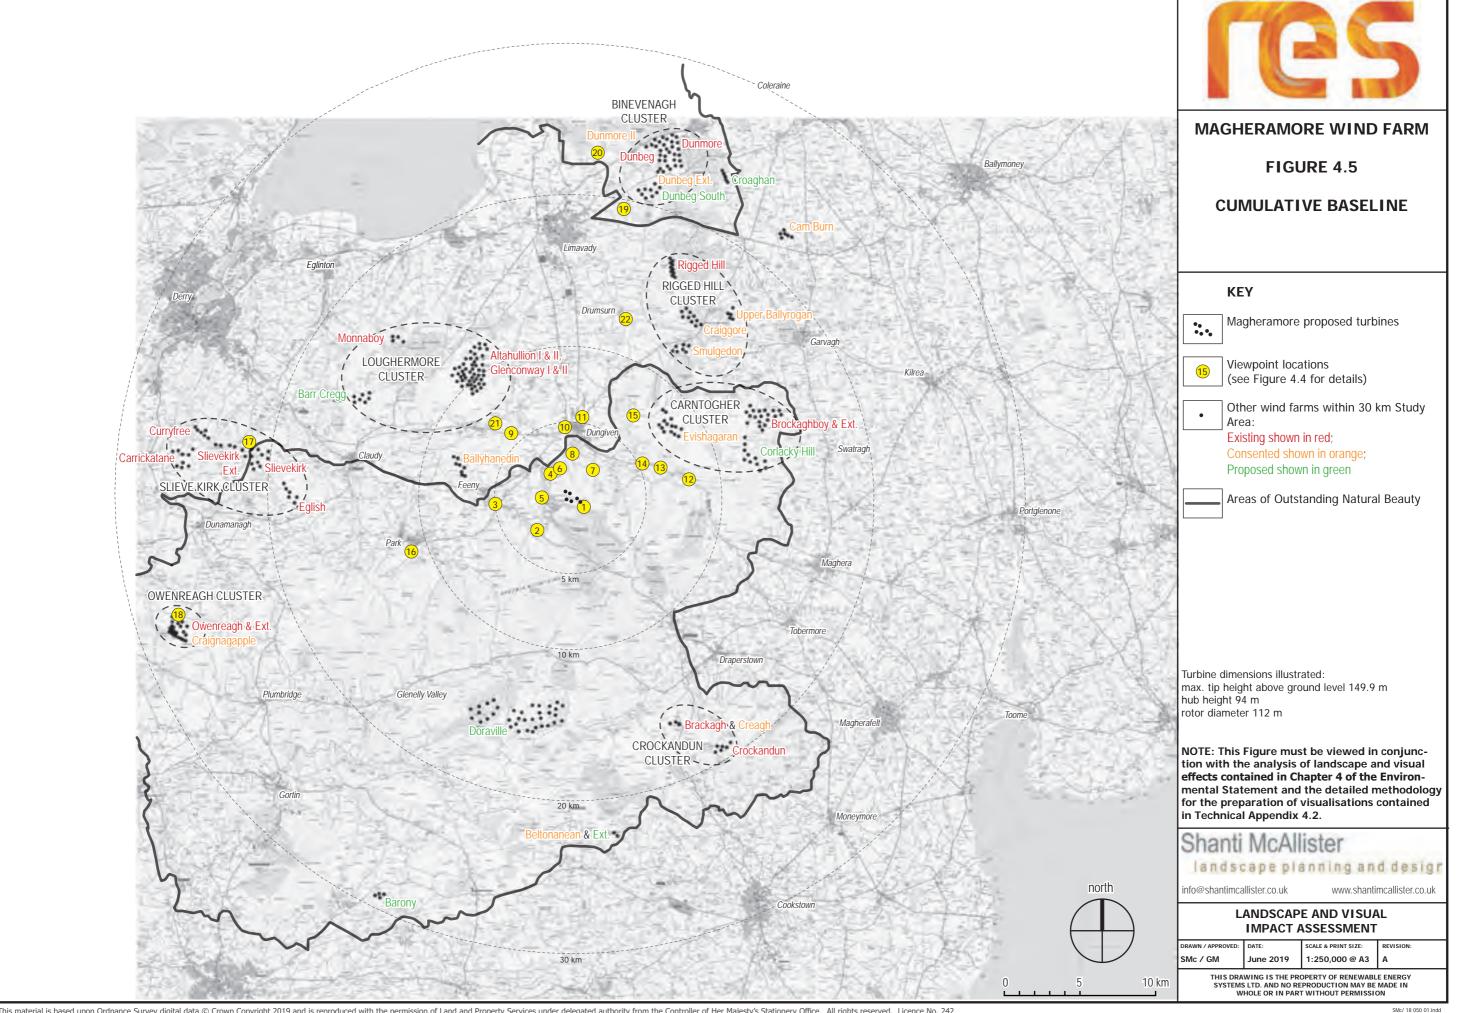
LANDSCAPE AND VISUAL IMPACT ASSESSMENT











#### PURPOSE AND UNDERSTANDING OF THESE FIGURES:

These map-based Figures provide information on the baseline conditions within the 30 km Study Area that has been used for this Landscape and Visual Impact Assessment. They must be viewed in conjunction with the analysis of landscape and visual effects contained in Chapter 4 of the Environmental Statement and the detailed methodology for the LVIA that is described in Technical Appendix 4.2.

A Zone of Theoretical Visibility (ZTV) is a map-based diagram showing where the Development and other wind farms in the Cumulative Baseline would theoretically be visible from within the Study Area. They are created using computer-generated contour data and are useful in providing an initial indication of visibility within the Study Area that allows for more detailed assessment in the field. They do not illustrate actual visibility because they do not take account of above-ground features such as vegetation or buildings, or contour variations between 50 m intervals. A number of ZTV scenarios are assessed in this LVIA and categories of theoretical visibility are indicated using different colours, for example, areas with theoretical visibility of all the proposed turbines would be indicated by one colour, and areas with visibility of lesser numbers of turbines would be indicated by contrasting colours. The coverage of these areas is expressed as a percentage of the overall Study Area.

Blade tip visibility illustrates any parts of the Study Area where at least one blade tip would theoretically be visible without taking account of screening provided by contour variations or land cover elements such as trees and hedgerows. It shows the highest potential levels of theoretical visibility but not necessarily the most realistic because blade tips may be counted even where they protrude only a small amount above a skyline and this type of visibility will change continuously as the turbines rotate. This approach is in accordance with the SNH recommendation to err on the side of over-representation of potential effects.

Hub height ZTV diagrams represent a more realistic illustration because they show theoretical visibility of all points of the turbines to the hub/ nacelle, and therefore also include the upper parts of the turbine blades as a minimum.

Reverse ZTV diagrams are used as a clear means of illustrating the parts of the Study Area where no turbines would be visible. Both blade tip and hub-height diagrams are presented.



#### MAGHERAMORE WIND FARM

FIGURES 4.6 - 4.12

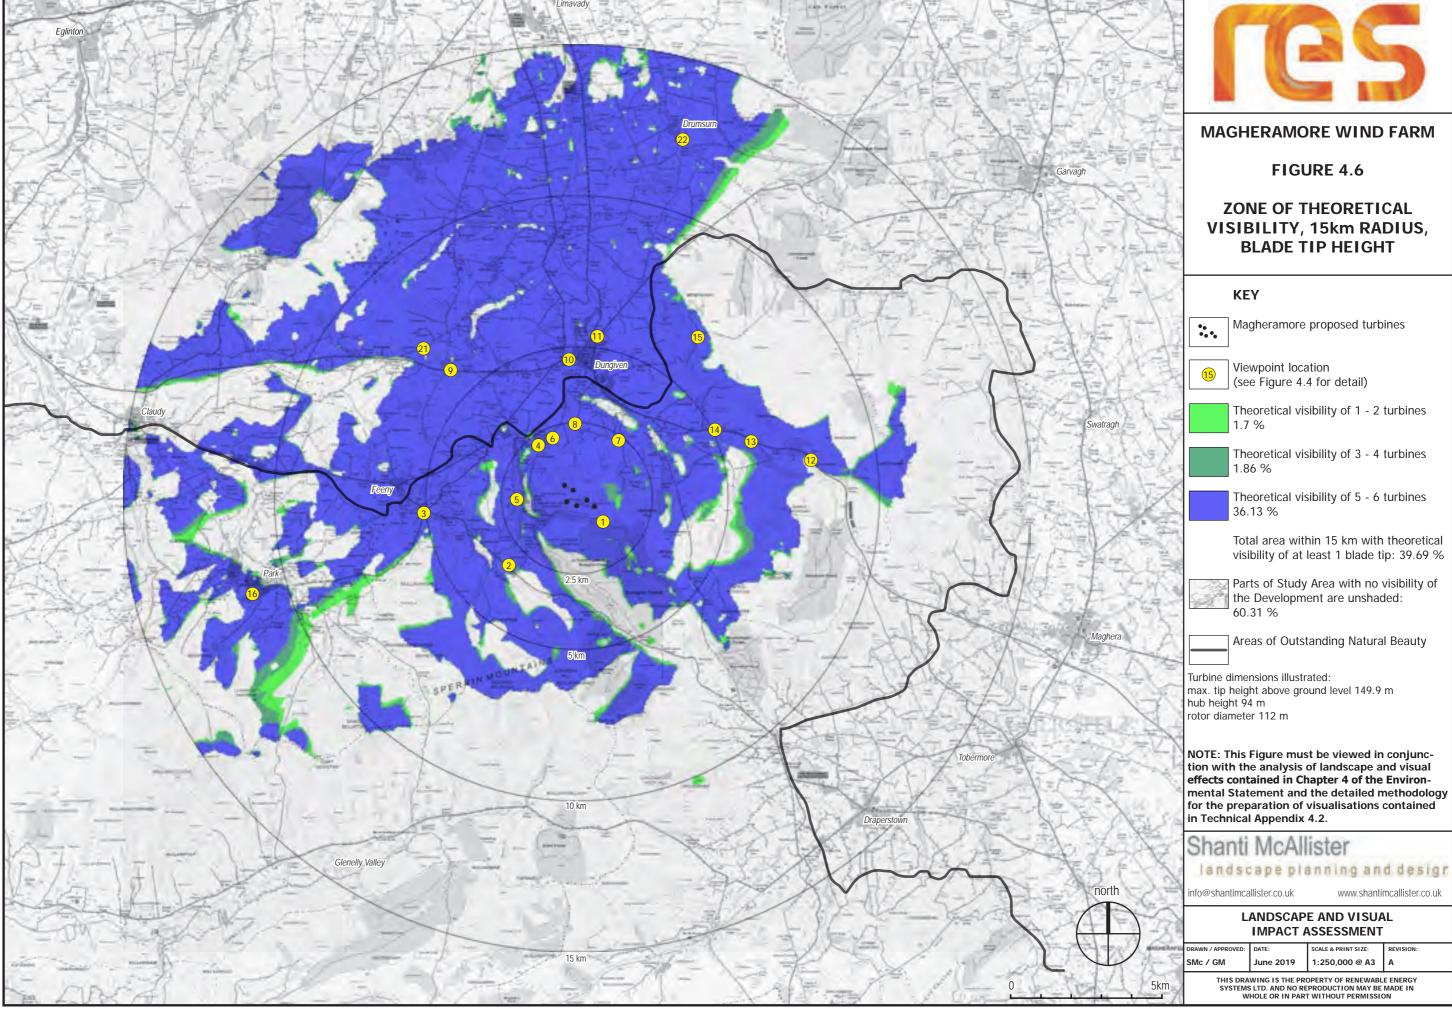
## ZONE OF THEORETICAL VISIBILITY DIAGRAMS

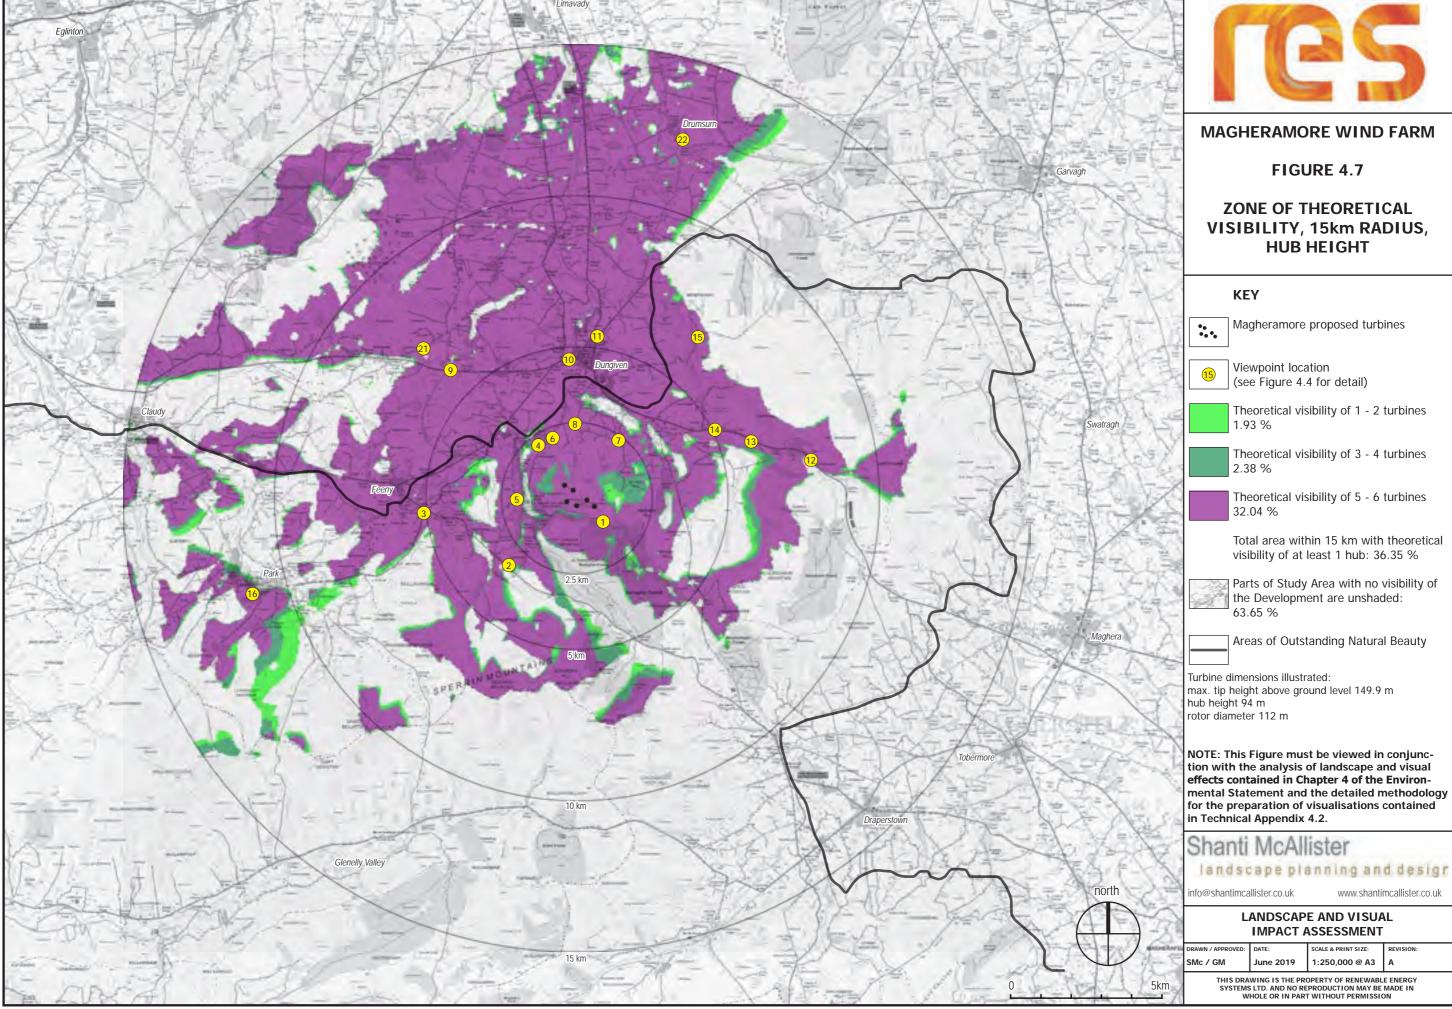
Shanti McAllister

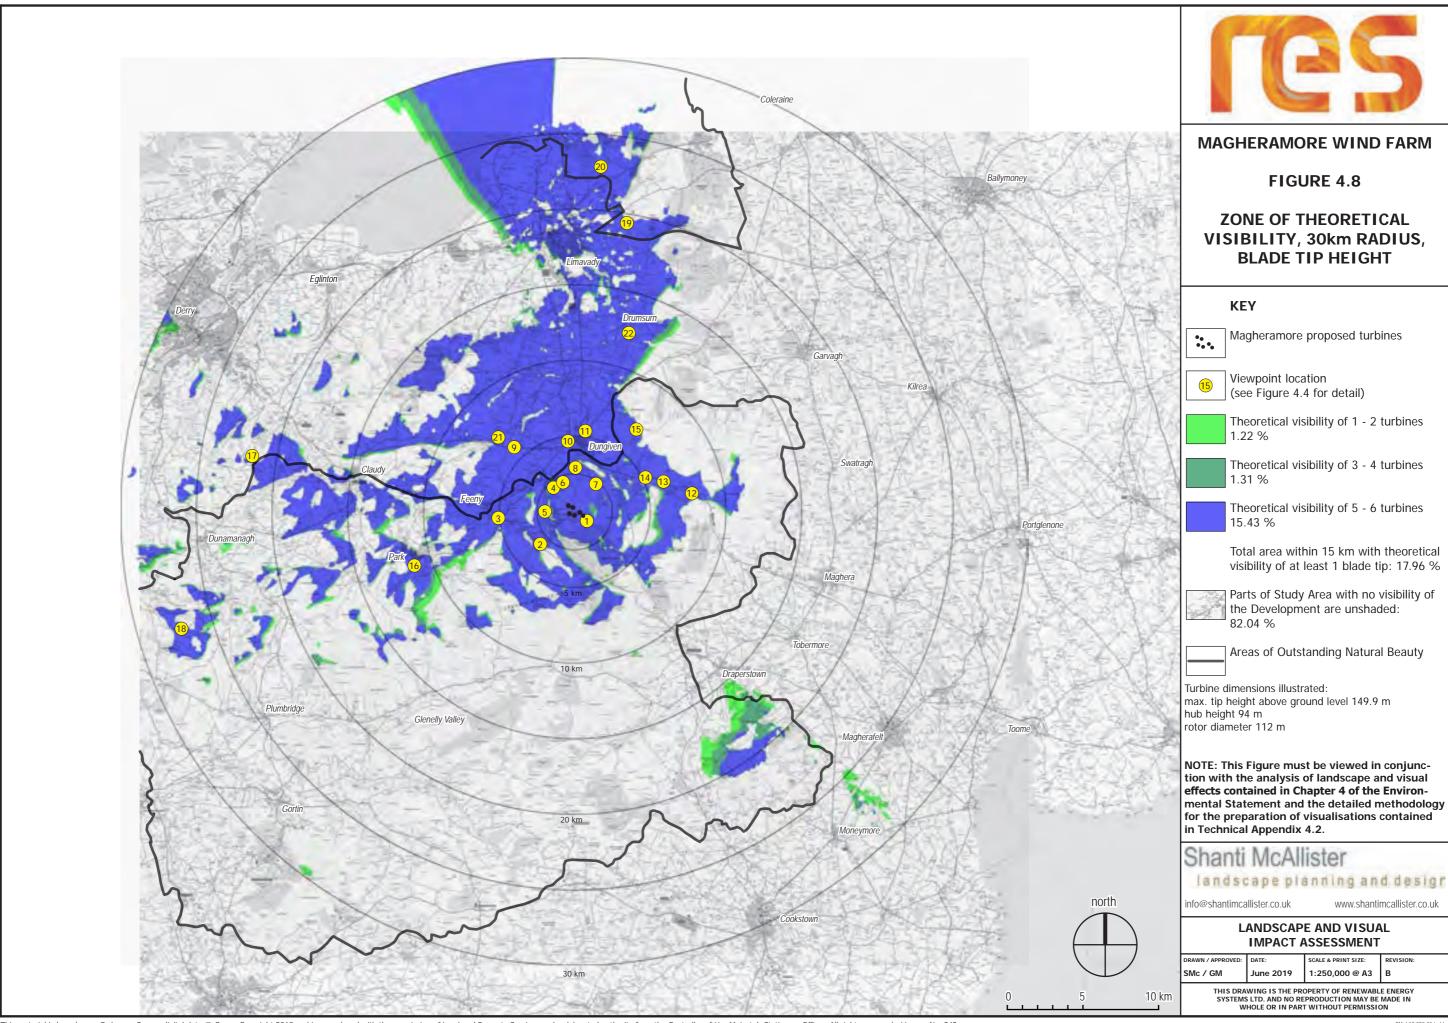
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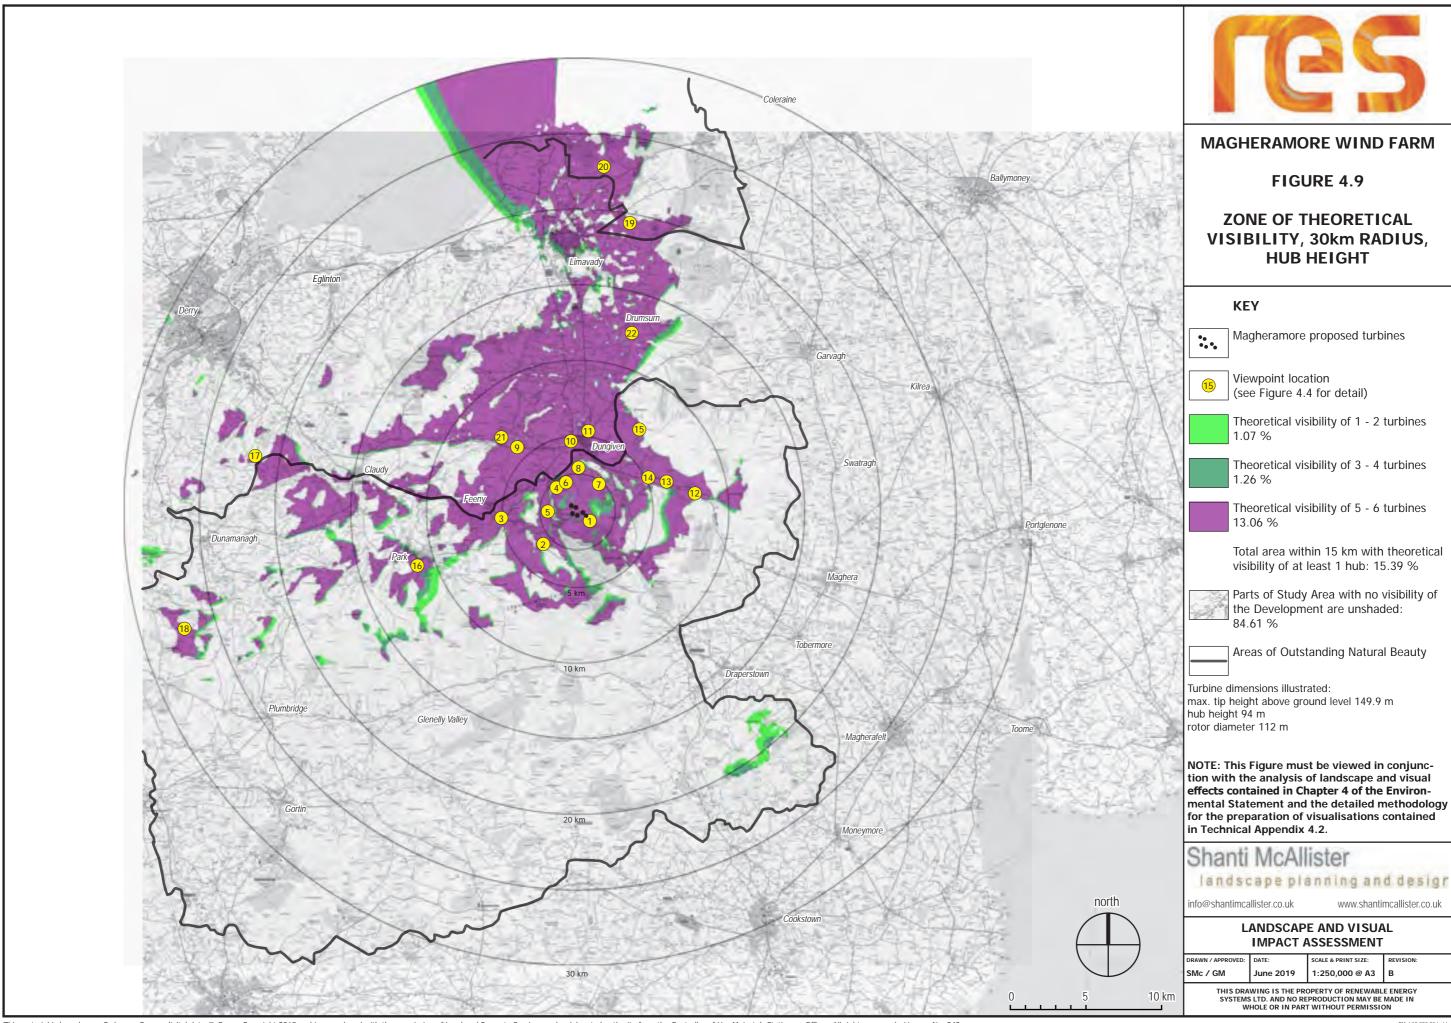
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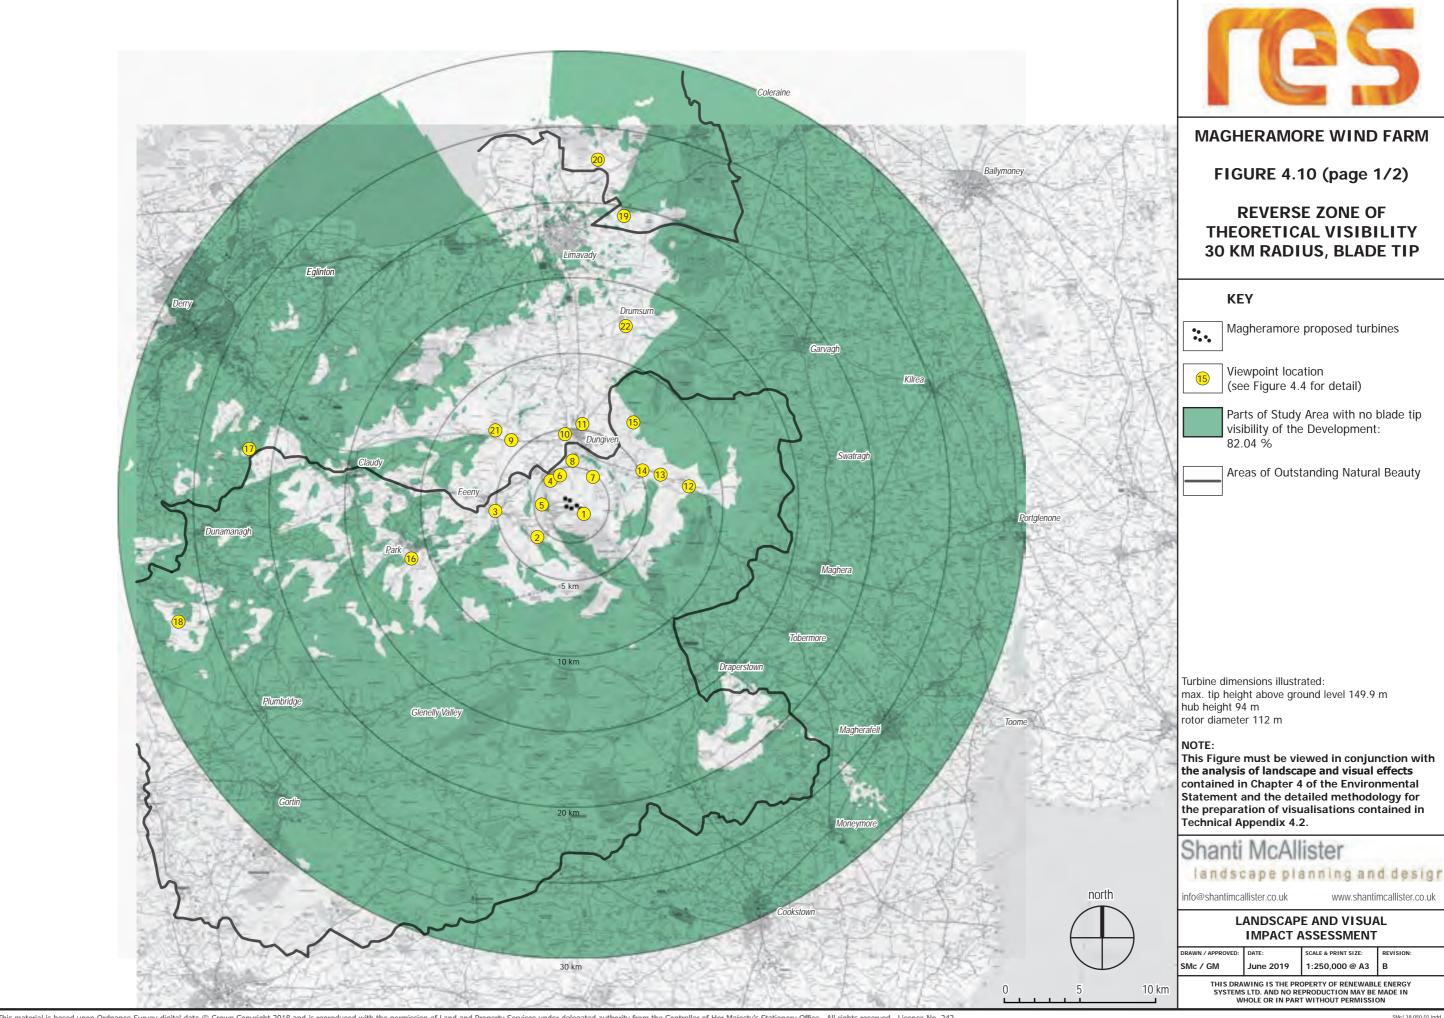
LANDSCAPE AND VISUAL IMPACT ASSESSMENT

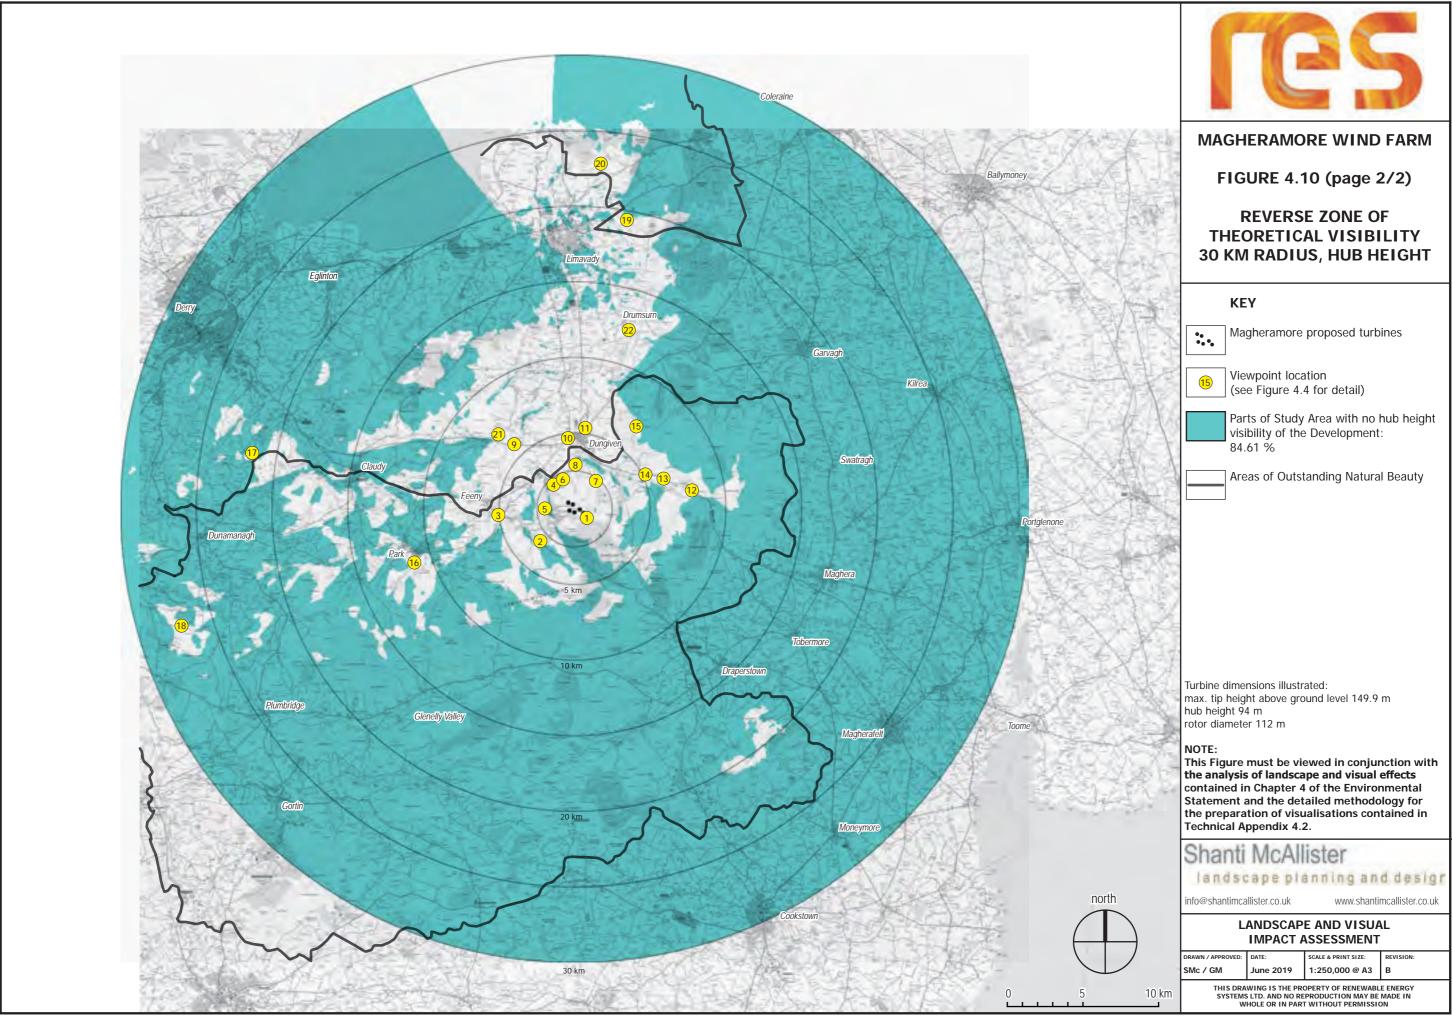


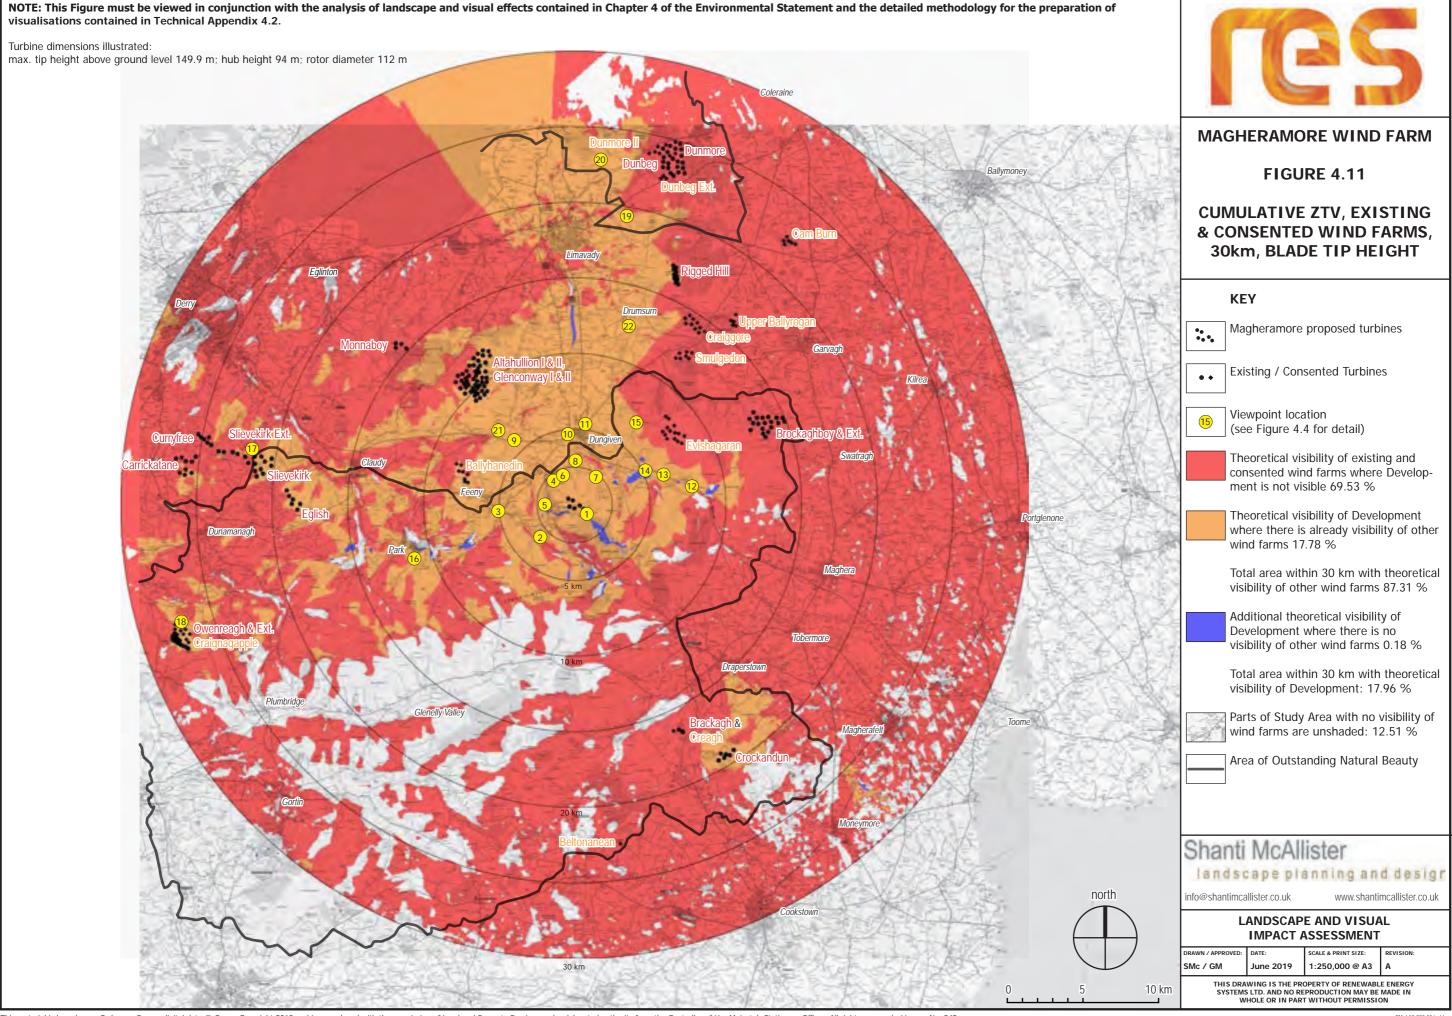


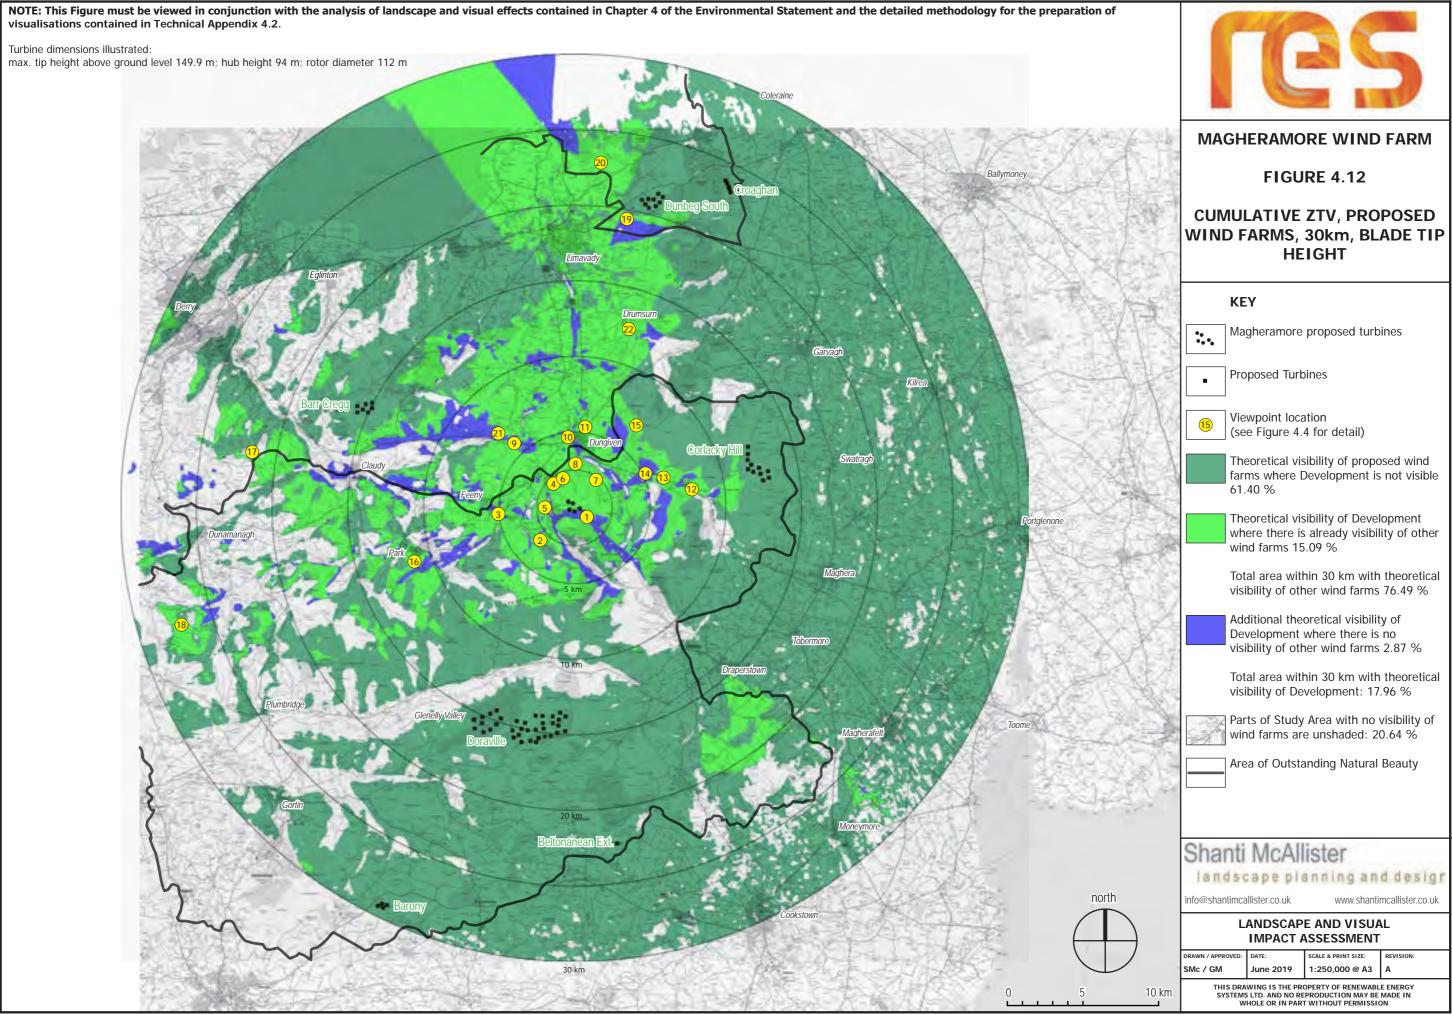












#### PURPOSE AND UNDERSTANDING OF THESE FIGURES:

These Figures are intended to accompany the detailed written descriptions of the final 22 Viewpoints that have been included to represent views of the Development from various parts of the Study Area. They include computer-generated wirelines and photomontages. The purpose of these is to help the assessor establish what the Development's visual effect might be by providing a 'snapshot' of what the Development would look like within the landscape. They should always be viewed in conjunction with the LVIA chapter which provides a detailed written assessment of visual effects, as well as a visit to all of the viewpoints in appropriate weather conditions. Wirelines are not intended to be visually representative images but they are generally accepted as an illustrative digital imaging tool. They provide a good indication of the location of turbines within the landscape and their relationship with the Cumulative Baseline of other wind farms in the Study Area. If these limitations are recognised, visualisations can be accepted as adequate representations for the purpose of the LVIA. The methodology for producing these visualisations is described in detail in Technical Appendix 4.1.

These Figures must be viewed in conjunction with the analysis of landscape and visual effects contained in Chapter 4 of the Environmental Statement and the detailed methodology for the LVIA that is described in Technical Appendix 4.2. Detailed descriptions of the final Viewpoints are an integral part of the Visual Impact Assessment section of Chapter 4, LVIA. Viewpoint locations are shown on Figure 4.4 and all other map-based Figures for ease of reference.

On the wireline diagrams the turbine blades are displayed at an angle of 0°, i.e. the uppermost blade is always shown pointing directly upwards, in order to demonstrate the highest possible level of visibility. All cumulative wind farms, including any which may appear within the view but which are located beyond the field of view that it is possible to illustrate on A3-sized figures, are also labelled on the wireline. However, only existing wind farms and single turbines are shown on the photomontages (i.e. those that are already present within the Study Area). This is in accordance with best practice guidance.

In many scenarios wind farms are visible as elements of wide angle views which can only be appreciated if viewers turn their heads from side to side or move through the landscape. Wirelines and photomontages show the turbines in accurate proportion to other visual elements. However, the overall scale of the view is reduced by the practical need to illustrate the view on a single sheet of paper that allows as many people as possible to have fair and easy access to the published Environmental Statement. Features that are of note in wider views, but which are beyond the angle that can be illustrated in the viewpoint figures, such as other wind farms, are included in the detailed written descriptions of viewpoints in the LVIA report.

Visualisations are prepared in accordance with the SNH best practice guidance as far as practical and SNH's best practice guidance recommends that the following information on the limitations of visualisations is included in all LVIA methodologies:

"Visualisations of wind farms have a number of limitations which you should be aware of when using them to form a judgement on a wind farm proposal. These include:

- A visualisation can never show exactly what the wind farm will look like in reality due to factors such as: different lighting, weather and seasonal conditions which vary through time and the resolution of the image;
- The images provided give a reasonable impression of the scale of the turbines and the distance to the turbines, but can never be 100% accurate;
- A static image cannot convey turbine movement, or flicker or reflection from the sun on the turbine blades as they move;
- The viewpoints illustrated are representative of views in the area, but cannot represent visibility at all locations;
- To form the best impression of the impacts of the wind farm proposal these images are best viewed at the viewpoint location shown:
- The images must be printed at the right size to be viewed properly (The visualisations in this LVIA are 130 mm x 42 mm at A3); You should hold the images flat at a comfortable arm's length. If viewing these images on a wall or board at an exhibition, you should stand at arm's length from the image presented to gain the best impression.
- It is preferable to view printed images rather than view images on screen. If you do view images on screen you should do so using a normal PC screen with the image enlarged to the full screen height to give a realistic impression. Do not use a tablet or other device with a smaller screen to view the visualisations described in this guidance."




#### MAGHERAMORE WIND FARM

FIGURES 4.13 - 4.33

#### **VIEWPOINT VISUALISATION FIGURES**



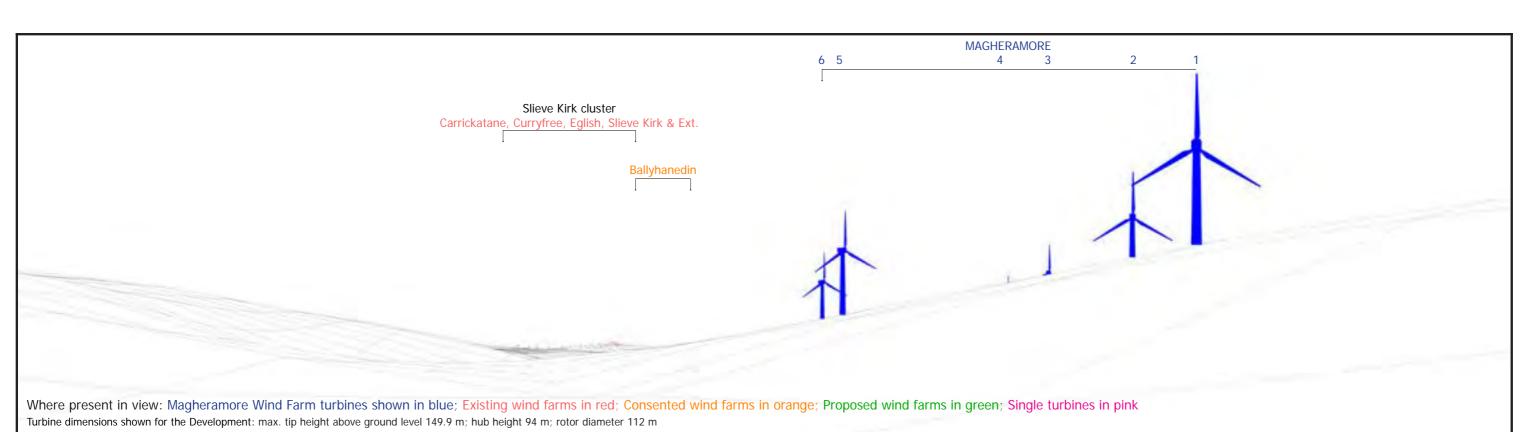LANDSCAPE AND VISUAL IMPACT ASSESSMENT



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## LANDSCAPE AND VISUAL IMPACT ASSESSMENT

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#### **MAGHERAMORE WIND FARM**


FIGURE 4.13 (page 1/2)

# VIEWPOINT 1, WIRELINE & PHOTOMONTAGE ALTNAHEGLISH DAM, BANAGHER FOREST

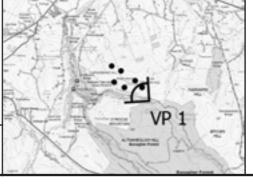Easting: 269567
Northing: 404185
Elevation A.O.D 256 m
Bearing: 308.1 °
Approx. Included Angle: 80 °

Approx. distance to nearest

turbine: 0.52 km to T1







Visible in the wider view to left-hand side:

Monaboy: Ballyhanedin; Barr Cregg

Altahullion
cluster

Dunbeg, Dunmore;
Dunbeg South
Rigged Hill
Rigged

Where present in view: Magheramore Wind Farm turbines shown in blue; Existing wind farms in red; Consented wind farms in orange; Proposed wind farms in green; Single turbines in pink
Turbine dimensions shown for the Development: max. tip height above ground level 149.9 m; hub height 94 m; rotor diameter 112 m

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FIGURE 4.14 (page 1/2)

VIEWPOINT 2, WIRELINE & PHOTOMONTAGE NORTH SPERRINS SCENIC DRIVE, B40 GLENEDRA ROAD Easting: 266432
Northing: 402728
Elevation A.O.D 230 m
Bearing: 44.4 °
Approx. Included Angle: 80 °

Approx. distance to nearest

turbine: 2.83 km to T6





Proposed removal of forestry near T4 & T3



Shanti McAllister landscape planning and design

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LANDSCAPE AND VISUAL **IMPACT ASSESSMENT** 

June 2019

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**MAGHERAMORE WIND FARM** 

FIGURE 4.14 (page 2/2)

**VIEWPOINT 2, BASELINE PHOTOGRAPH** NORTH SPERRINS SCENIC DRIVE, **B40 GLENEDRA ROAD** 

266432 Easting: 402728 Northing: Elevation A.O.D 230 m Bearing: 44.4 ° Approx. Included Angle: ° 08

Approx. distance to nearest

turbine: 2.83 km to T6





Visible to left-hand side:

Rigged Hill; Dunmore II; Dunbeg South Visible in the wider view / in other directions:

Loughermore Cluster; Altahullion & Glenconway

Ballyhanedin

Craiggor

Evishagarai

MAGHERAMORE 4 3 26 51

1 1 11

Where present in view: Magheramore Wind Farm turbines shown in blue; Existing wind farms in red; Consented wind farms in orange; Proposed wind farms in green; Single turbines in pink
Turbine dimensions shown for the Development: max. tip height above ground level 149.9 m; hub height 94 m; rotor diameter 112 m

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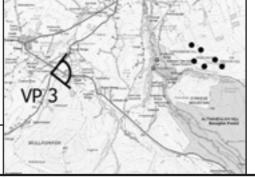
VIEWPOINT 3, WIRELINE & PHOTOMONTAGE FINCARN CROSSROADS AT B40 - B44 JUNCTION

FIGURE 4.15 (page 1/2)

Easting: 263667
Northing: 404445
Elevation A.O.D 135 m
Bearing: 84.36 °
Approx. Included Angle: 70 °

Approx. distance to nearest

turbine: 4.71 km to T4





No visible changes to forestry from this location



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#### MAGHERAMORE WIND FARM


FIGURE 4.15 (page 2/2)

VIEWPOINT 3, BASELINE PHOTOGRAPH FINCARN CROSSROADS AT B40 - B44 JUNCTION


Easting: 263667
Northing: 404445
Elevation A.O.D 135 m
Bearing: 84.36 °
Approx. Included Angle: 70 °

Approx. distance to nearest

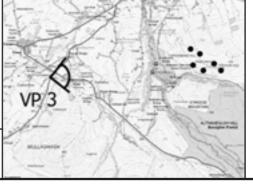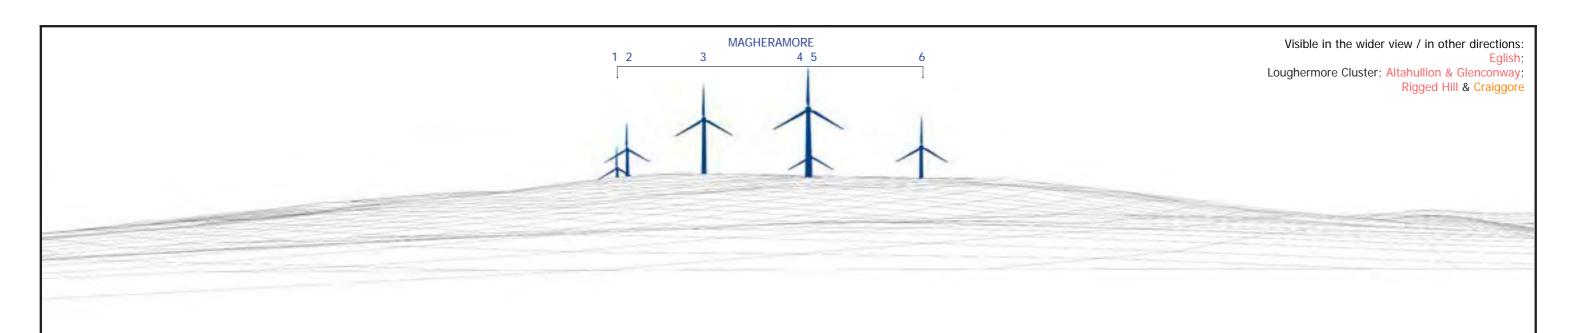turbine: 4.71 km to T4







Where present in view: Magheramore Wind Farm turbines shown in blue; Existing wind farms in red; Consented wind farms in orange; Proposed wind farms in green; Single turbines in pink
Turbine dimensions shown for the Development: max. tip height above ground level 149.9 m; hub height 94 m; rotor diameter 112 m

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### **MAGHERAMORE WIND FARM**

FIGURE 4.16 (page 1/2)

## VIEWPOINT 4, WIRELINE & PHOTOMONTAGE BANAGHER OLD CHURCH

Easting: 267509
Northing: 406593
Elevation A.O.D 140 m
Bearing: 144.43 °
Approx. Included Angle: 80 °

Approx. distance to nearest

turbine: 1.49 km to T4





Proposed removal of forestry near T4

Proposed removal of forestry near T3



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#### **MAGHERAMORE WIND FARM**

FIGURE 4.16 (page 2/2)

## VIEWPOINT 4, BASELINE PHOTOGRAPH BANAGHER OLD CHURCH

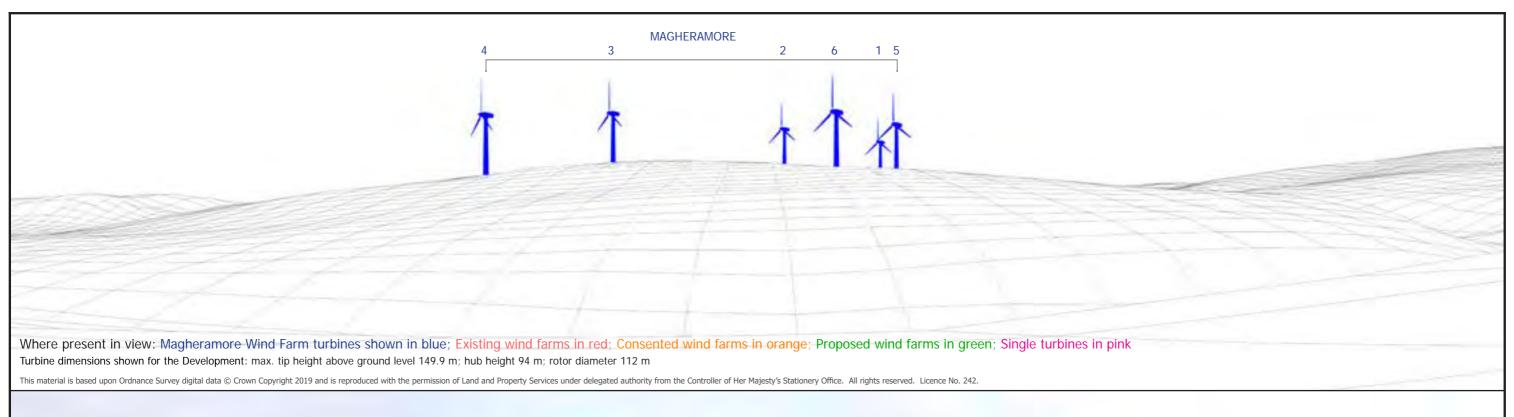
Easting: 267509
Northing: 406593
Elevation A.O.D 140 m
Bearing: 144.43 °
Approx. Included Angle: 80 °

Approx. Included Angle:
Approx. distance to nearest

turbine: 1.49 km to T4









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### **MAGHERAMORE WIND FARM**

FIGURE 4.17 (page 1/2)


## VIEWPOINT 5, WIRELINE & PHOTOMONTAGE BANAGHER ROAD

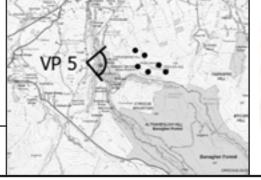Easting: 266634
Northing: 404918
Elevation A.O.D 179 m
Bearing: 89.53 °
Approx. Included Angle: 70 °

Approx. distance to nearest

NOTE: This Figure should be viewed at a comfortable arms length. It will be viewed in conjunction with the analysis of landscape and visual effects contained in Chapter 4 of the Environmental Statement and the detailed methodology for the preparation of visualisations contained in Technical Appendix 4.2, in particular the paragraphs referencing Scottish Natural Heritage Guidance regarding the limitations of visualisations.

turbine: 1.71 km to T4





Proposed removal of forestry at T4

Proposed removal of forestry in front of T3



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## LANDSCAPE AND VISUAL IMPACT ASSESSMENT

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MAGHERAMORE WIND FARM

FIGURE 4.17 (page 2/2)


VIEWPOINT 5, BASELINE PHOTOGRAPH BANAGHER ROAD Easting: 266634
Northing: 404918
Elevation A.O.D 179 m
Bearing: 89.53 °
Approx. Included Angle: 70 °

Approx. distance to nearest

turbine: 1.71 km to T4

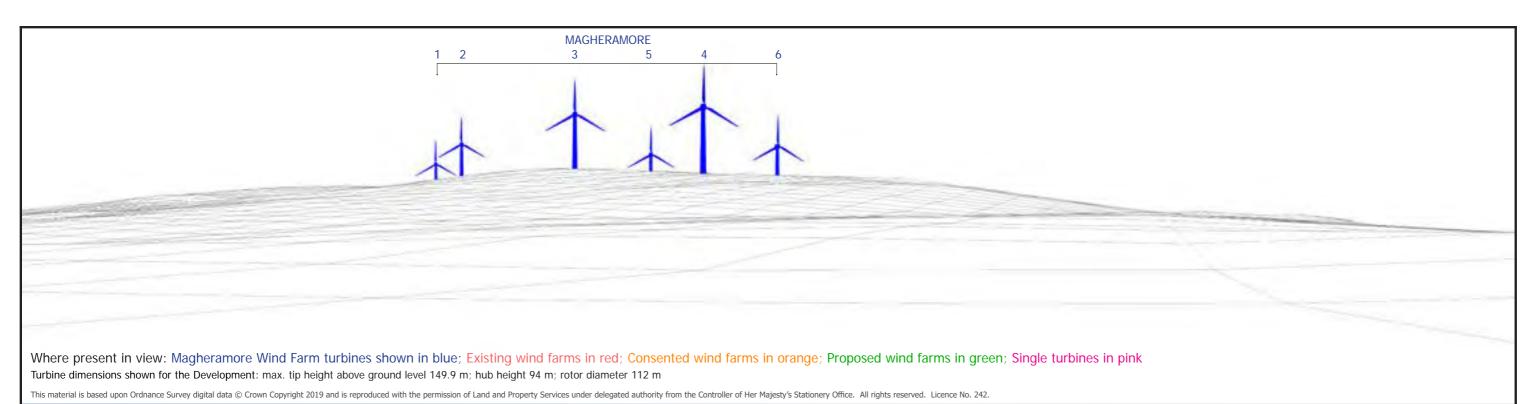VP 5







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#### MAGHERAMORE WIND FARM


FIGURE 4.18 (page 1/2)

## VIEWPOINT 6, WIRELINE & PHOTOMONTAGE MAGHERAMORE ROAD NEAR SITE ENTRANCE

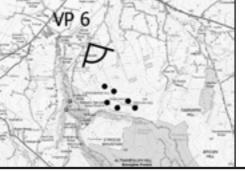Easting: 267707
Northing: 406752
Elevation A.O.D 115 m
Bearing: 153.18 °
Approx. Included Angle: 80 °

Approx. distance to nearest

turbine: 1.54 km to T4





Proposed removal of forestry near T3



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## LANDSCAPE AND VISUAL IMPACT ASSESSMENT

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### MAGHERAMORE WIND FARM

FIGURE 4.18 (page 2/2)


## VIEWPOINT 6, BASELINE PHOTOGRAPH MAGHERAMORE ROAD NEAR SITE ENTRANCE

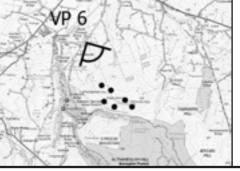Easting: 267707
Northing: 406752
Elevation A.O.D 115 m
Bearing: 153.18 °
Approx. Included Angle: 80 °

Approx. distance to nearest

NOTE: This Figure should be viewed at a comfortable arms length. It will be viewed in conjunction with the analysis of landscape and visual effects contained in Chapter 4 of the Environmental Statement and the detailed methodology for the preparation of visualisations contained in Technical Appendix 4.2, in particular the paragraphs referencing Scottish Natural Heritage Guidance regarding the limitations of visualisations.

turbine: 1.54 km to T4







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MAGHERAMORE WIND FARM

FIGURE 4.19 (page 1/2)

VIEWPOINT 7, WIRELINE & PHOTOMONTAGE CREEBARKY - TEEAVAN ROAD JUNCTION

Easting: 270175
Northing: 406757
Elevation A.O.D 174 m
Bearing: 218.23 °
Approx. Included Angle: 75 °

Approx. distance to nearest

NOTE: This Figure should be viewed at a comfortable arms length. It will be viewed in conjunction with the analysis of landscape and visual effects contained in Chapter 4 of the Environmental Statement and the detailed methodology for the preparation of visualisations contained in Technical Appendix 4.2, in particular the paragraphs referencing Scottish Natural Heritage Guidance regarding the limitations of visualisations.

turbine: 2.20 km to T2





No visible changes to forestry from this location



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LANDSCAPE AND VISUAL **IMPACT ASSESSMENT** 

June 2019

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MAGHERAMORE WIND FARM

FIGURE 4.19 (page 2/2)

**VIEWPOINT 7, BASELINE PHOTOGRAPH CREEBARKY - TEEAVAN ROAD JUNCTION** 

270175 Easting: 406757 Northing: Elevation A.O.D 174 m Bearing: 218.23 ° Approx. Included Angle: 75 °

Approx. distance to nearest

NOTE: This Figure should be viewed at a comfortable arms length. It will be viewed in conjunction with the analysis of landscape and visual effects contained in Chapter 4 of the Environmental Statement and the detailed methodology for the preparation of visualisations contained in Technical Appendix 4.2, in particular the paragraphs referencing Scottish Natural Heritage Guidance regarding the limitations of visualisations.

turbine: 2.20 km to T2







Where present in view: Magheramore Wind Farm turbines shown in blue; Existing wind farms in red; Consented wind farms in orange; Proposed wind farms in green; Single turbines in pink
Turbine dimensions shown for the Development: max. tip height above ground level 149.9 m; hub height 94 m; rotor diameter 112 m

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#### MAGHERAMORE WIND FARM

FIGURE 4.20 (page 1/2)

# VIEWPOINT 8, WIRELINE & PHOTOMONTAGE TEEAVAN ROAD TO NORTH EAST OF SITE

Easting: 268679
Northing: 407379
Elevation A.O.D 132 m
Bearing: 179.14 °
Approx. Included Angle: 80 °

Approx. distance to nearest

NOTE: This Figure should be viewed at a comfortable arms length. It will be viewed in conjunction with the analysis of landscape and visual effects contained in Chapter 4 of the Environmental Statement and the detailed methodology for the preparation of visualisations contained in Technical Appendix 4.2, in particular the paragraphs referencing Scottish Natural Heritage Guidance regarding the limitations of visualisations.

turbine: 2.08 km to T4





Proposed removal of forestry near T3

Proposed removal of forestry near T4



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MAGHERAMORE WIND FARM


FIGURE 4.20 (page 2/2)

VIEWPOINT 8, BASELINE PHOTOGRAPH TEEAVAN ROAD TO NORTH EAST OF SITE


Easting: 268679
Northing: 407379
Elevation A.O.D 132 m
Bearing: 179.14 °
Approx. Included Angle: 80 °

Approx. distance to nearest

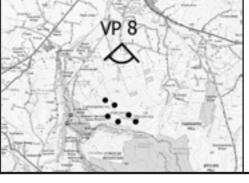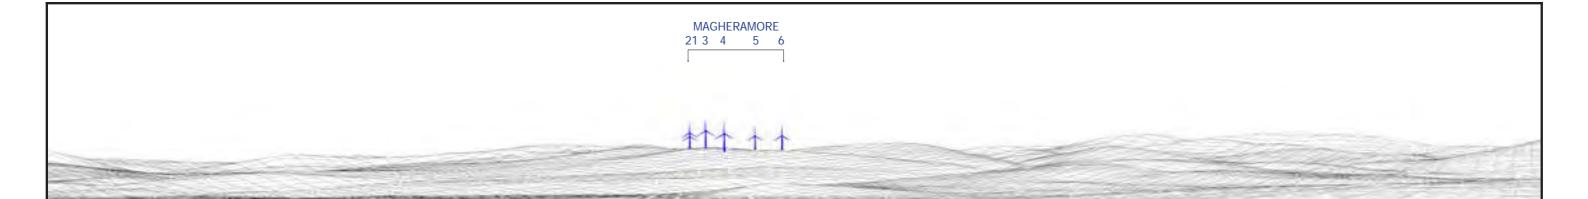turbine: 2.08 km to T4







Where present in view: Magheramore Wind Farm turbines shown in blue; Existing wind farms in red; Consented wind farms in orange; Proposed wind farms in green; Single turbines in pink Turbine dimensions shown for the Development: max. tip height above ground level 149.9 m; hub height 94 m; rotor diameter 112 m

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### **MAGHERAMORE WIND FARM**

FIGURE 4.21 (page 1/2)

### **VIEWPOINT 9, WIRELINE & PHOTOMONTAGE KILLUNAGHT ROAD, A6 NEAR DUNGIVEN**

264590 Easting: Northing: 409150 Elevation A.O.D 126 m Bearing: 136.5 ° Approx. Included Angle: 75 °

Approx. distance to nearest

turbine: 5.32 km to T4





Proposed removal of forestry behind T3



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### MAGHERAMORE WIND FARM

FIGURE 4.21 (page 2/2)

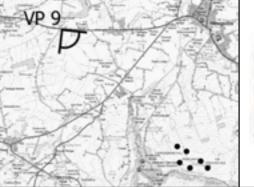
VIEWPOINT 9, BASELINE PHOTOGRAPH KILLUNAGHT ROAD, A6 NEAR DUNGIVEN

Easting: 264590
Northing: 409150
Elevation A.O.D 126 m
Bearing: 136.5 °
Approx. Included Angle: 75 °

Approx. distance to nearest

NOTE: This Figure should be viewed at a comfortable arms length. It will be viewed in conjunction with the analysis of landscape and visual effects contained in Chapter 4 of the Environmental Statement and the detailed methodology for the preparation of visualisations contained in Technical Appendix 4.2, in particular the paragraphs referencing Scottish Natural Heritage Guidance regarding the limitations of visualisations.

turbine: 5.32 km to T4





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MAGHERAMORE WIND FARM

FIGURE 4.22 (page 1/2)

VIEWPOINT 10, WIRELINE & PHOTOMONTAGE DUNGIVEN, BRIDGE OVER RIVER ROE

Easting: 268455
Northing: 409530
Elevation A.O.D 63 m
Bearing: 176.77 °
Approx. Included Angle: 80 °

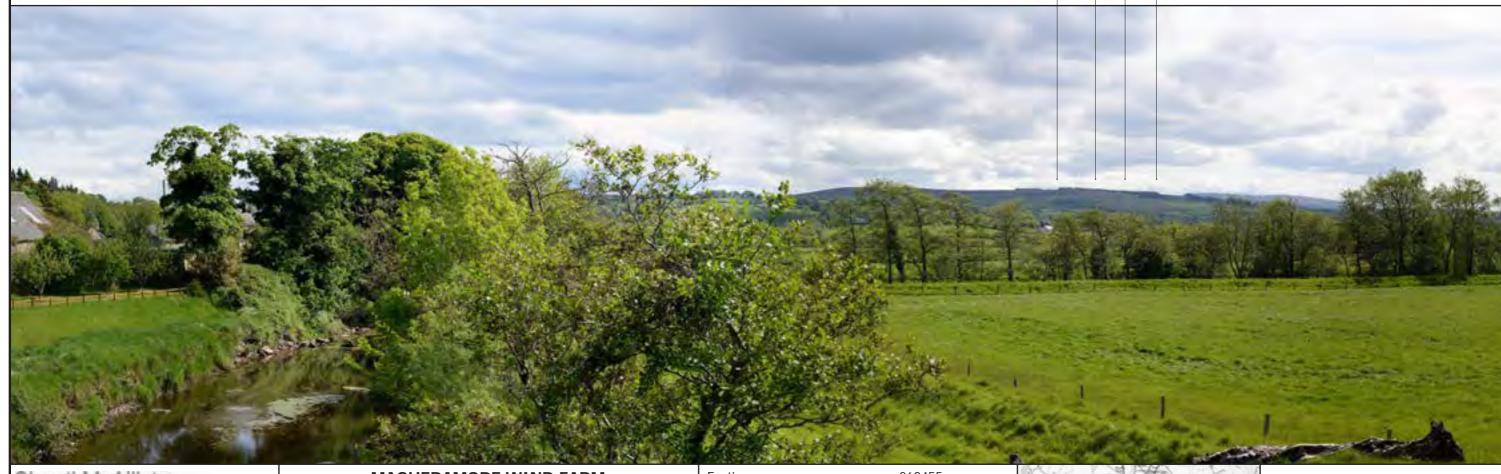
Approx. distance to nearest

turbine: 4.2 km to T4





Proposed removal of forestry near T3 & T4



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**MAGHERAMORE WIND FARM** 

FIGURE 4.22 (page 2/2)

**VIEWPOINT 10, BASELINE PHOTOGRAPH** DUNGIVEN, BRIDGE OVER RIVER ROE

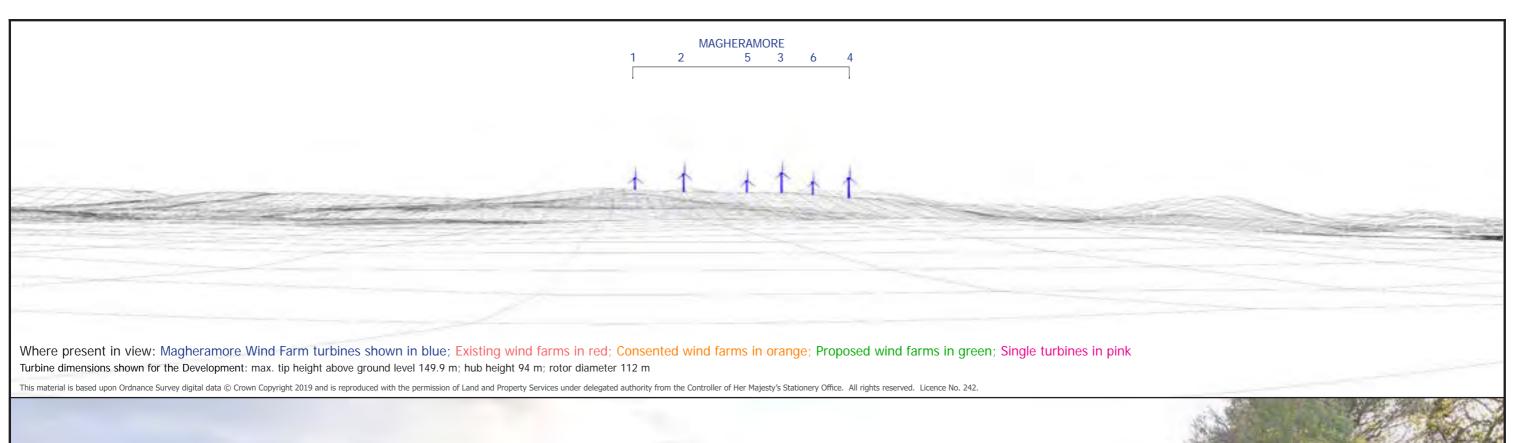
268455 409530 Easting: Northing: Elevation A.O.D 63 m Bearing: 176.77 ° Approx. Included Angle: ° 08

Approx. distance to nearest

turbine: 4.2 km to T4









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MAGHERAMORE WIND FARM

FIGURE 4.23 (page 1/2)

VIEWPOINT 11, WIRELINE & PHOTOMONTAGE B64, GARVAGH ROAD, DUNGIVEN

Easting: 269392
Northing: 410211
Elevation A.O.D 81 m
Bearing: 188.4 °
Approx. Included Angle: 75 °

Approx. distance to nearest

NOTE: This Figure should be viewed at a comfortable arms length. It will be viewed in conjunction with the analysis of landscape and visual effects contained in Chapter 4 of the Environmental Statement and the detailed methodology for the preparation of visualisations contained in Technical Appendix 4.2, in particular the paragraphs referencing Scottish Natural Heritage Guidance regarding the limitations of visualisations.

turbine: 5.00 km to T4





Proposed removal of forestry near T3, T6 & T4



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### LANDSCAPE AND VISUAL IMPACT ASSESSMENT

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MAGHERAMORE WIND FARM

FIGURE 4.23 (page 2/2)

VIEWPOINT 11, BASELINE PHOTOGRAPH B64, GARVAGH ROAD, DUNGIVEN Easting: 269392
Northing: 410211
Elevation A.O.D 81 m
Bearing: 188.4 °
Approx. Included Angle: 75 °

Approx. distance to nearest

NOTE: This Figure should be viewed at a comfortable arms length. It will be viewed in conjunction with the analysis of landscape and visual effects contained in Chapter 4 of the Environmental Statement and the detailed methodology for the preparation of visualisations contained in Technical Appendix 4.2, in particular the paragraphs referencing Scottish Natural Heritage Guidance regarding the limitations of visualisations.

turbine: 5.00 km to T4





Slieve Kirk Cluster: Loughermore Cluster: Slieve Kirk & Ext; Eglish; Altahullion I & II; Glenconway & Ext. Curryfree; Carrickatane Where present in view: Magheramore Wind Farm turbines shown in blue; Existing wind farms in red; Consented wind farms in orange; Proposed wind farms in green; Single turbines in pink Turbine dimensions shown for the Development: max. tip height above ground level 149.9 m; hub height 94 m; rotor diameter 112 m This material is based upon Ordnance Survey digital data @ Crown Copyright 2019 and is reproduced with the permission of Land and Property Services under delegated authority from the Controller of Her Majesty's Stationery Office. All rights reserved. Licence No. 242. Shanti McAllister MAGHERAMORE WIND FARM 276459 Easting: Northing: 406159 landscape planning and design Elevation A.O.D 235 m FIGURE 4.24 (page 1/2) www.shantimcallister.co.uk info@shantimcallister.co.uk Bearing: 261.11° **VIEWPOINT 12, WIRELINE & PHOTOMONTAGE** Approx. Included Angle: 75 ° LANDSCAPE AND VISUAL A6 AT FP McCANN QUARRY **IMPACT ASSESSMENT** Approx. distance to nearest turbine: 7.33 km to T1 June 2019 THIS DRAWING IS THE PROPERTY OF RENEWABLE ENERGY SYSTEMS LTD. AND NO REPRODUCTION MAY BE MADE IN WHOLE OR IN PART WITHOUT PERMISSION NOTE: This Figure should be viewed at a comfortable arms length. It will be viewed in conjunction with the analysis of landscape and visual effects contained in Chapter 4 of the Environmental Statement and the detailed methodology for the preparation of visualisations contained in Technical Appendix 4.2, in particular the paragraphs referencing Scottish Natural Heritage Guidance regarding the limitations of visualisations.

No visible changes to forestry from this location



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LANDSCAPE AND VISUAL **IMPACT ASSESSMENT** 

June 2019

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FIGURE 4.24 (page 2/2)

**VIEWPOINT 12, BASELINE PHOTOGRAPH A6 AT FP McCANN QUARRY** 

276459 Easting: 406159 Northing: Elevation A.O.D 235 m Bearing: 261.11° Approx. Included Angle: 75 °

Approx. distance to nearest

turbine: 7.33 km to T1





MAGHERAMORE 1 5 2 6 3 4

Slieve Kirk Cluster (Eglish, Carrickatane, Slievekirk & Ext, Curryfree)

Ballyhanedin

Barr Cregg

Where present in view: Magheramore Wind Farm turbines shown in blue; Existing wind farms in red; Consented wind farms in orange; Proposed wind farms in green; Single turbines in pink Turbine dimensions shown for the Development: max. tip height above ground level 149.9 m; hub height 94 m; rotor diameter 112 m

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#### **MAGHERAMORE WIND FARM**

FIGURE 4.25 (page 1/2)

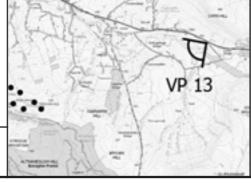
# VIEWPOINT 13, WIRELINE & PHOTOMONTAGE A6 AT CORICK ROAD JUNCTION

Easting: 274600
Northing: 406750
Elevation A.O.D 202 m
Bearing: 253.15 °
Approx. Included Angle: 80 °

Approx. distance to nearest

NOTE: This Figure should be viewed at a comfortable arms length. It will be viewed in conjunction with the analysis of landscape and visual effects contained in Chapter 4 of the Environmental Statement and the detailed methodology for the preparation of visualisations contained in Technical Appendix 4.2, in particular the paragraphs referencing Scottish Natural Heritage Guidance regarding the limitations of visualisations.

turbine: 5.72 km to T1





No visible changes to forestry from this location



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#### LANDSCAPE AND VISUAL **IMPACT ASSESSMENT**

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### **MAGHERAMORE WIND FARM**


FIGURE 4.25 (page 2/2)

### **VIEWPOINT 13, BASELINE PHOTOGRAPH** A6 AT CORICK ROAD JUNCTION

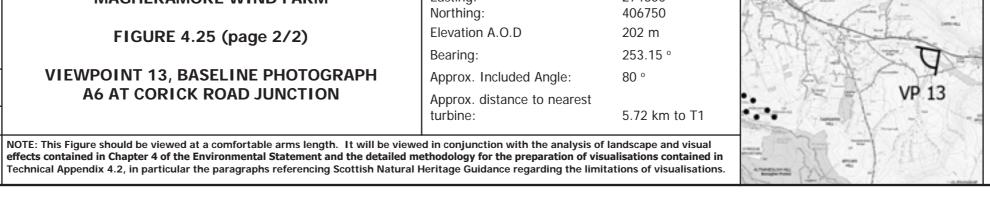Easting: 274600 Northing: 406750 Elevation A.O.D 202 m Bearing: 253.15° Approx. Included Angle: ° 08

Approx. distance to nearest

turbine: 5.72 km to T1





MAGHERAMORE
1 5 2 6 3 4

Slieve Kirk Cluster (Eglish, Carrickatane, Slievekirk & Ext, Curryfree)

Ballyhanedin

Where present in view: Magheramore Wind Farm turbines shown in blue; Existing wind farms in red; Consented wind farms in orange; Proposed wind farms in green; Single turbines in pink Turbine dimensions shown for the Development: max. tip height above ground level 149.9 m; hub height 94 m; rotor diameter 112 m

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### **MAGHERAMORE WIND FARM**

FIGURE 4.26 (page 1/2)


# VIEWPOINT 14, WIRELINE & PHOTOMONTAGE A6 AT CASHEL ROAD JUNCTION

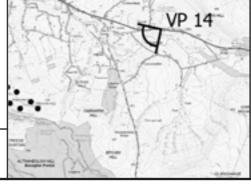Easting: 273271
Northing: 407167
Elevation A.O.D 185 m
Bearing: 243.5 °
Approx. Included Angle: 75 °

Approx. distance to nearest


NOTE: This Figure should be viewed at a comfortable arms length. It will be viewed in conjunction with the analysis of landscape and visual effects contained in Chapter 4 of the Environmental Statement and the detailed methodology for the preparation of visualisations contained in Technical Appendix 4.2, in particular the paragraphs referencing Scottish Natural Heritage Guidance regarding the limitations of visualisations.

turbine: 4.72 km to T1





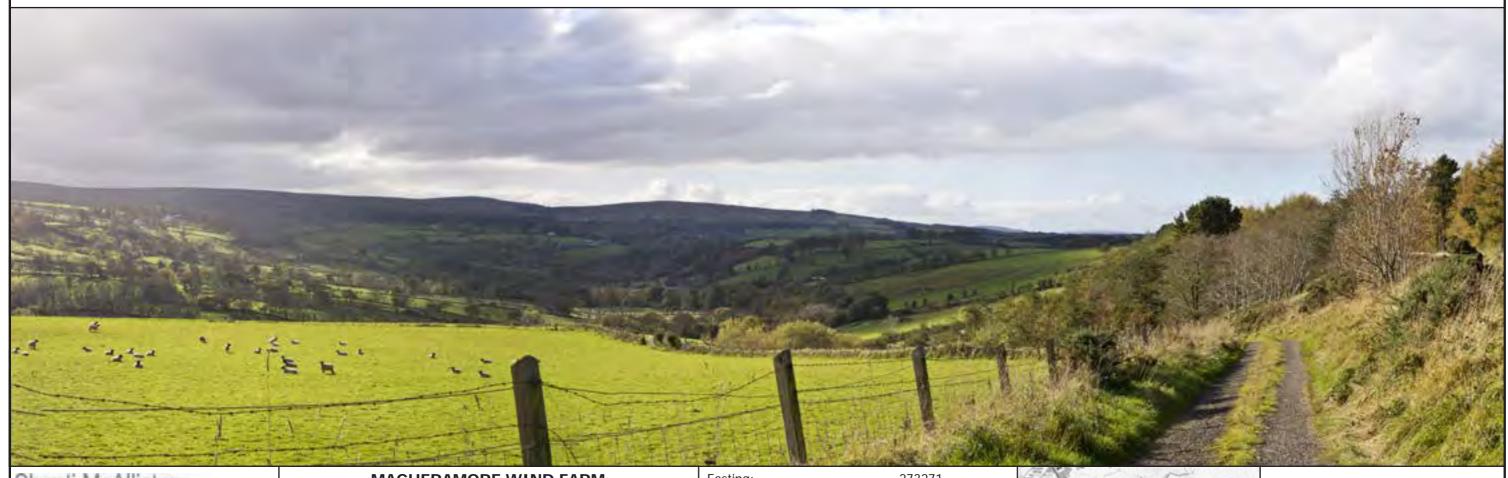No visible changes to forestry from this location



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### **MAGHERAMORE WIND FARM**

FIGURE 4.26 (page 2/2)


### **VIEWPOINT 14, BASELINE PHOTOGRAPH A6 AT CASHEL ROAD JUNCTION**

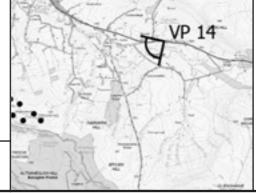273271 Easting: 407167 Northing: Elevation A.O.D 185 m Bearing: 243.5 ° Approx. Included Angle: 75 °

Approx. distance to nearest

NOTE: This Figure should be viewed at a comfortable arms length. It will be viewed in conjunction with the analysis of landscape and visual effects contained in Chapter 4 of the Environmental Statement and the detailed methodology for the preparation of visualisations contained in Technical Appendix 4.2, in particular the paragraphs referencing Scottish Natural Heritage Guidance regarding the limitations of visualisations.

turbine: 4.72 km to T1





Visible to right-hand side: MAGHERAMORE Altahullion cluster Owenreagh I & II; Craignagapple Slieve Kirk Cluster (Eglish, Carrickatane, Slievekirk & Ext, Curryfree) Ballyhanedin Where present in view: Magheramore Wind Farm turbines shown in blue; Existing wind farms in red; Consented wind farms in orange; Proposed wind farms in green; Single turbines in pink Turbine dimensions shown for the Development: max. tip height above ground level 149.9 m; hub height 94 m; rotor diameter 112 m This material is based upon Ordnance Survey digital data @ Crown Copyright 2019 and is reproduced with the permission of Land and Property Services under delegated authority from the Controller of Her Majesty's Stationery Office. All rights reserved. Licence No. 242. Shanti McAllister MAGHERAMORE WIND FARM 272732 Easting: 410267 Northing: landscape planning and design Elevation A.O.D 390 m FIGURE 4.27 (page 1/2) info@shantimcallister.co.uk www.shantimcallister.co.uk **VIEWPOINT 15, WIRELINE & PHOTOMONTAGE** Bearing: 217.68 ° **BENBRADAGH MOUNTAIN** Approx. Included Angle: 80 ° LANDSCAPE AND VISUAL **IMPACT ASSESSMENT** Approx. distance to nearest turbine: 6.54 km to T2 June 2019 THIS DRAWING IS THE PROPERTY OF RENEWABLE ENERGY SYSTEMS LTD. AND NO REPRODUCTION MAY BE MADE IN WHOLE OR IN PART WITHOUT PERMISSION NOTE: This Figure should be viewed at a comfortable arms length. It will be viewed in conjunction with the analysis of landscape and visual effects contained in Chapter 4 of the Environmental Statement and the detailed methodology for the preparation of visualisations contained in Technical Appendix 4.2, in particular the paragraphs referencing Scottish Natural Heritage Guidance regarding the limitations of visualisations.

Proposed removal of forestry near T4

Proposed removal of forestry near T3



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MAGHERAMORE WIND FARM

FIGURE 4.27 (page 2/2)

VIEWPOINT 15, BASELINE PHOTOGRAPH BENBRADAGH MOUNTAIN Easting: 272732
Northing: 410267
Elevation A.O.D 390 m
Bearing: 217.68 °
Approx. Included Angle: 80 °

Approx. distance to nearest

turbine: 6.54 km to T2



Binevenagh Cluster: Dunbeg; Dunmore; Dunbeg South

Rigged Hill Cluster:

Craiggore & Smulgedon

MAGHERAMORE
4 3 6 2 5 1

Carntogher Cluster:

Evishagaran

Corlacky Hill

Ballyhanedin

Where present in view: Magheramore Wind Farm turbines shown in blue; Existing wind farms in red; Consented wind farms in orange; Proposed wind farms in green; Single turbines in pink Turbine dimensions shown for the Development: max. tip height above ground level 149.9 m; hub height 94 m; rotor diameter 112 m

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MAGHERAMORE WIND FARM

FIGURE 4.28 (page 1/2)

VIEWPOINT 16, WIRELINE & PHOTOMONTAGE PLANTATION ROAD NEAR PARK

Easting: 258109
Northing: 401347
Elevation A.O.D 240 m
Bearing: 71.6 °
Approx. Included Angle: 70 °

Approx. distance to nearest

turbine: 10.82km to T6





Proposed removal of forestry at T4

Proposed removal of forestry near T5



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**MAGHERAMORE WIND FARM** 

FIGURE 4.28 (page 2/2)

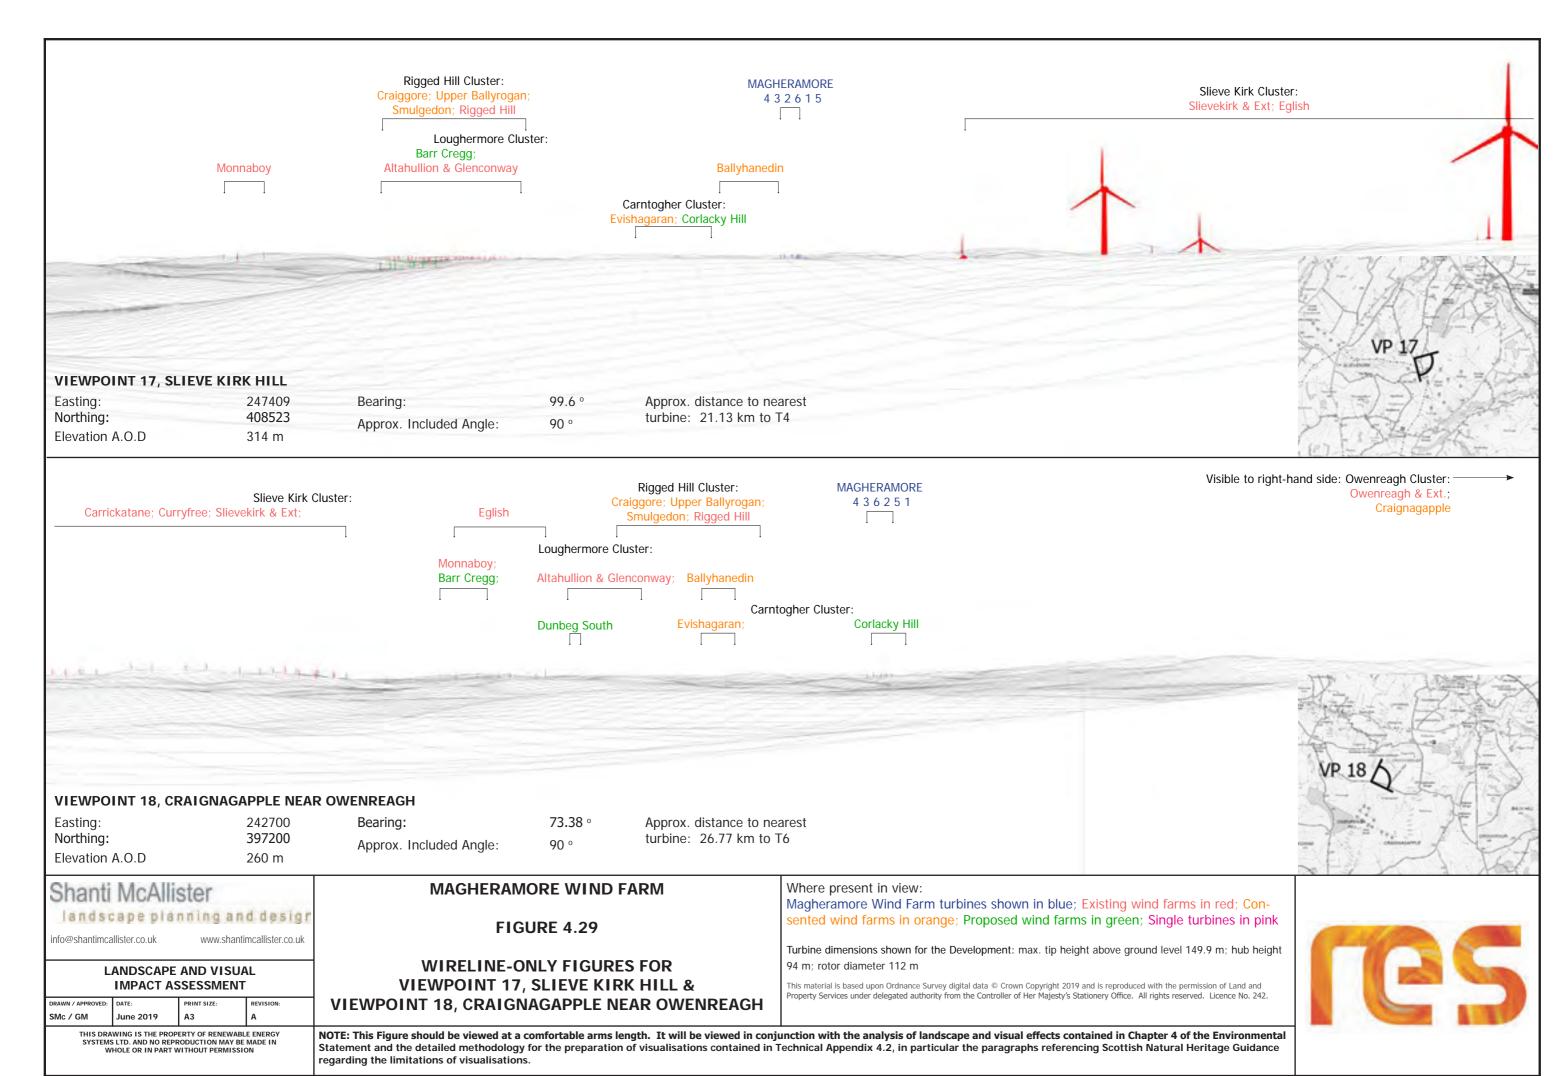
**VIEWPOINT 16, BASELINE PHOTOGRAPH** PLANTATION ROAD NEAR PARK

258109 Easting: 401347 Northing: Elevation A.O.D 240 m Bearing: 71.6 ° 70 ° Approx. Included Angle:

Approx. distance to nearest

turbine: 10.82km to T6





SMc/ 18 050 01.ind

Visible in the wider view / in other directions: Slievekirk cluster (existing)

Ballyhanedin

Loughermore cluster (existing elements)

Where present in view: Magheramore Wind Farm turbines shown in blue; Existing wind farms in red; Consented wind farms in orange; Proposed wind farms in green; Single turbines in pink
Turbine dimensions shown for the Development: max. tip height above ground level 149.9 m; hub height 94 m; rotor diameter 112 m

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#### MAGHERAMORE WIND FARM

FIGURE 4.30 (page 1/2)
VIEWPOINT 19, WIRELINE & PHOTOMONTAGE
KEADY MOUNTAIN

Easting: 272086
Northing: 424045
Elevation A.O.D 199 m
Bearing: 189.98 °
Approx. Included Angle: 75 °

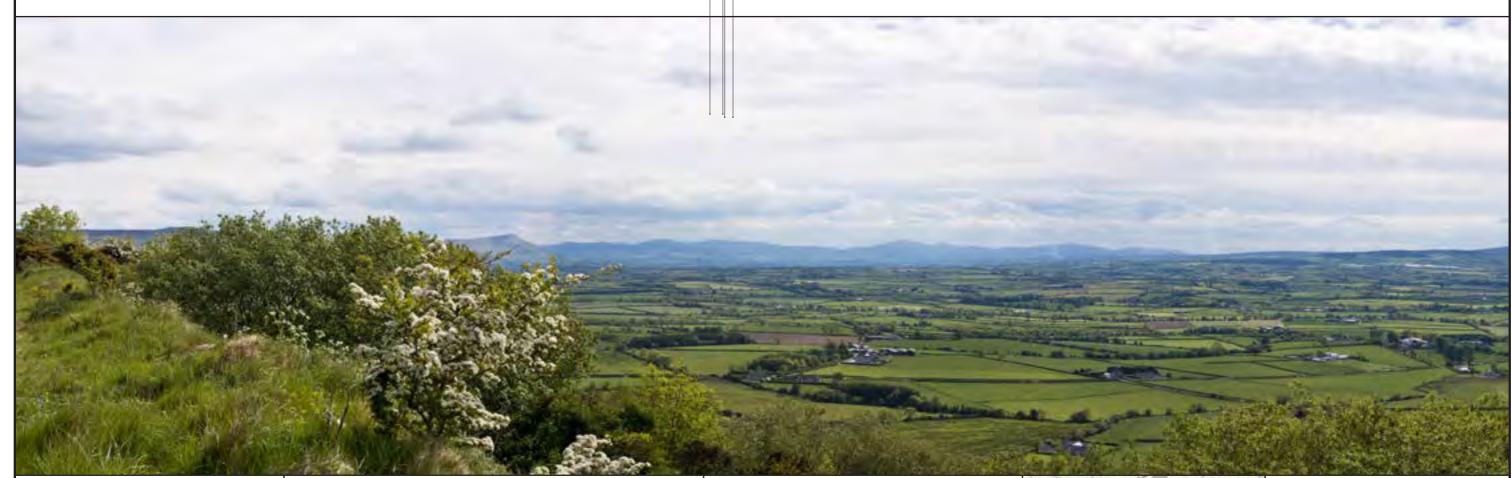
Approx. distance to nearest

turbine: 19.04 km to T4





Proposed removal of forestry T3 & T4



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#### MAGHERAMORE WIND FARM


FIGURE 4.30 (page 2/2)

### VIEWPOINT 19, BASELINE PHOTOGRAPH KEADY MOUNTAIN

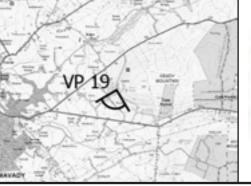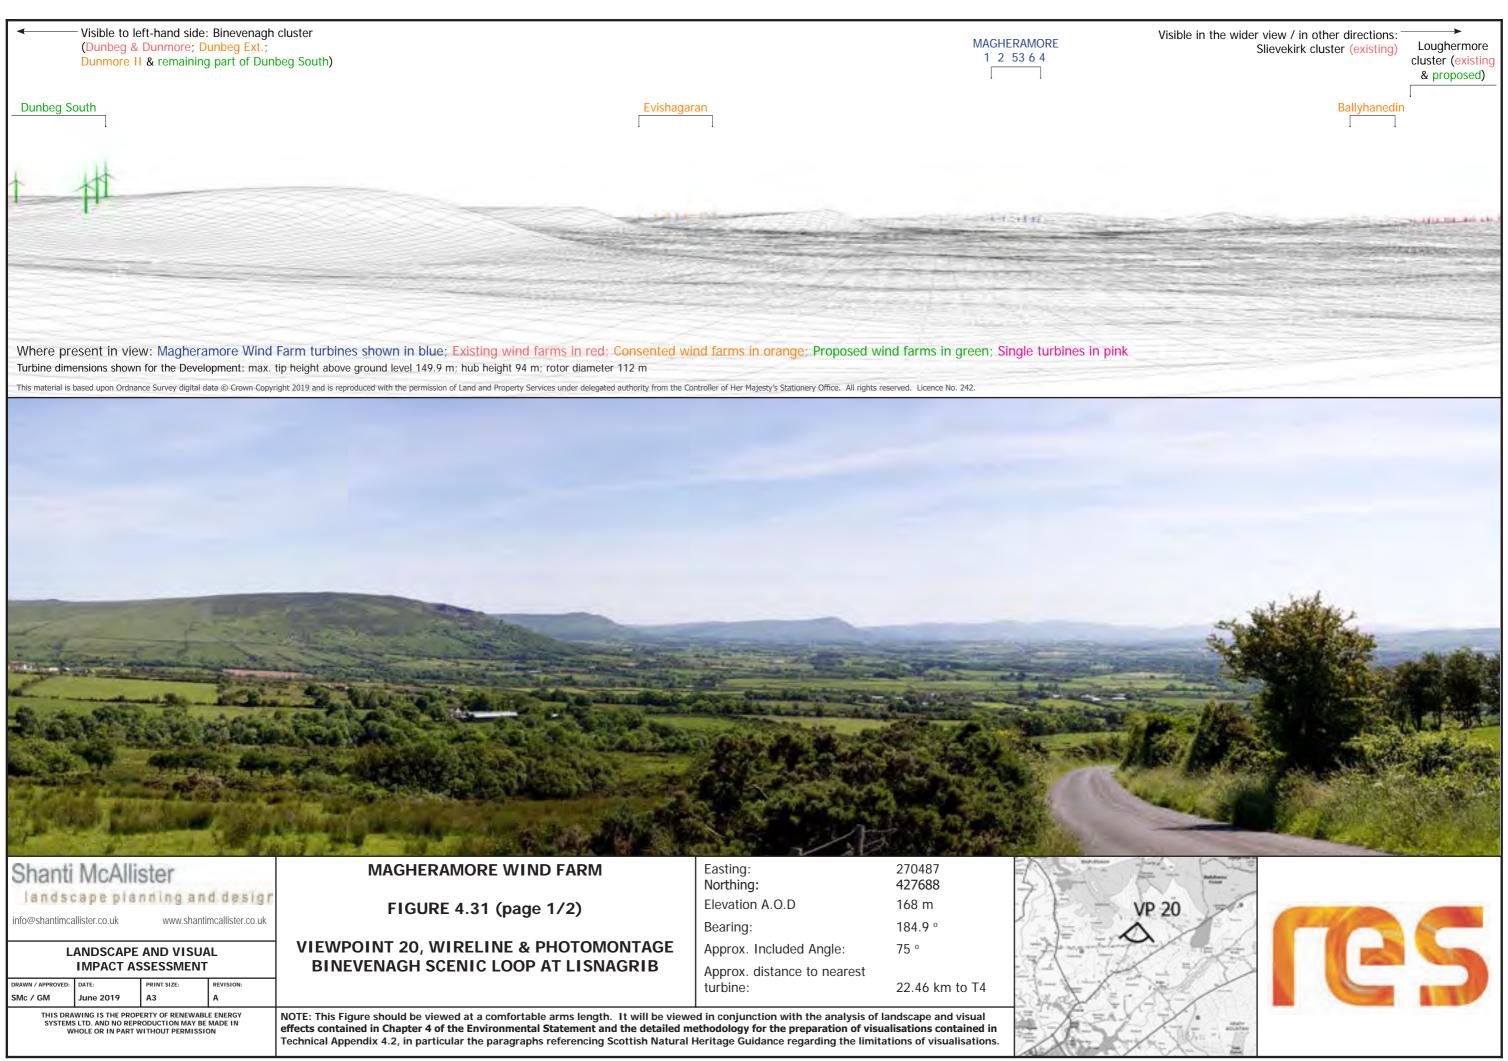
Easting: 272086
Northing: 424045
Elevation A.O.D 199 m
Bearing: 189.98 °
Approx. Included Angle: 75 °

Approx. distance to nearest

turbine: 19.04 km to T4







Proposed removal of forestry behind T3 & T4



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### MAGHERAMORE WIND FARM


FIGURE 4.31 (page 2/2)
VIEWPOINT 20, BASELINE PHOTOGRAPH
BINEVENAGH SCENIC LOOP AT LISNAGRIB

Easting: 270487
Northing: 427688
Elevation A.O.D 168 m
Bearing: 184.9 °
Approx. Included Angle: 75 °

Approx. distance to nearest

NOTE: This Figure should be viewed at a comfortable arms length. It will be viewed in conjunction with the analysis of landscape and visual effects contained in Chapter 4 of the Environmental Statement and the detailed methodology for the preparation of visualisations contained in Technical Appendix 4.2, in particular the paragraphs referencing Scottish Natural Heritage Guidance regarding the limitations of visualisations.

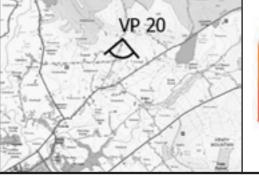turbine: 22.46 km to T4





Visible to left-hand side:

Rigged Hill Cluster: Rigged Hill; Craiggore; Smulgedon & Upper Balllyrogan Evishagaran MAGHERAMORE 21 3 4 5 6 Visible to right-hand side: Slieve Kirk Cluster: Eglish; Slievelirk & Ext.

Ballyhanedin

Visible in the wider view / in other directions: Altahullion & Glenconway

**\*** 

existing single turbine in foreground

Where present in view: Magheramore Wind Farm turbines shown in blue; Existing wind farms in red; Consented wind farms in orange; Proposed wind farms in green; Single turbines in pink
Turbine dimensions shown for the Development: max. tip height above ground level 149.9 m; hub height 94 m; rotor diameter 112 m

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#### MAGHERAMORE WIND FARM

FIGURE 4.32 (page 1/2)

# VIEWPOINT 21, WIRELINE & PHOTOMONTAGE DRUM ROAD NEAR ALTAHULLION

Easting: 263687
Northing: 409861
Elevation A.O.D 144 m
Bearing: 134.9 °
Approx. Included Angle: 75 °

Approx. distance to nearest

NOTE: This Figure should be viewed at a comfortable arms length. It will be viewed in conjunction with the analysis of landscape and visual effects contained in Chapter 4 of the Environmental Statement and the detailed methodology for the preparation of visualisations contained in Technical Appendix 4.2, in particular the paragraphs referencing Scottish Natural Heritage Guidance regarding the limitations of visualisations.

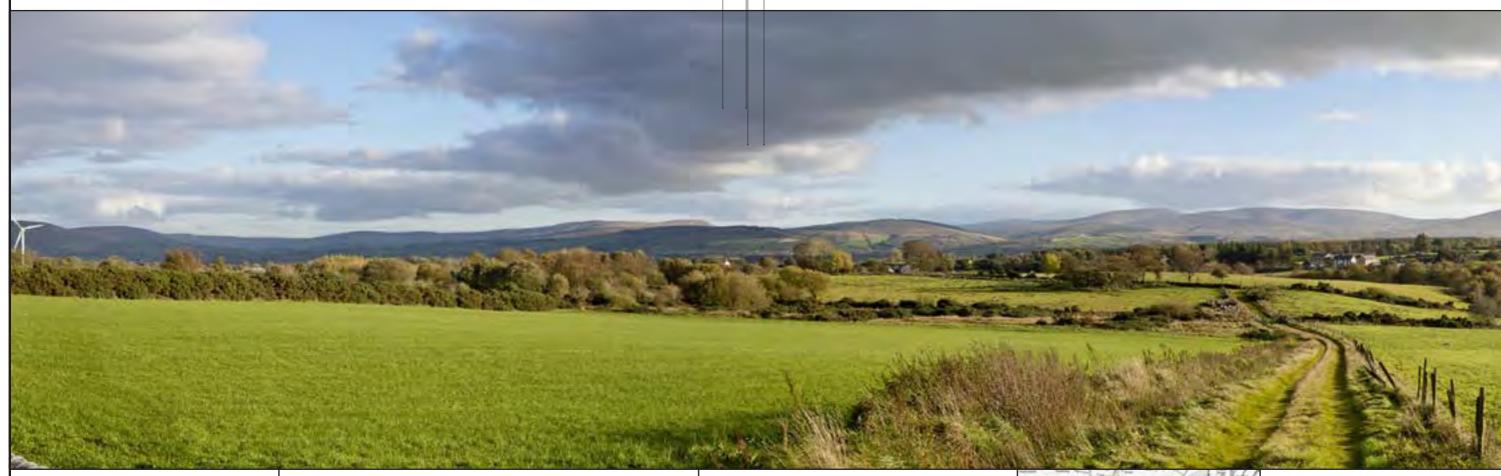
turbine: 6.46 km to T4





Proposed removal of forestry behind T1 - T3

> Proposed removal of forestry at T4



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MAGHERAMORE WIND FARM


FIGURE 4.32 (page 2/2)

**VIEWPOINT 21, BASELINE PHOTOGRAPH DRUM ROAD NEAR ALTAHULLION** 

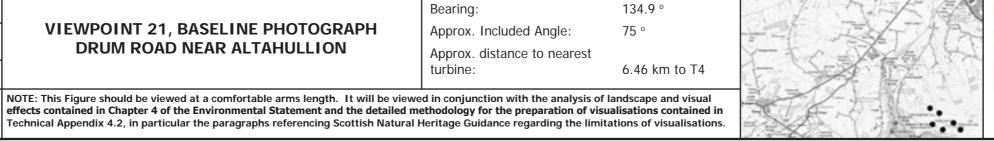Easting: 263687 Northing: 409861 Elevation A.O.D 144 m Bearing: 134.9 ° Approx. Included Angle: 75 °

Approx. distance to nearest

turbine: 6.46 km to T4





Where present in view: Magheramore Wind Farm turbines shown in blue; Existing wind farms in red; Consented wind farms in orange; Proposed wind farms in green; Single turbines in pink
Turbine dimensions shown for the Development: max. tip height above ground level 149.9 m; hub height 94 m; rotor diameter 112 m

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### **MAGHERAMORE WIND FARM**

FIGURE 4.33 (page 1/2)


# VIEWPOINT 22, WIRELINE & PHOTOMONTAGE EDGE OF DRUMSURN VILLAGE

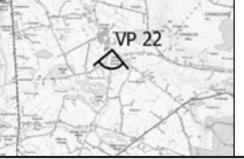Easting: 272227
Northing: 416701
Elevation A.O.D 97 m
Bearing: 197.01 °
Approx. Included Angle: 70 °

Approx. distance to nearest

NOTE: This Figure should be viewed at a comfortable arms length. It will be viewed in conjunction with the analysis of landscape and visual effects contained in Chapter 4 of the Environmental Statement and the detailed methodology for the preparation of visualisations contained in Technical Appendix 4.2, in particular the paragraphs referencing Scottish Natural Heritage Guidance regarding the limitations of visualisations.

turbine: 12.03 km to T4





No visible changes to forestry from this location



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### **MAGHERAMORE WIND FARM**


FIGURE 4.33 (page 2/2)

### **VIEWPOINT 22, BASELINE PHOTOGRAPH EDGE OF DRUMSURN VILLAGE**

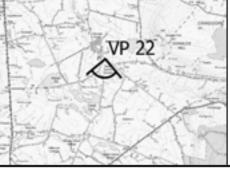Easting: 272227 416701 Northing: Elevation A.O.D 97 m Bearing: 197.01 ° Approx. Included Angle: 70 °


Approx. distance to nearest


turbine: 12.03 km to T4





# Archaeology & Cultural Heritage

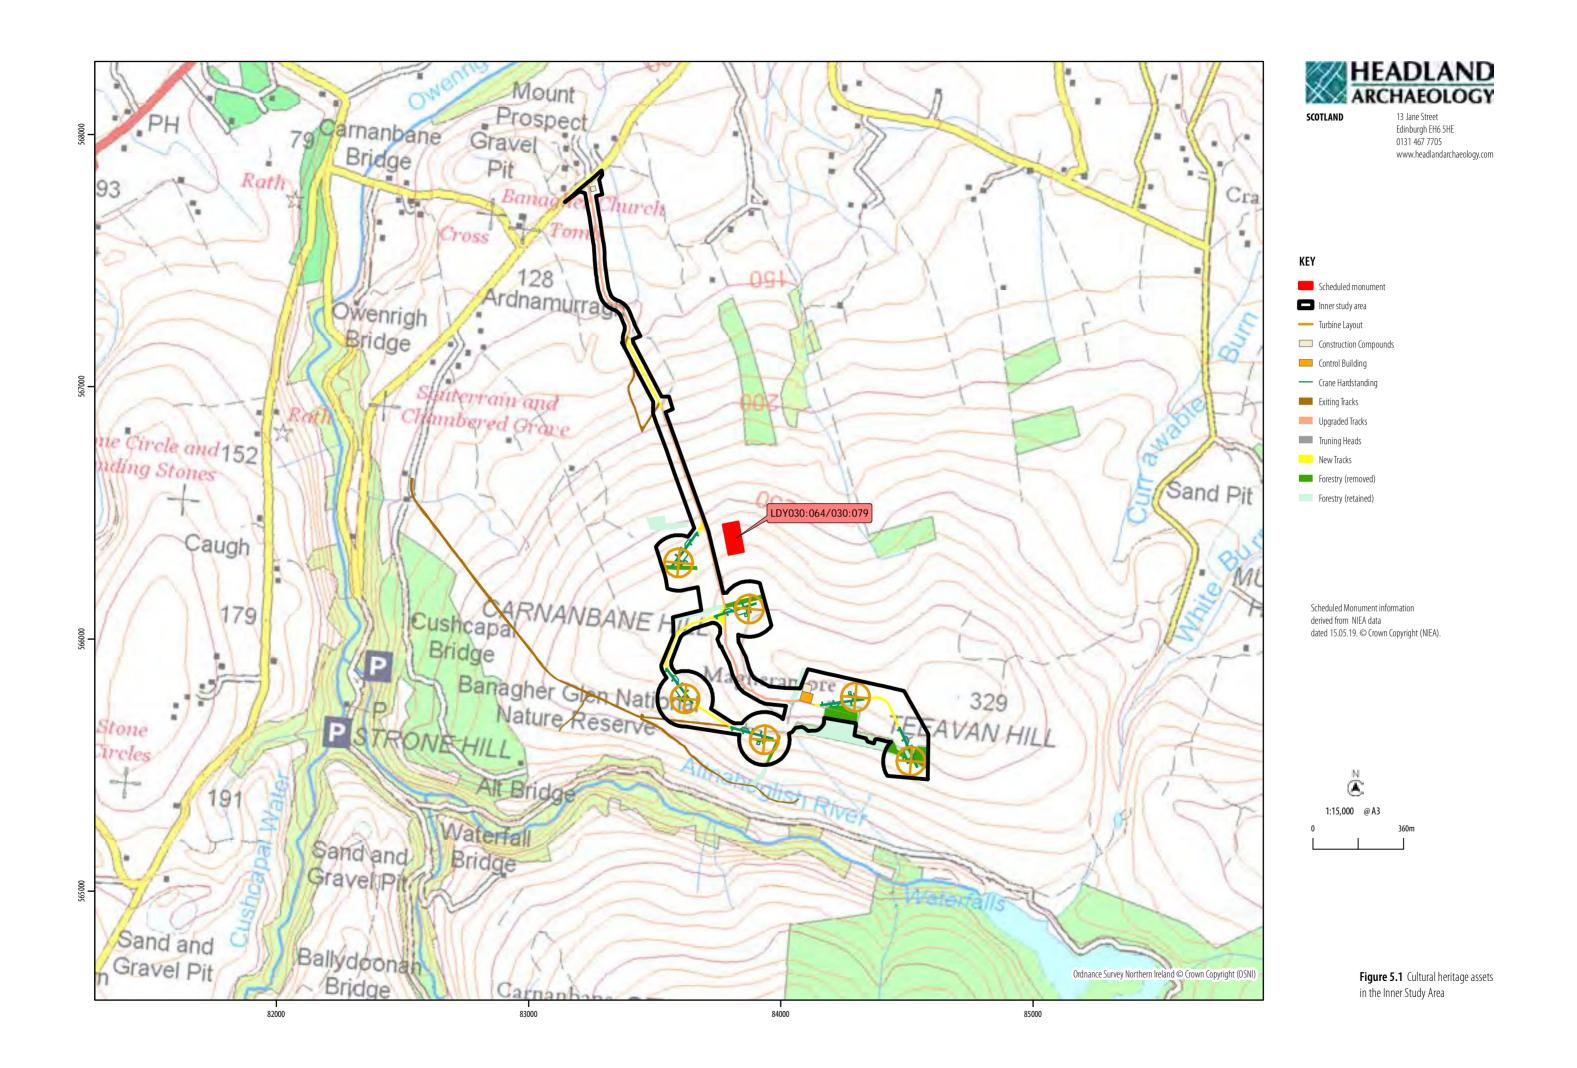

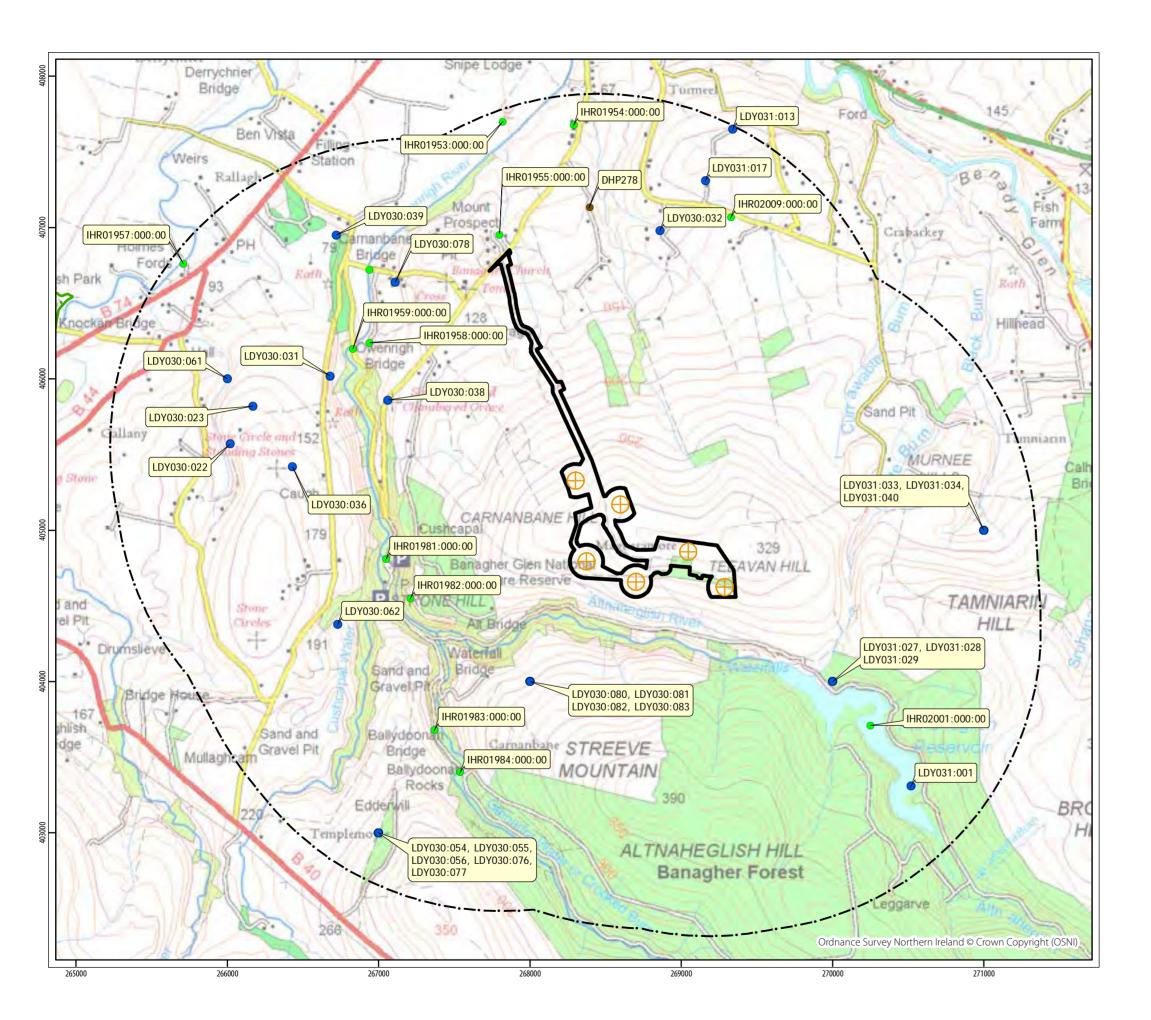



13 Jane Street Edinburgh EH6 5HE

0131 467 7705 www.headlandarchaeology.com




derived from NIEA data

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1:25,000 @ A3 0 500m

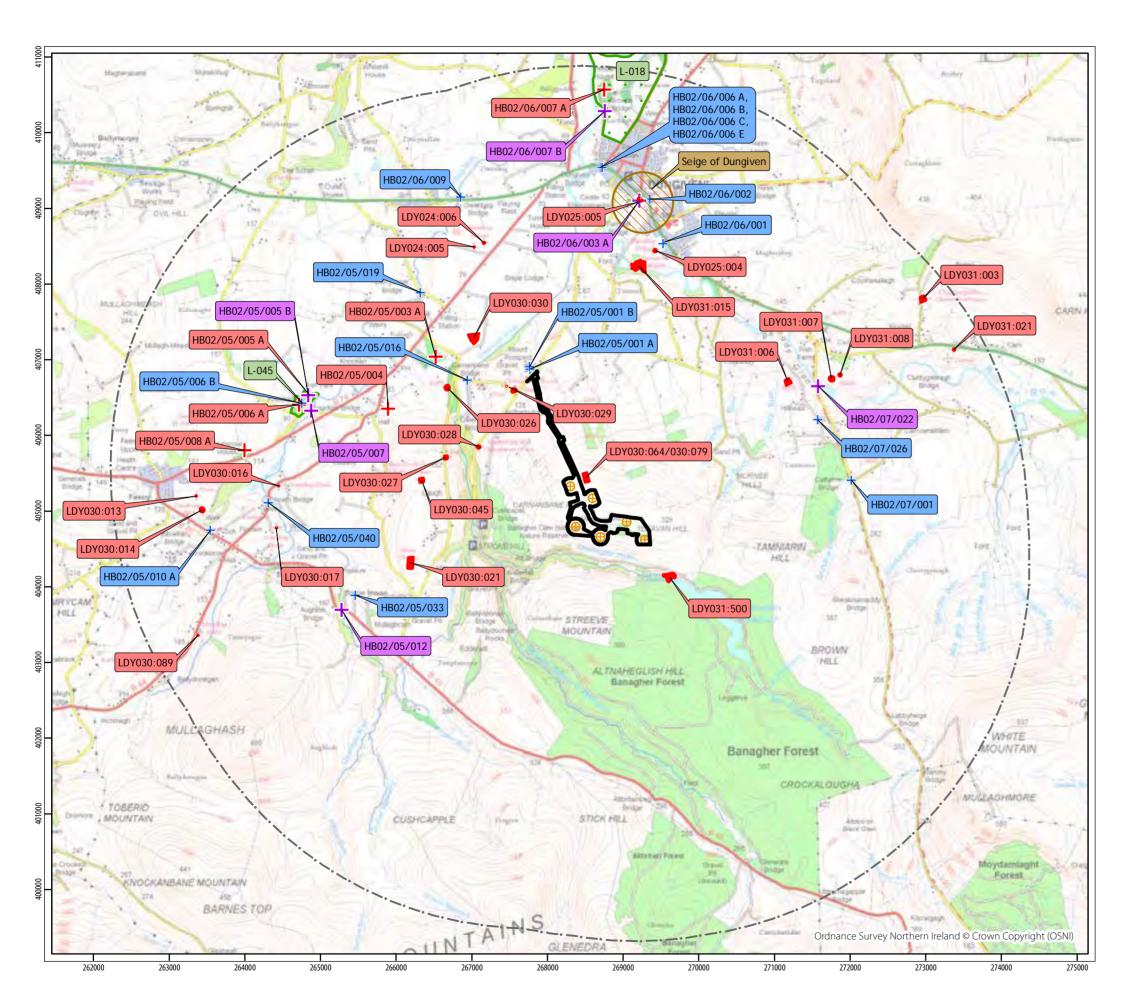**Figure 5.2**Undesignated heritage assets in 2km study area





Edinburgh EH6 5HE 0131 467 7705 www.headlandarchaeology.com

KEY

Scheduled monument

Registered park and garden

Grade B+ listed building

Grade B1 listed building

Grade B2 listed building

Battlefield

Turbine

Inner study area

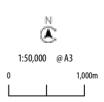
Skm outer study area

Listed Building data provided by NIEA dated 15.05.19 © Crown Copyright

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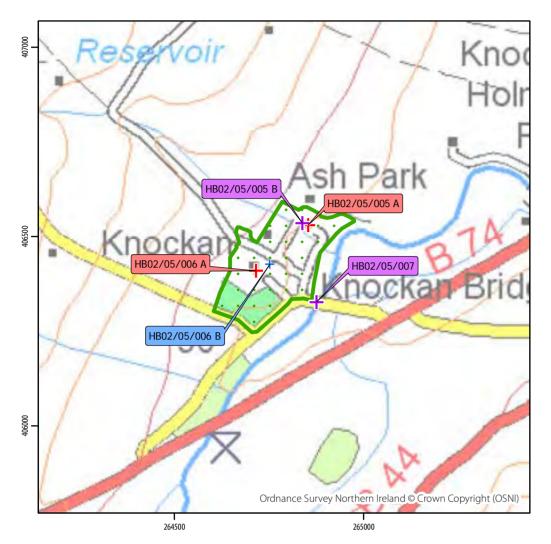
Scheduled monument area information

derived from NIEA data dated 15.05.19 © Crown Copyright (NIEA)

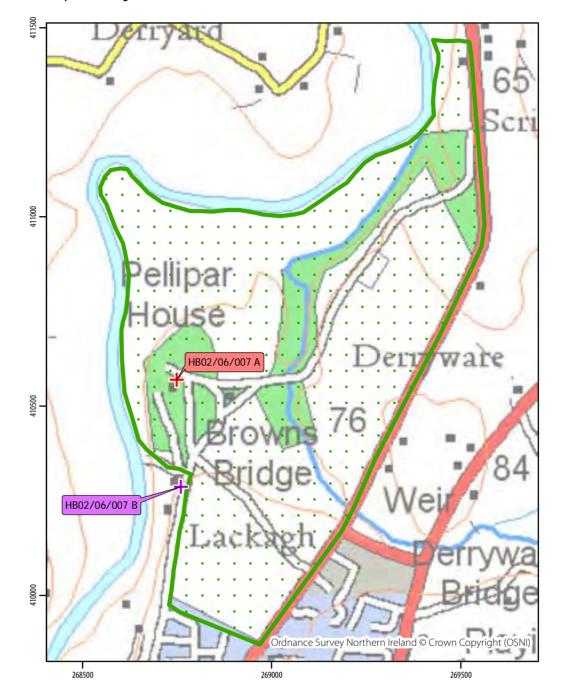


**Figure 5.3**Designated cultural heritage assets in 5km study area

#### Knockan/ Ash Park Registered Park and Garden



#### Pellipar HouseRegistered Park and Garden






13 Jane Street Edinburgh EH6 5HE 0131 467 7705 www.headlandarchaeology.com



Registered Park and Garden information derived from NIEA data dated 15.05.19. © Crown Copyright (NIEA).



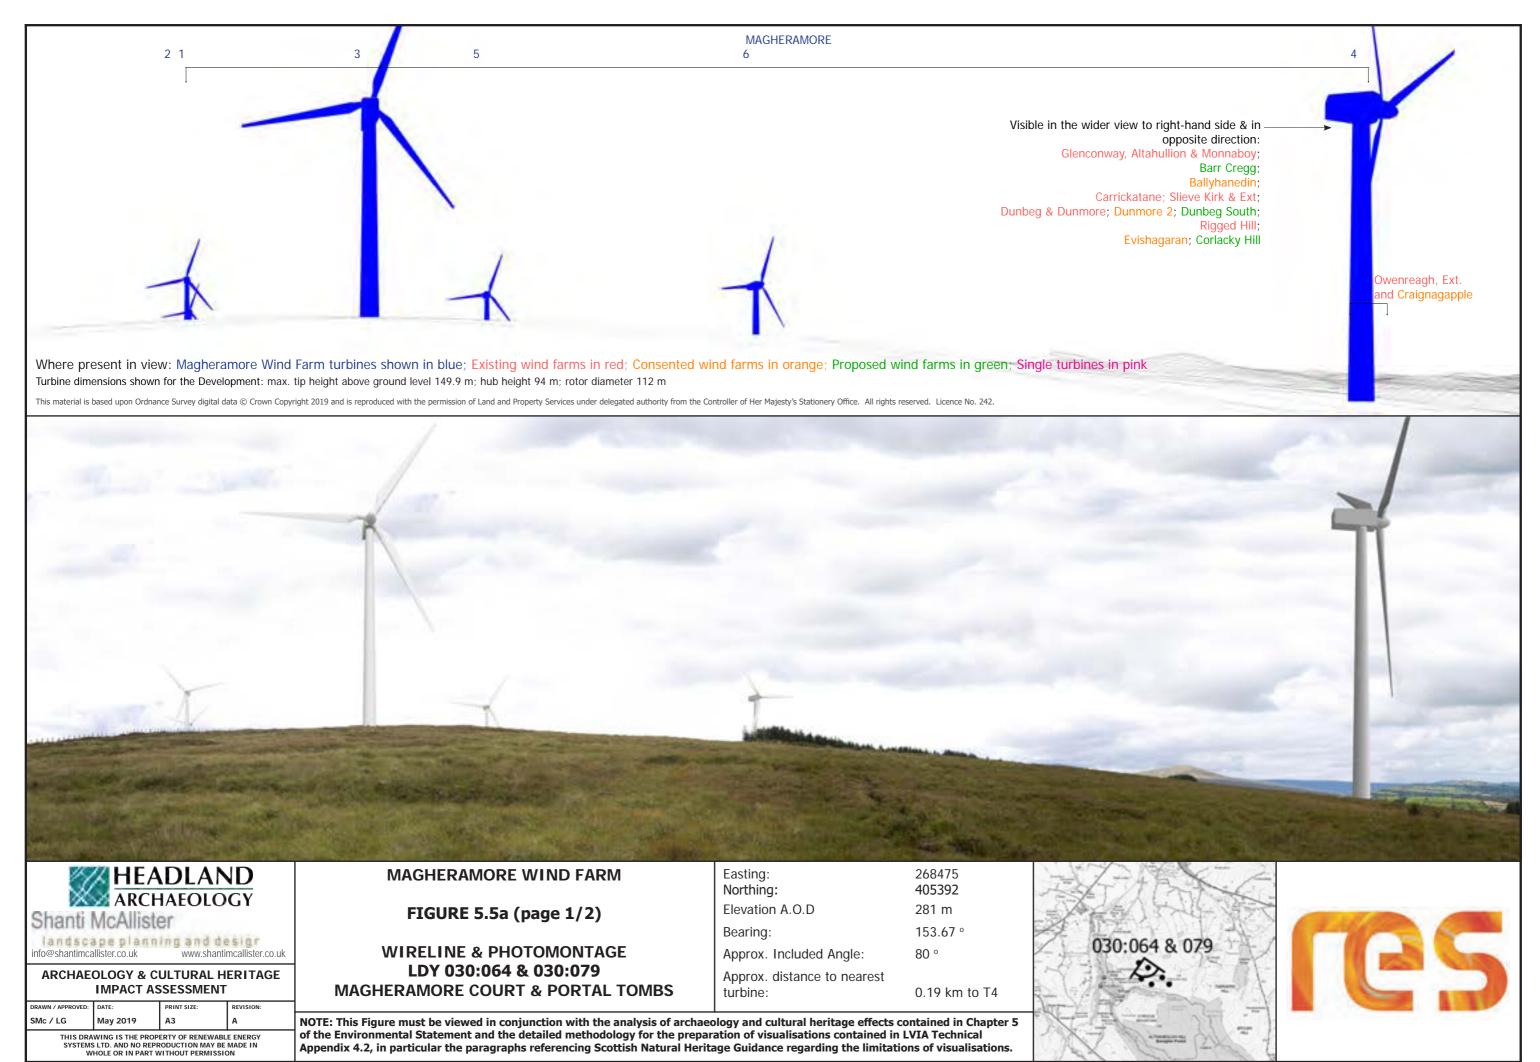**Figure 5.4**Detail of Registered Parks and Gardens in 5km study area



Proposed removal of forestry near T3

Proposed removal of forestry near T4





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MAGHERAMORE WIND FARM

FIGURE 5.5a (page 2/2)

BASELINE PHOTOGRAPH
LDY 030:064 & 030:079
MAGHERAMORE COURT & PORTAL TOMBS

Easting: 268475
Northing: 405392
Elevation A.O.D 281 m
Bearing: 153.67 °
Approx. Included Angle: 80 °

Approx. distance to nearest

turbine: 0.19 km to T4







Extent of view from south east to north east of Magheramore Wind Farm



Portion of view looking towards Magheramore Wind Farm



#### Extent of view from south west to north west of Magheramore Wind Farm

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Turbine dimensions shown for the Development: max. tip height above ground level 149.9 m; hub height 94 m; rotor diameter 112 m

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#### MAGHERAMORE WIND FARM

FIGURE 5.5b

# LDY 030:064 & 030:079 MAGHERAMORE COURT & PORTAL TOMBS WIDER VIEWS

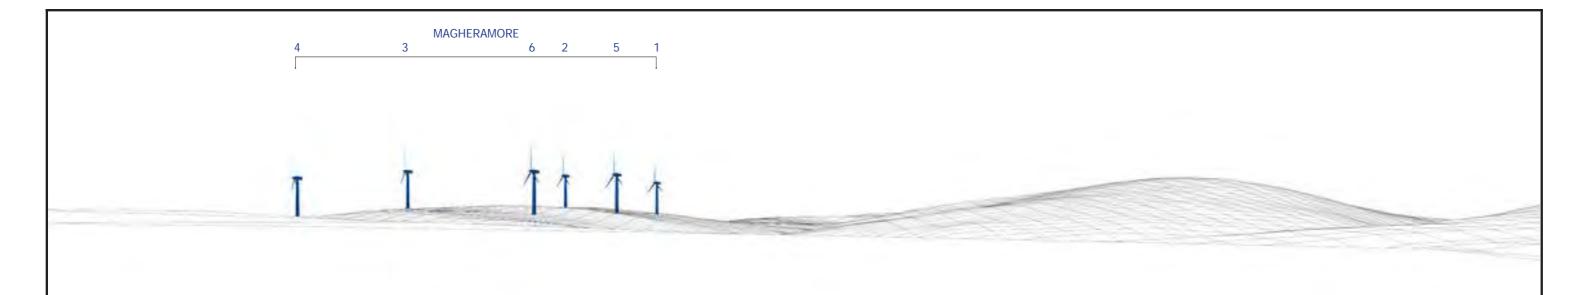
Easting: 268475
Northing: 405392
Elevation A.O.D 281 m
Bearing to wind farm: 153.67 °
Approx. Included Angle: 360 °

Approx. distance to nearest

turbine: 0.19 km to T4







Where present in view: Magheramore Wind Farm turbines shown in blue; Existing wind farms in red; Consented wind farms in orange; Proposed wind farms in green; Single turbines in pink Turbine dimensions shown for the Development: max. tip height above ground level 149.9 m; hub height 94 m; rotor diameter 112 m

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## MAGHERAMORE WIND FARM


FIGURE 5.6 (page 1/2)

## **WIRELINE & PHOTOMONTAGE** LDY 030:021 **AUGHLISH STONE CIRCLES & ALIGNMENTS**

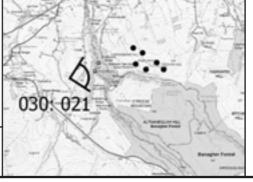266120 Easting: 404272 Northing: Elevation A.O.D 208 m Bearing: 76.65 ° ° 08 Approx. Included Angle:

Approx. distance to nearest

turbine: 2.23 km to T6





Proposed removal of forestry near T5 & T1





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## MAGHERAMORE WIND FARM


FIGURE 5.6 (page 2/2)

# BASELINE PHOTOGRAPH SITE 030:021 AUGHLISH STONE CIRCLES & ALIGNMENTS

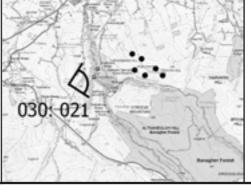Easting: 266120
Northing: 404272
Elevation A.O.D 208 m
Bearing: 76.65 °
Approx. Included Angle: 80 °


Approx. distance to nearest

turbine: 2.23 km to T6





NOTE: This Figure should be viewed at a comfortable arms length. It will be viewed in conjunction with the analysis of landscape and visual effects contained in Chapter 4 of the Environmental Statement and the detailed methodology for the preparation of visualisations contained in Technical Appendix 4.2, in particular the paragraphs referencing Scottish Natural Heritage Guidance regarding the limitations of visualisations.

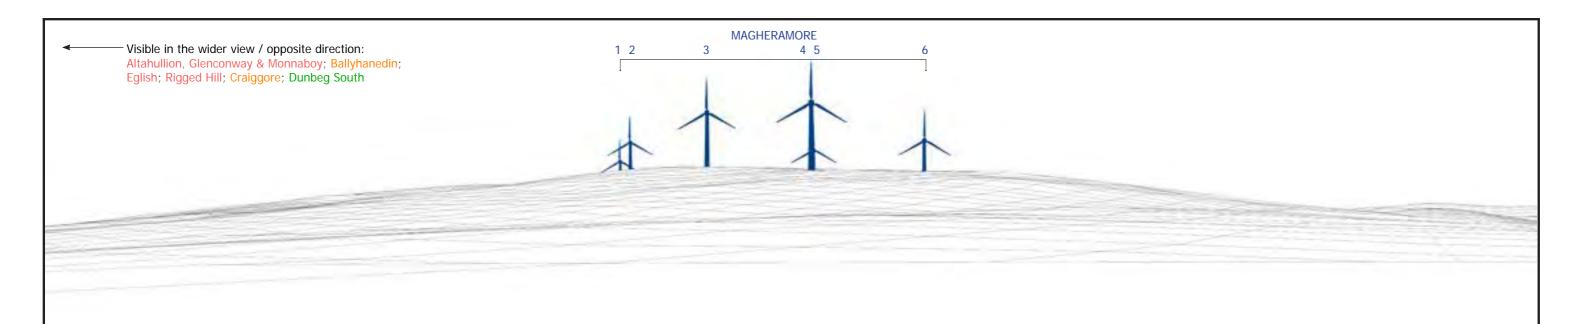

Where present in view: Magheramore Wind Farm turbines shown in blue; Existing wind farms in red; Consented wind farms in orange; Proposed wind farms in green; Single turbines in pink
Turbine dimensions shown for the Development: max. tip height above ground level 149.9 m; hub height 94 m; rotor diameter 112 m

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## MAGHERAMORE WIND FARM

FIGURE 5.7 (page 1/2)

## WIRELINE & PHOTOMONTAGE LDY 030:029 BANAGHER OLD CHURCH & STONE CROSS

Easting: 267509
Northing: 406593
Elevation A.O.D 140 m
Bearing: 144.43 °
Approx. Included Angle: 80 °

Approx. distance to nearest

turbine: 1.49 km to T4





Proposed removal of forestry near T4

Proposed removal of forestry near T3





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## **MAGHERAMORE WIND FARM**

FIGURE 5.7 (page 2/2)

## BASELINE PHOTOGRAPH LDY 030:029 BANAGHER OLD CHURCH & STONE CROSS

Easting: 267509
Northing: 406593
Elevation A.O.D 140 m
Bearing: 144.43 °
Approx. Included Angle: 80 °

Approx. distance to nearest

turbine: 1.49 km to T4

NOTE: This Figure should be viewed at a comfortable arms length. It will be viewed in conjunction with the analysis of landscape and visual effects contained in Chapter 4 of the Environmental Statement and the detailed methodology for the preparation of visualisations contained in Technical Appendix 4.2, in particular the paragraphs referencing Scottish Natural Heritage Guidance regarding the limitations of visualisations.





 Visible in the wider view to left-hand side and in opposite direction:

Craiggore; Rigged Hill; Dunbeg South; Dunmore II; Altahullion & Glenconway cluster; Monnaboy; Ballyhanedin MAGHERAMORE 4 3 2 1 5



Where present in view: Magheramore Wind Farm turbines shown in blue; Existing wind farms in red; Consented wind farms in orange; Proposed wind farms in green; Single turbines in pink
Turbine dimensions shown for the Development: max. tip height above ground level 149.9 m; hub height 94 m; rotor diameter 112 m

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#### MAGHERAMORE WIND FARM


FIGURE 5.8

## WIRELINE & PHOTOMONTAGE HB02/05/004 BANAGHER CHURCH OF IRELAND


Easting: 265823
Northing: 406325
Elevation A.O.D 126 m
Bearing: 117.30 °
Approx. Included Angle: 80 °

Approx. distance to nearest

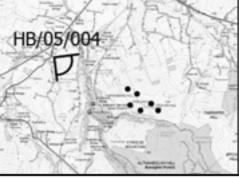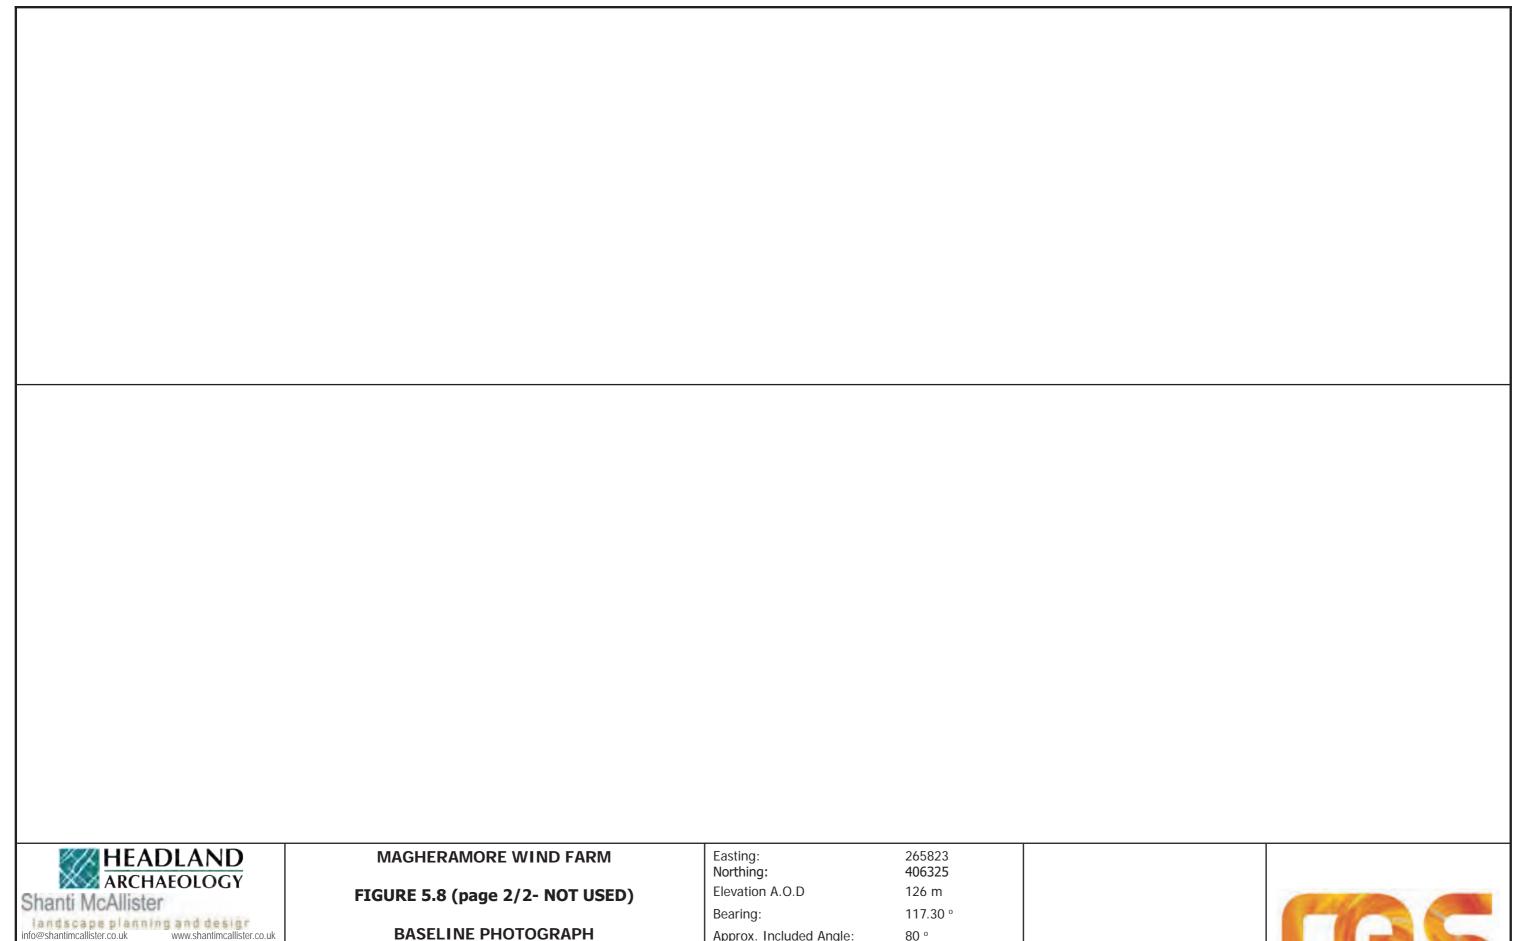turbine: 2.68 km to T4







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**BASELINE PHOTOGRAPH** SITE HB02/05/004 **BANAGHER CHURCH OF IRELAND** 

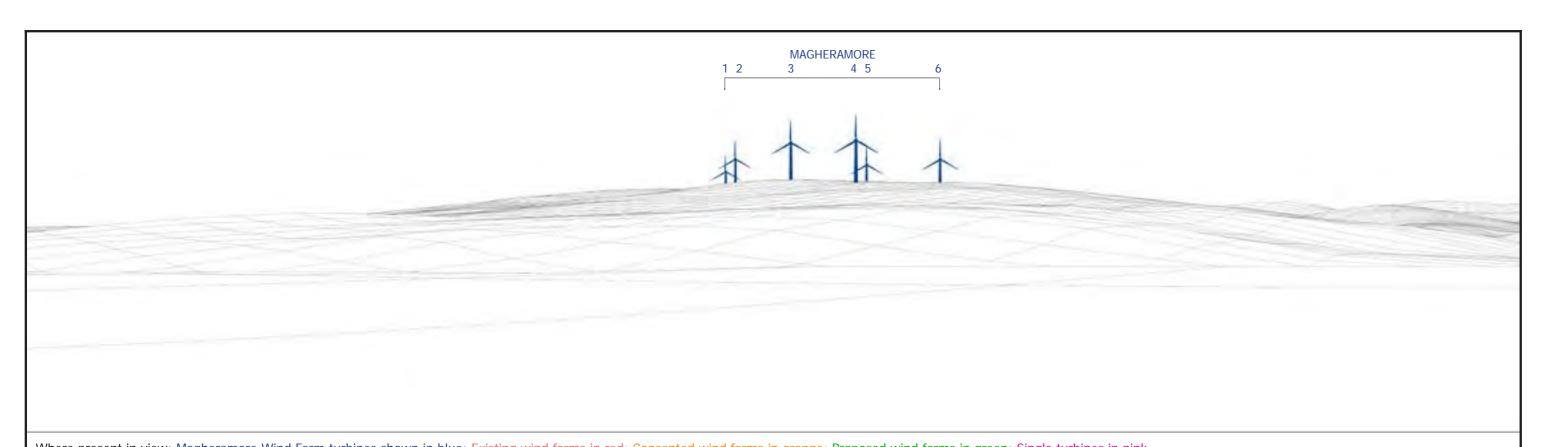
° 08 Approx. Included Angle:

Approx. distance to nearest

turbine: 2.68 km to T4

NOTE: This Figure should be viewed at a comfortable arms length. It will be viewed in conjunction with the analysis of landscape and visual effects contained in Chapter 4 of the Environmental Statement and the detailed methodology for the preparation of visualisations contained in Technical Appendix 4.2, in particular the paragraphs referencing Scottish Natural Heritage Guidance regarding the limitations of visualisations.





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**MAGHERAMORE WIND FARM** 

FIGURE 5.9 (page 1/2)

**WIRELINE & PHOTOMONTAGE** LDY 030:030 TEMPLEMOYLE CHURCH SITE

266976 Easting: Northing: 407300 Elevation A.O.D 82 m Bearing: 144.00 ° Approx. Included Angle: ° 08

Approx. distance to nearest

turbine: 2.37 km to T4





Proposed removal of forestry near T3





info@shantimcallister.co.uk www.shantimcallister.co.uk

## ARCHAEOLOGY & CULTURAL HERITAGE IMPACT ASSESSMENT

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## MAGHERAMORE WIND FARM

FIGURE 5.9 (page 2/2)

## BASELINE PHOTOGRAPH LDY 030:030 TEMPLEMOYLE CHURCH SITE

Easting: 266976
Northing: 407300
Elevation A.O.D 82 m
Bearing: 144.00 °
Approx. Included Angle: 80 °

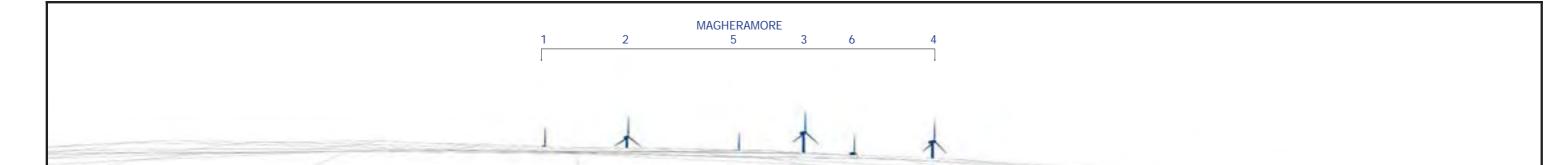
Approx. distance to nearest

turbine: 2.37 km to T4





NOTE: This Figure should be viewed at a comfortable arms length. It will be viewed in conjunction with the analysis of landscape and visual effects contained in Chapter 4 of the Environmental Statement and the detailed methodology for the preparation of visualisations contained in Technical Appendix 4.2, in particular the paragraphs referencing Scottish Natural Heritage Guidance regarding the limitations of visualisations.



Where present in view: Magheramore Wind Farm turbines shown in blue; Existing wind farms in red; Consented wind farms in orange; Proposed wind farms in green; Single turbines in pink Turbine dimensions shown for the Development: max. tip height above ground level 149.9 m; hub height 94 m; rotor diameter 112 m

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## ARCHAEOLOGY & CULTURAL HERITAGE IMPACT ASSESSMENT

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## MAGHERAMORE WIND FARM


### **FIGURE 5.10**
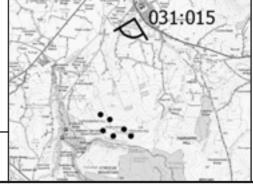
# WIRELINE & PHOTOMONTAGE LDY 031:015 DUNGIVEN PRIORY & MONASTIC SITE

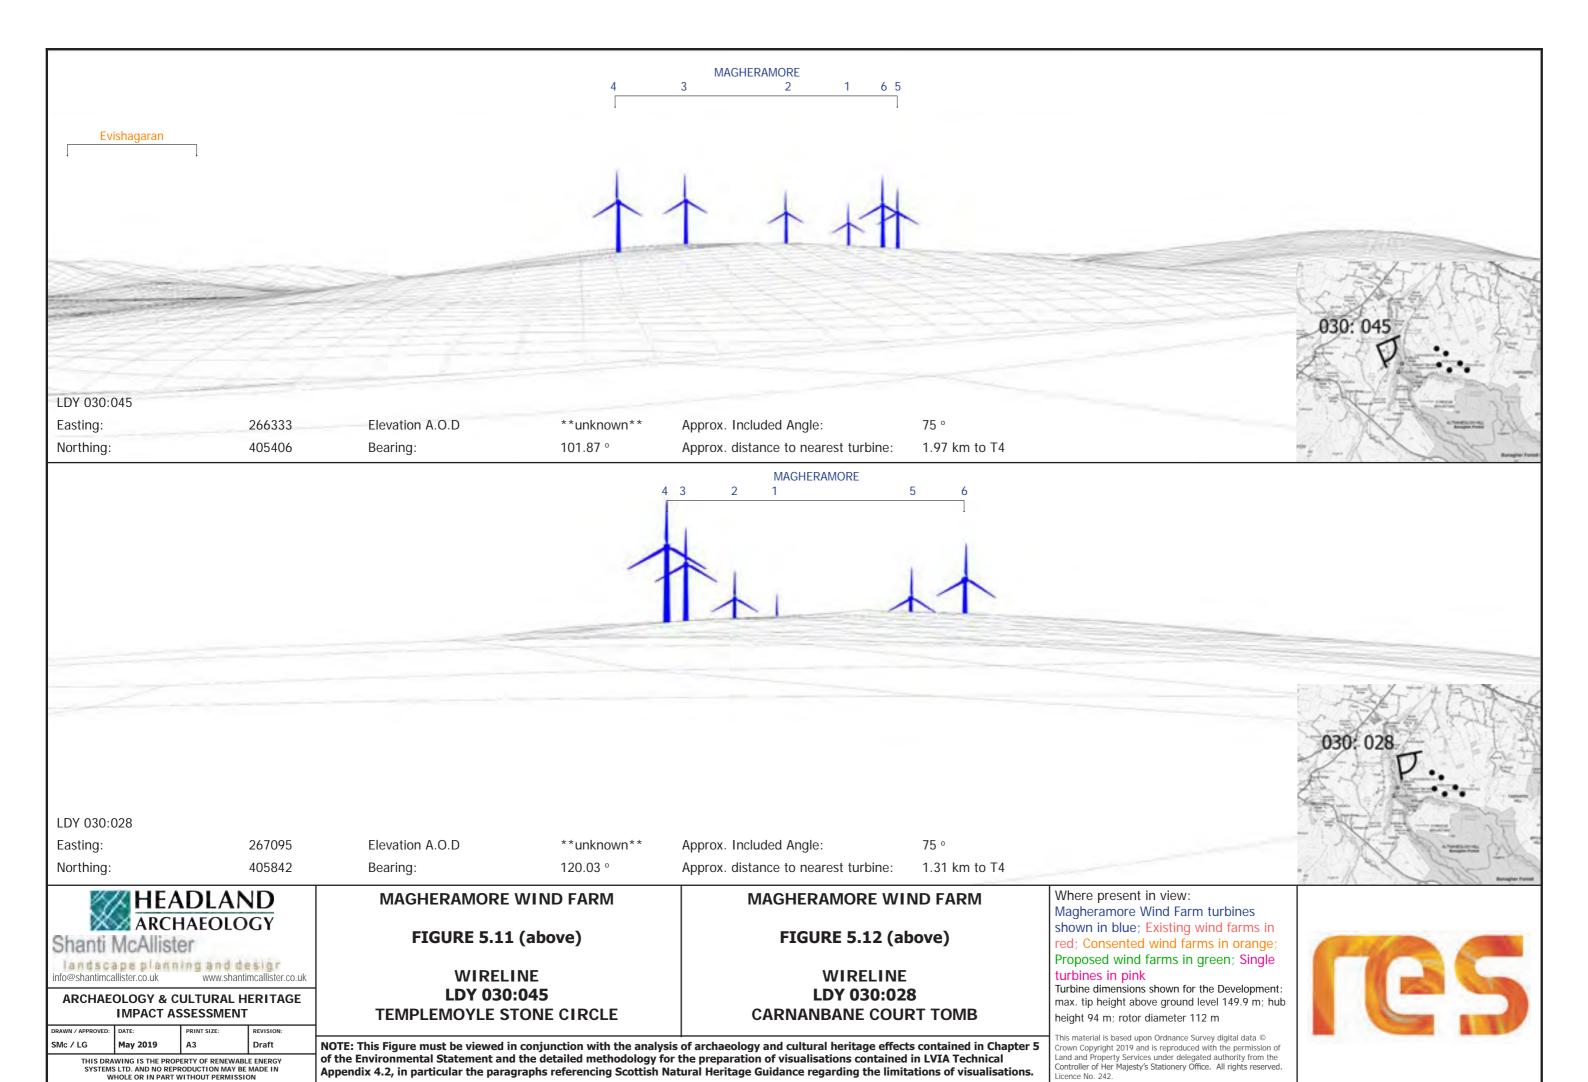
Easting: 269201
Northing: 408258
Elevation A.O.D 109 m
Bearing: 188.23 °
Approx. Included Angle: 80 °

Approx. distance to nearest


turbine: 3.08 km to T4










Appendix 4.2, in particular the paragraphs referencing Scottish Natural Heritage Guidance regarding the limitations of visualisations.

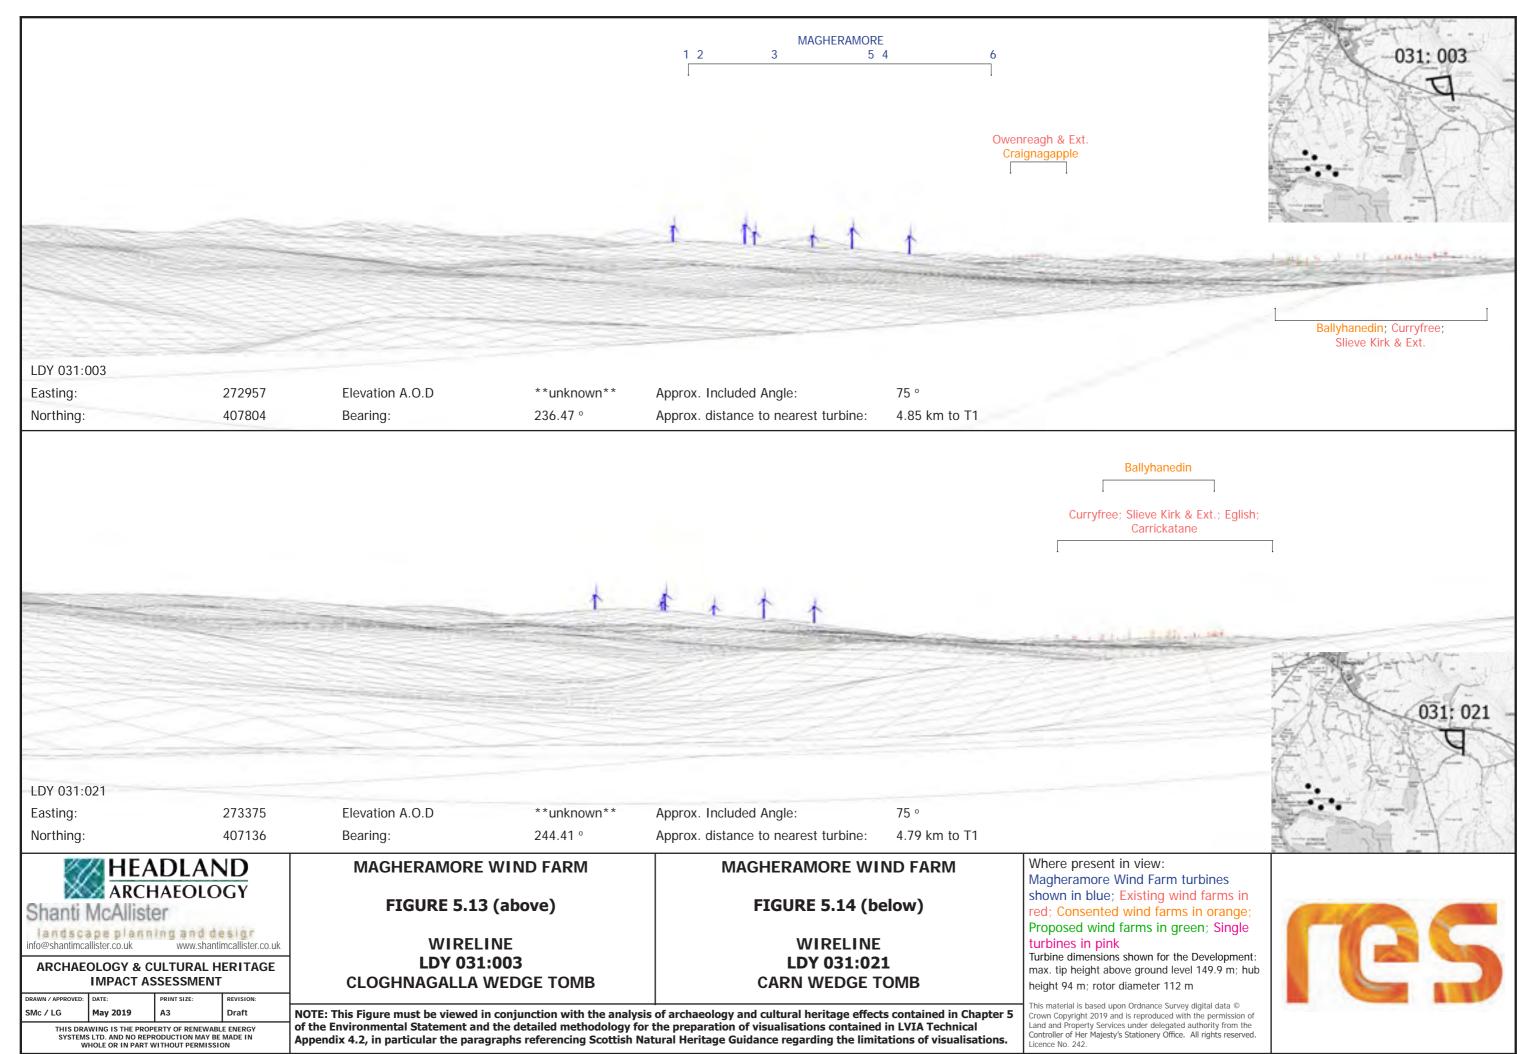

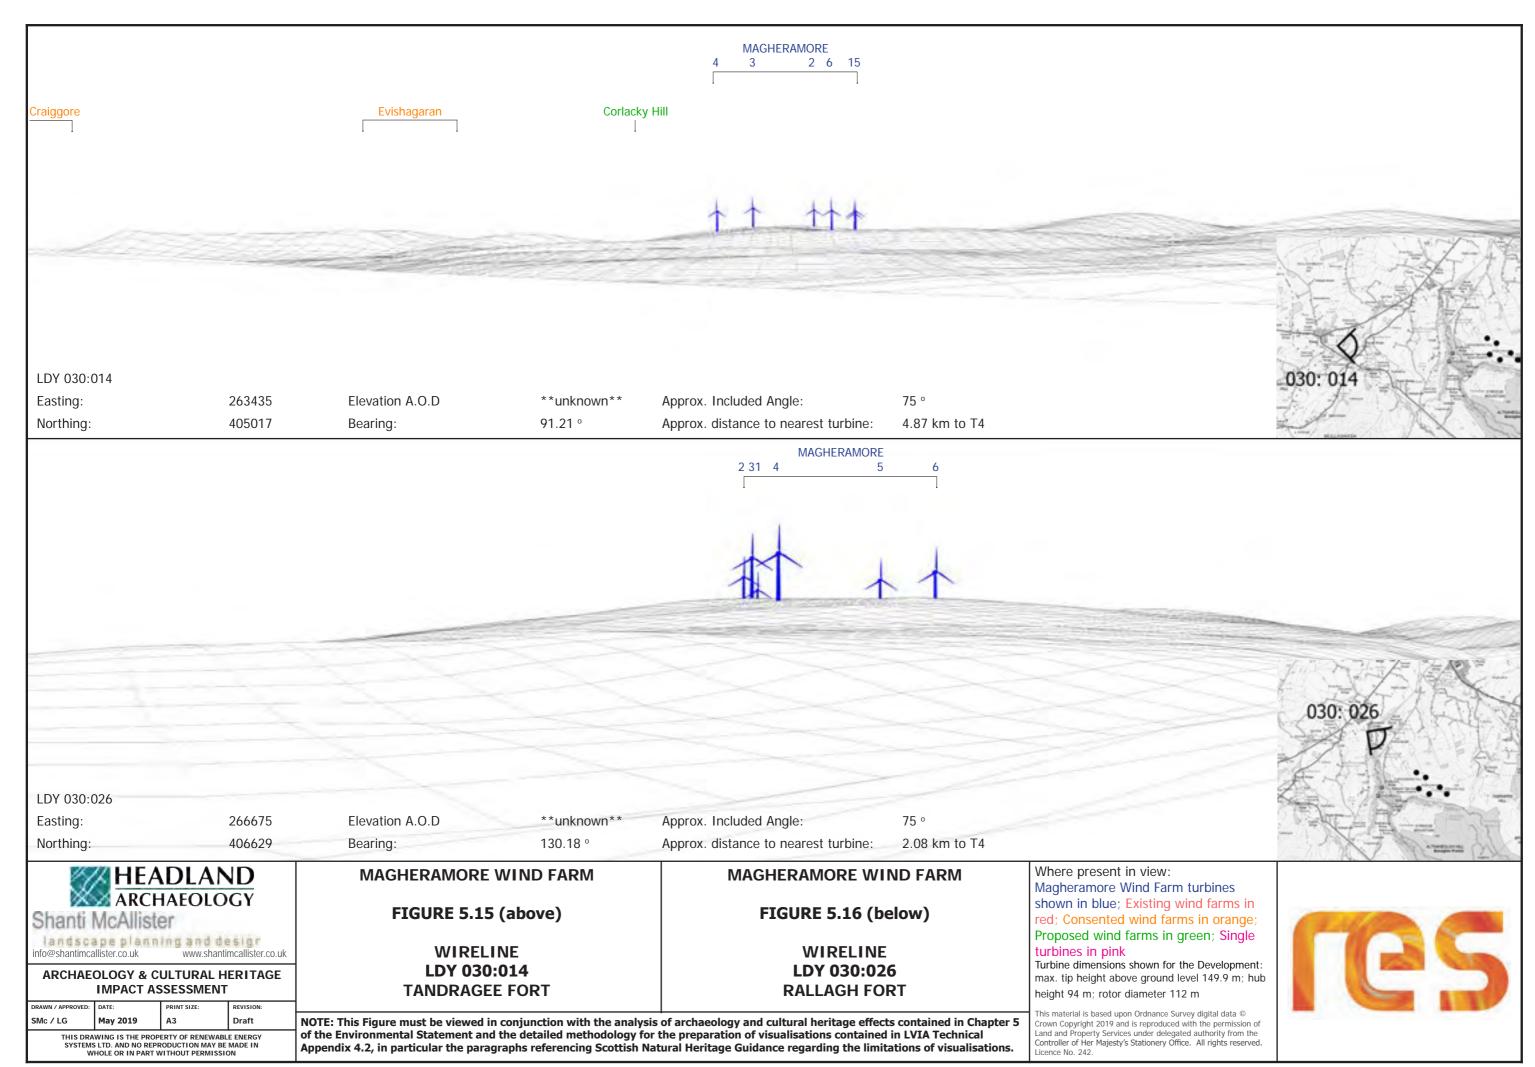

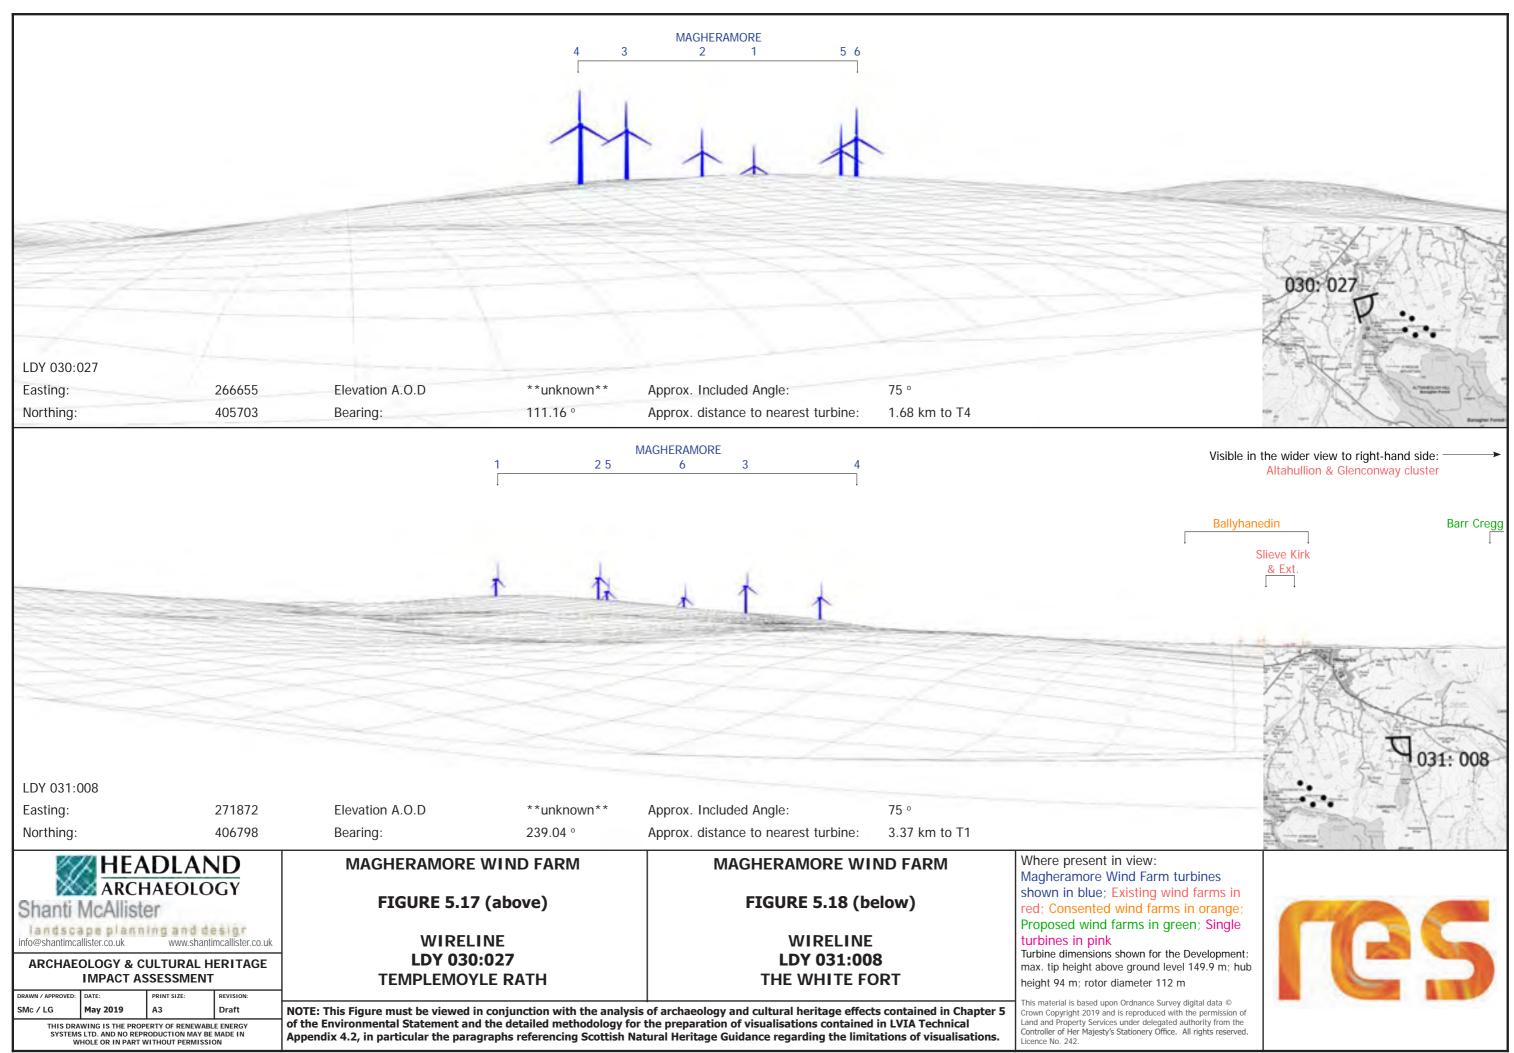

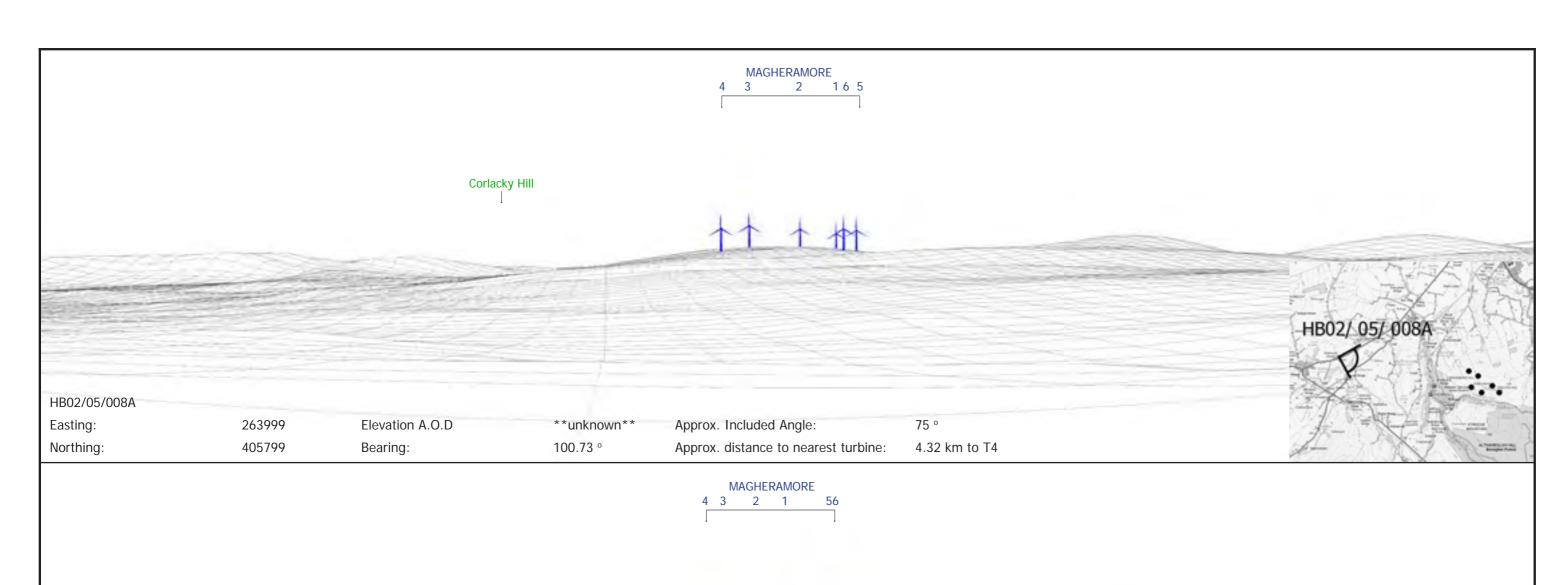



L-045 RPG

Easting: 264693 Elevation A.O.D \*\*unknown\*\* Approx. Included Angle: 75 °

406467 111.22 ° 3.78 km to T4 Northing: Bearing: Approx. distance to nearest turbine:

**HEADLAND** 

Shanti McAllister landscape planning and design info@shantimcallister.co.uk www.shantimcallister.co.uk

ARCHAEOLOGY & CULTURAL HERITAGE **IMPACT ASSESSMENT** 

May 2019 А3

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MAGHERAMORE WIND FARM

FIGURE 5.19 (above)

**WIRELINE** HB02/05/008A **DRUMCOVIT HOUSE**  **MAGHERAMORE WIND FARM** 

FIGURE 5.20 (below)

WIRELINE **KNOCKAN / ASH PARK** 

**REGISTERED PARK AND GARDEN** 

NOTE: This Figure must be viewed in conjunction with the analysis of archaeology and cultural heritage effects contained in Chapter 5 of the Environmental Statement and the detailed methodology for the preparation of visualisations contained in LVIA Technical Appendix 4.2, in particular the paragraphs referencing Scottish Natural Heritage Guidance regarding the limitations of visualisations.

Where present in view:

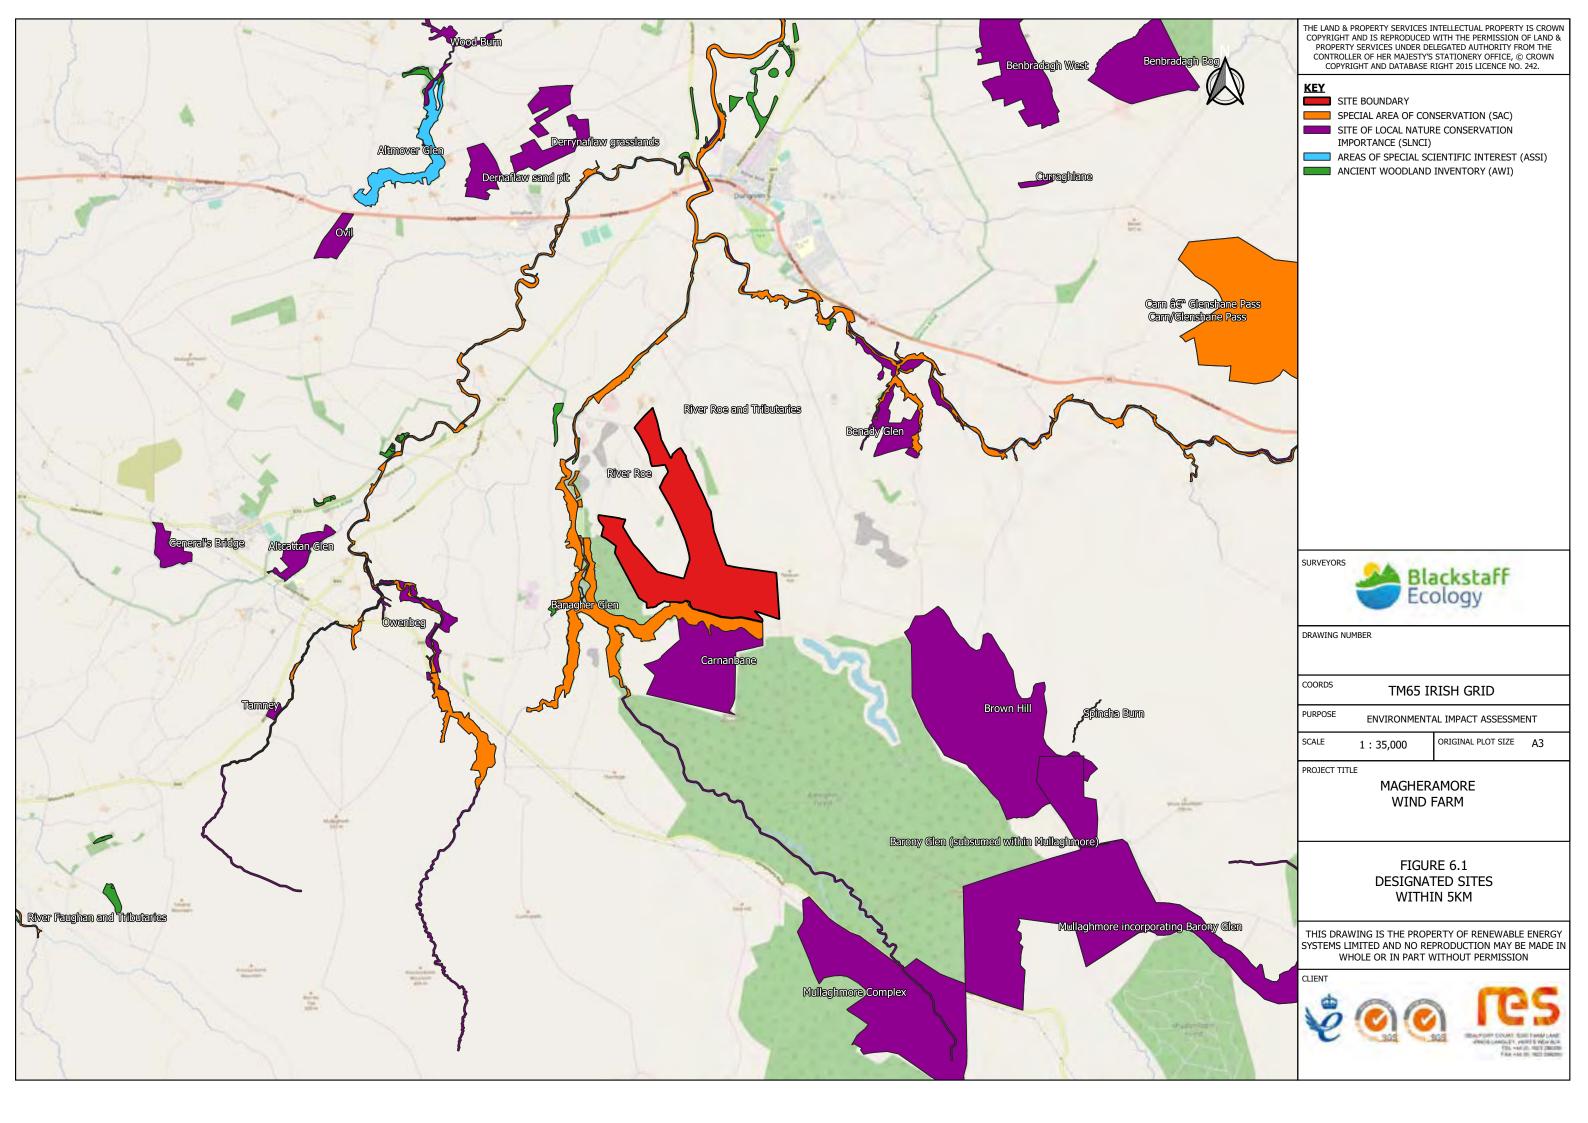
Magheramore Wind Farm turbines shown in blue; Existing wind farms in red; Consented wind farms in orange; Proposed wind farms in green; Single turbines in pink


Turbine dimensions shown for the Development: max. tip height above ground level 149.9 m; hub height 94 m; rotor diameter 112 m

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Knockan/ Ash





PLANNING APPLICATION BOUNDARY LAND UNDER APPLICANT CONTROL QUADRAT LOCATION ♦ FIELD NUMBER TURBINE LOCATION --- CRANE HARDSTANDING AREA ACCESS TRACK UPGRADED ACCESS TRACK EXISTING TRACK WATERCOURSE CROSSING WATERCOURSE CONTROL BUILDING TEMPORARY CONSTRUCTION COMPOUND FORESTRY (RETAINED) FORESTRY (REMOVED) ISOLATED TREE → DISCONTINUOUS HEDGEROW CONIFEROUS PLANTATION SCRUB AREA OF ACID GRASSLAND ARABLE LAND MODIFIED WET BOG, WET HEATH MOSAIC DRY HEATH WET HEATH DRY, WET HEATH MOSAIC MARSHY GRASSLAND DRY, WET MODIFIED BOG MOSAIC

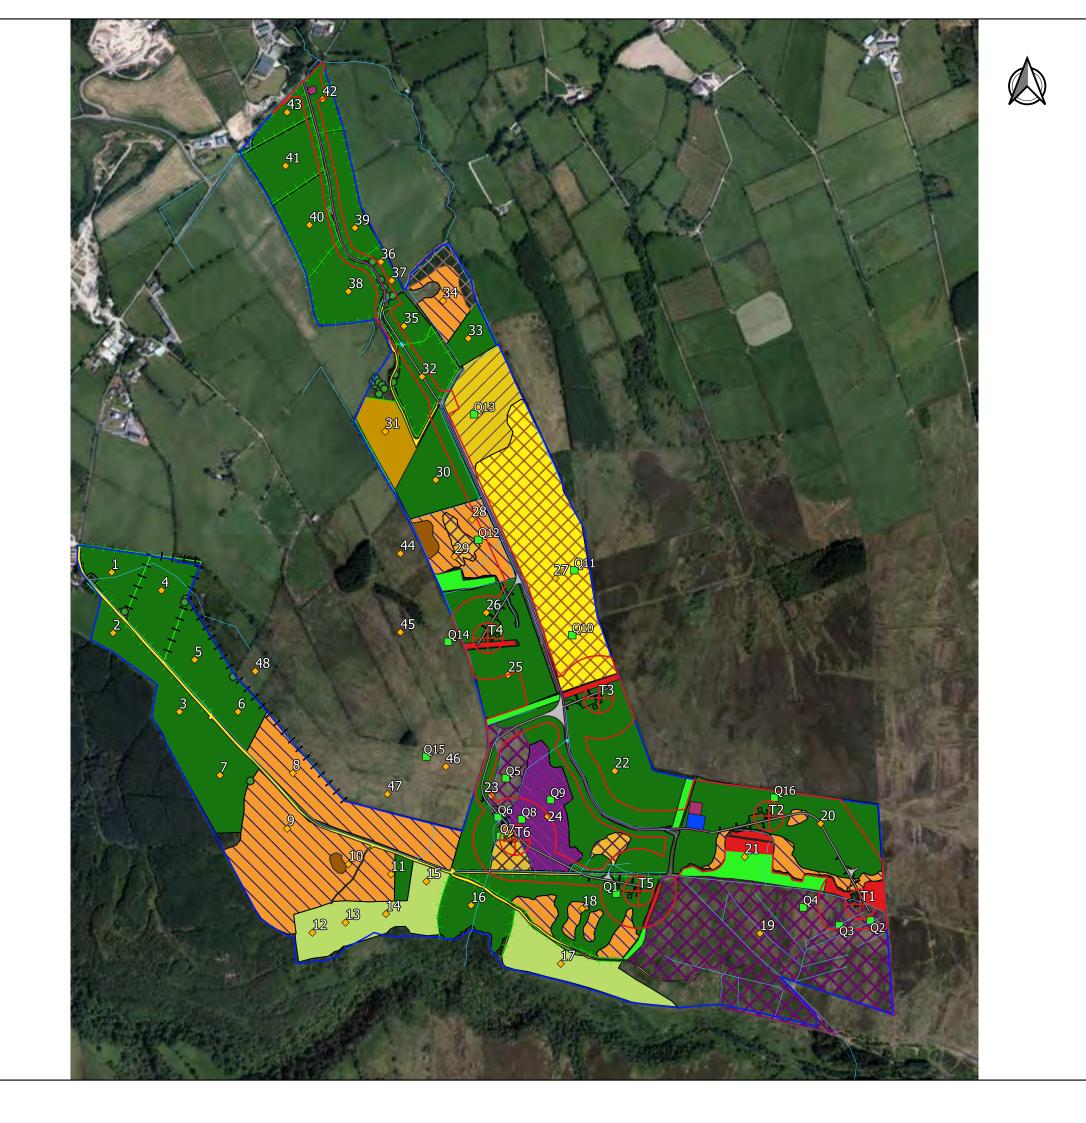SURVEYORS



DRAWING NUMBER

COORDS TM65 IRISH GRID

SEMI IMPROVED GRASSLAND
IMPROVED GRASSLAND

PURPOSE

ENVIRONMENTAL IMPACT ASSESSMENT

SCALE

1:10,000 ORIGINAL PLOT SIZE A3

PROJECT TITLE

MAGHERAMORE WIND FARM

#### FIGURE 6.2 HABITAT SURVEY RESULTS

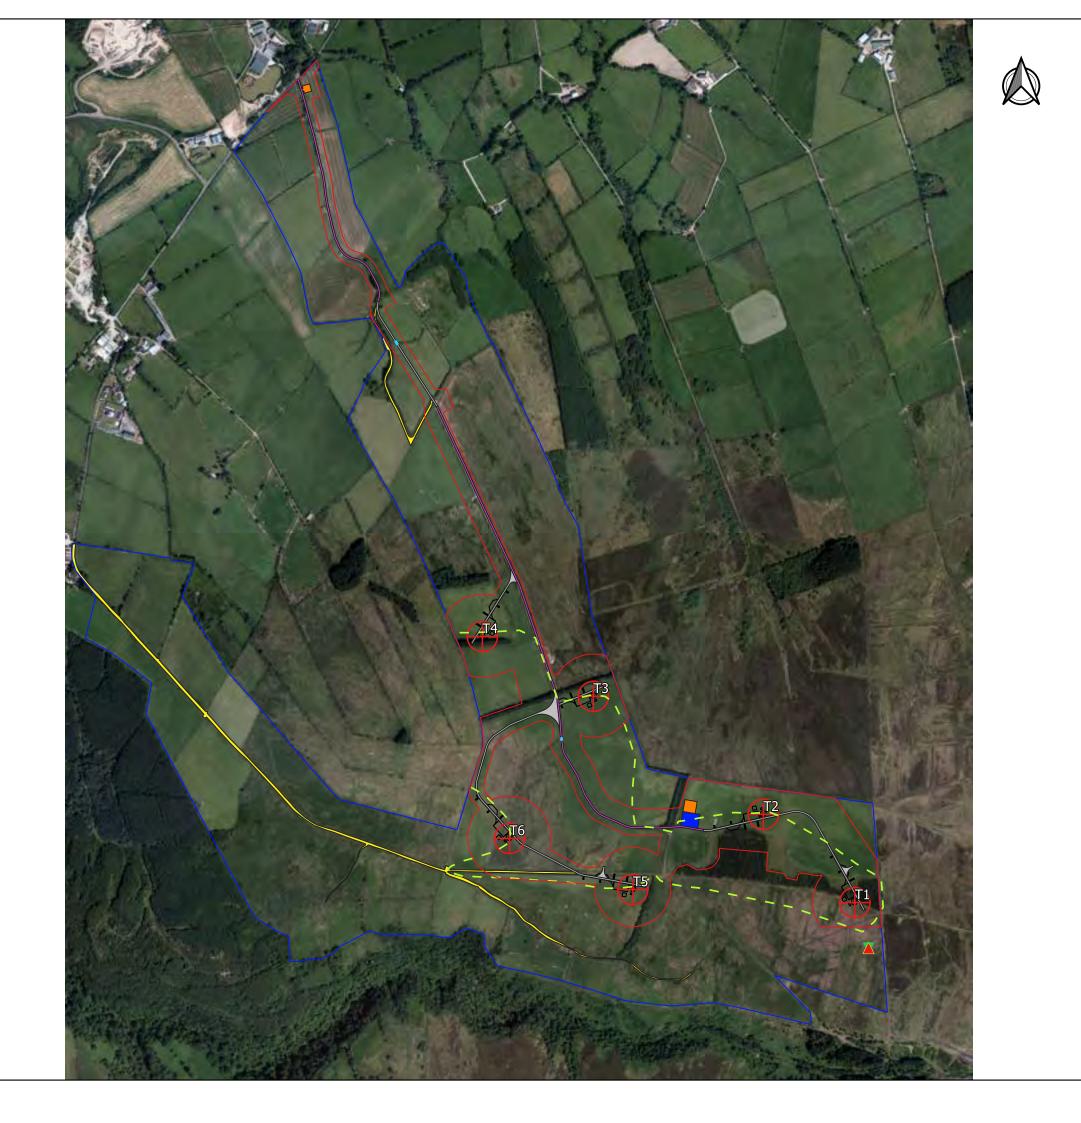
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PLANNING APPLICATION BOUNDARY LAND UNDER APPLICANT CONTROL TRANSECT NATHUSIUS' PIPISTRELLE SOPRANO PIPISTRELLE TURBINE LOCATION

— CRANE HARDSTANDING AREA EXISTING TRACK

UPGRADED ACCESS TRACK ACCESS TRACK (NEW)

WATERCOURSE

TEMPORARY CONSTRUCTION COMPOUND CONTROL BUILDING

SURVEYORS



DRAWING NUMBER

COORDS TM65 IRISH GRID

PURPOSE ENVIRONMENTAL IMPACT ASSESSMENT

ORIGINAL PLOT SIZE A3 SCALE

1:10,000

PROJECT TITLE

MAGHERAMORE WIND FARM

FIGURE 6.3 BAT TRANSECT (SPRING)


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PLANNING APPLICATION BOUNDARY

LAND UNDER APPLICANT CONTROL

TRANSECT

LEISLER'S BAT

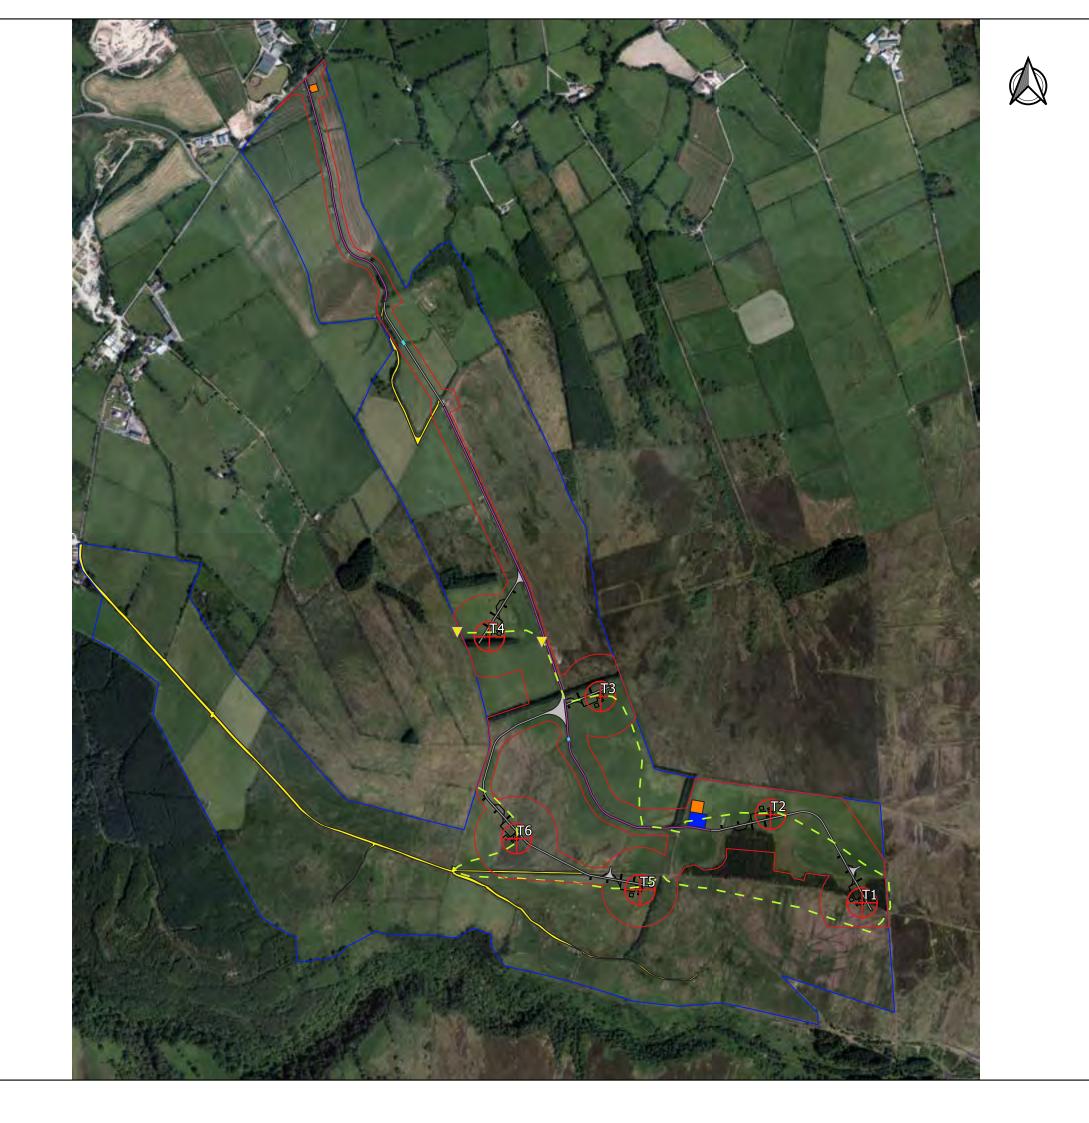TURBINE LOCATION

ACCESS TRACK (NEW)
CRANE HARDSTANDING AREA

UPGRADED ACCESS TRACK

EXISTING TRACK
WATERCOURSE

TEMPORARY CONSTRUCTION COMPOUND

CONTROL BUILDING

SURVEYORS



DRAWING NUMBER

COORDS TM65 IRISH GRID

PURPOSE ENVIRONM

ENVIRONMENTAL IMPACT ASSESSMENT

SCALE 1:10,000

ORIGINAL PLOT SIZE A3

PROJECT TITLE

MAGHERAMORE WIND FARM

FIGURE 6.4 BAT TRANSECT (SUMMER)


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KEY

PLANNING APPLICATION BOUNDARY

LAND UNDER APPLICANT CONTROL

TRANSECT

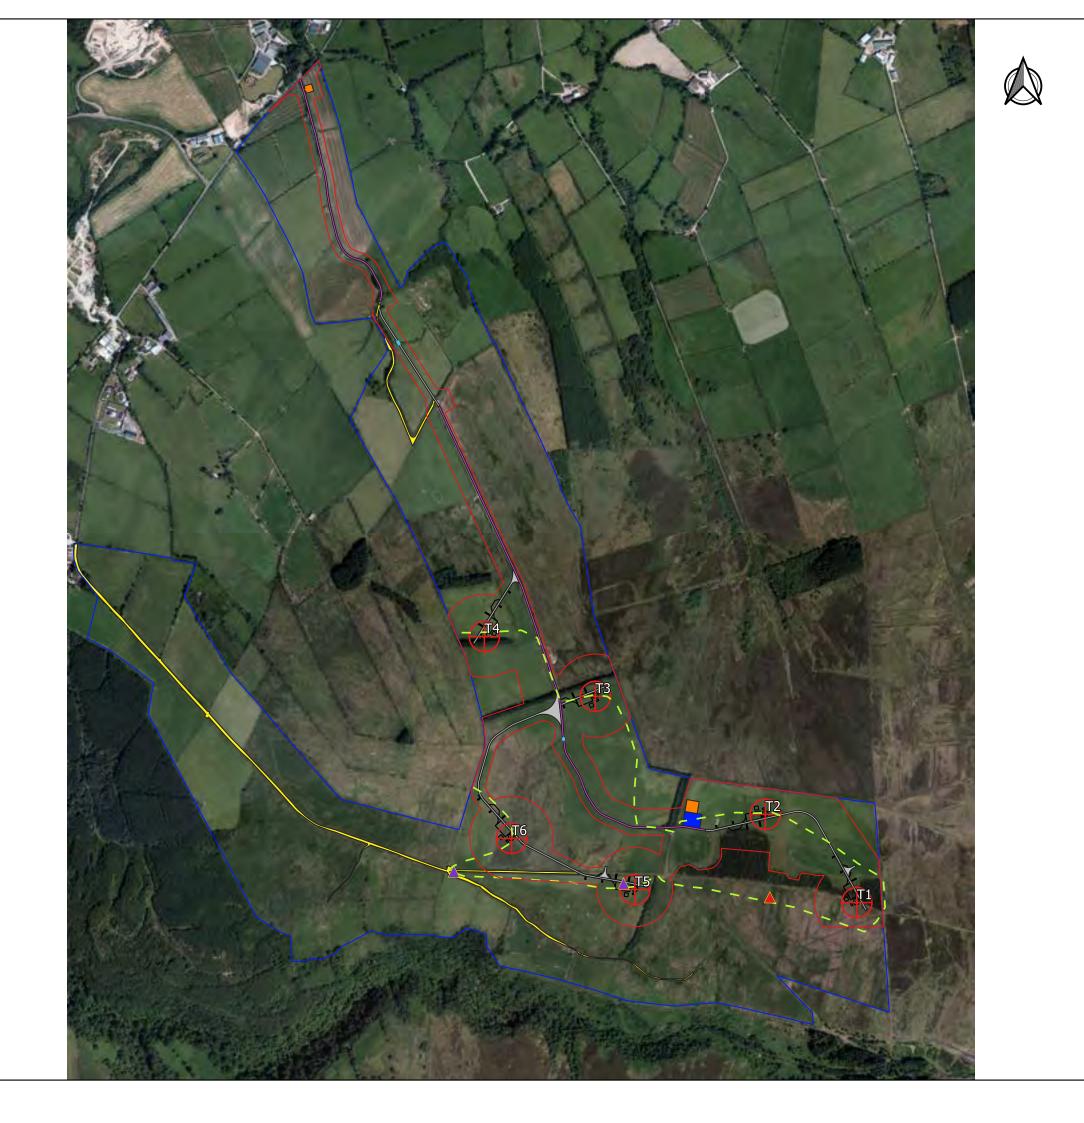COMMON PIPISTRELLE

SOPRANO PIPISTRELLE

TURBINE LOCATION

UPGRADED ACCESS TRACK

ACCESS TRACK (NEW)

— CRANE HARDSTANDING AREA

TEMPORARY CONSTRUCTION COMPOUND

EXISTING TRACK
WATERCOURSE

CONTROL BUILDING

SURVEYORS



DRAWING NUMBER

COORDS TM65 IRISH GRID

PURPOSE

ENVIRONMENTAL IMPACT ASSESSMENT

SCALE

1:10,000 ORIGINAL PLOT SIZE A3

PROJECT TITLE

MAGHERAMORE WIND FARM

FIGURE 6.5 BAT TRANSECT (AUTUMN)


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PLANNING APPLICATION BOUNDARY

LAND UNDER APPLICANT CONTROL

TURBINE

FEATURE

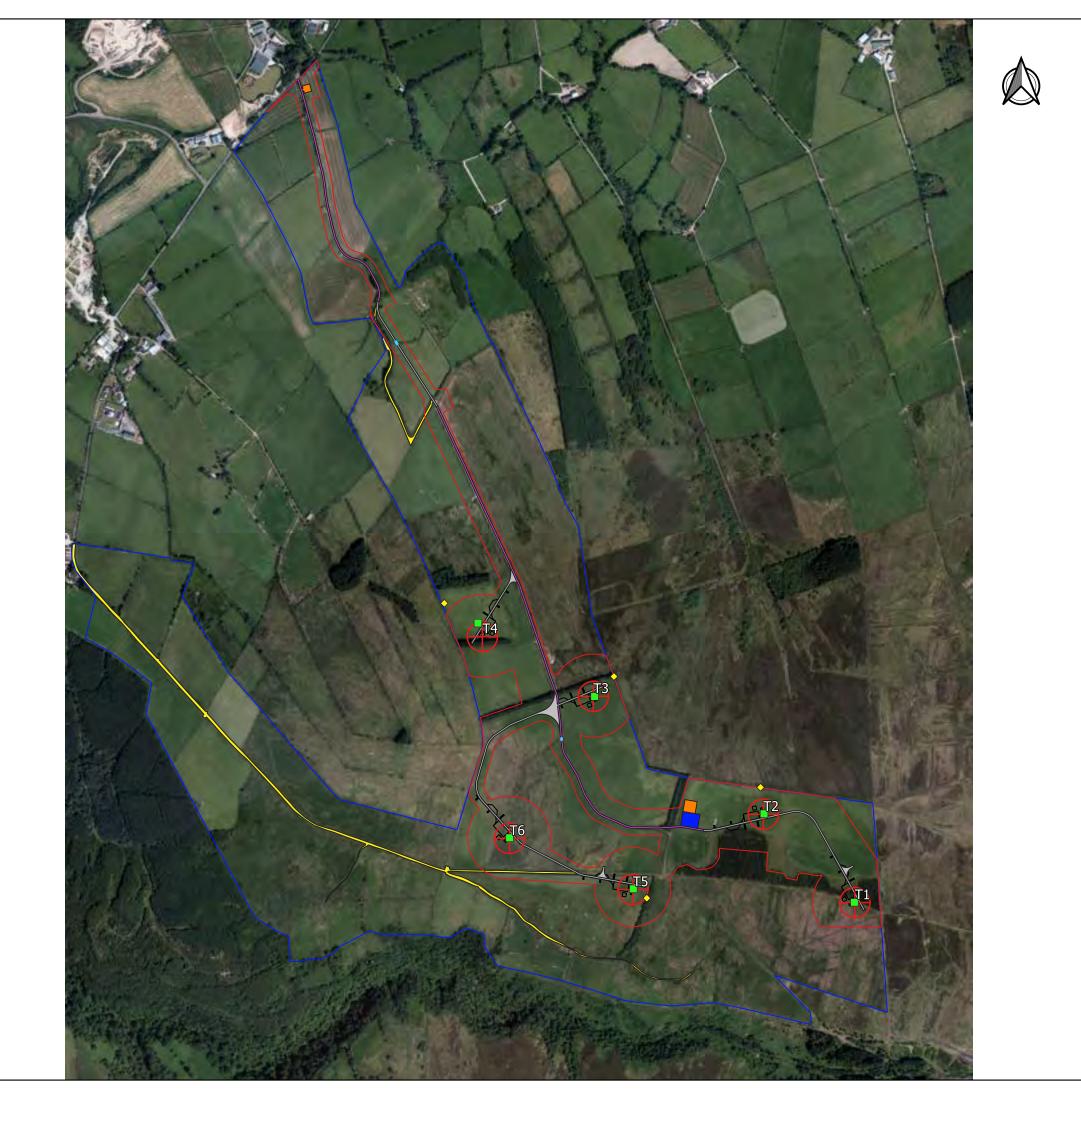TURBINE LOCATION

UPGRADED ACCESS TRACK
ACCESS TRACK (NEW)

CRANE HARDSTANDING AREA
EXISTING TRACK

WATERCOURSE

TEMPORARY CONSTRUCTION COMPOUND

CONTROL BUILDING

SURVEYORS



DRAWING NUMBER

COORDS TM65 IRISH GRID

PURPOSE

ENVIRONMENTAL IMPACT ASSESSMENT

SCALE 1:10,000

ORIGINAL PLOT SIZE A3

PROJECT TITLE

MAGHERAMORE WIND FARM

FIGURE 6.6 STATIC DETECTOR LOCATIONS


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PLANNING APPLICATION BOUNDARY

LAND UNDER APPLICANT CONTROL

★ BADGER SIGHTING 29-05-18

★ BADGER SIGHTING 09-08-18

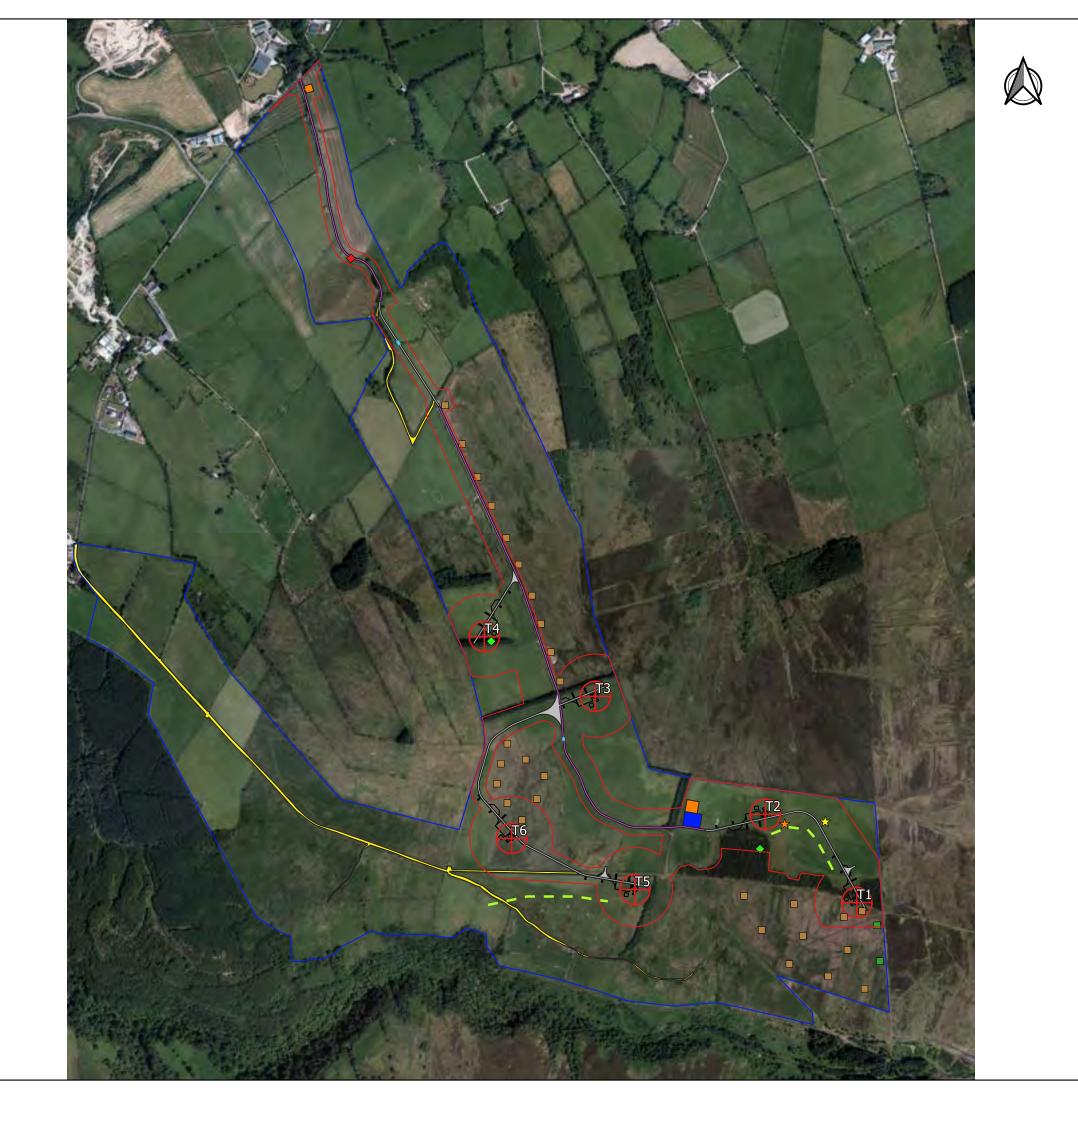BADGER TRAIL

◆ TRAIL CAMERA (BADGER)

♦ TRAIL CAMERA (SQUIRREL) ■ ARTIFICIAL REFUGIA LOCATION

LIZARD SIGHTING

TURBINE LOCATION

UPGRADED ACCESS TRACK ACCESS TRACK (NEW)

- CRANE HARDSTANDING AREA

EXISTING TRACK

WATERCOURSE

TEMPORARY CONSTRUCTION COMPOUND

CONTROL BUILDING

SURVEYORS



DRAWING NUMBER

COORDS

TM65 IRISH GRID

PURPOSE

ENVIRONMENTAL IMPACT ASSESSMENT

SCALE

ORIGINAL PLOT SIZE A3 1:10,000

PROJECT TITLE

MAGHERAMORE WIND FARM

FIGURE 6.7 MAMMAL & HERPETOLOGICAL SURVEY RESULTS


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**KEY** PL

PLANNING APPLICATION BOUNDARY

LAND UNDER APPLICANT CONTROL

NATURAL (WOODLAND) REGENERATION (1.13ha)

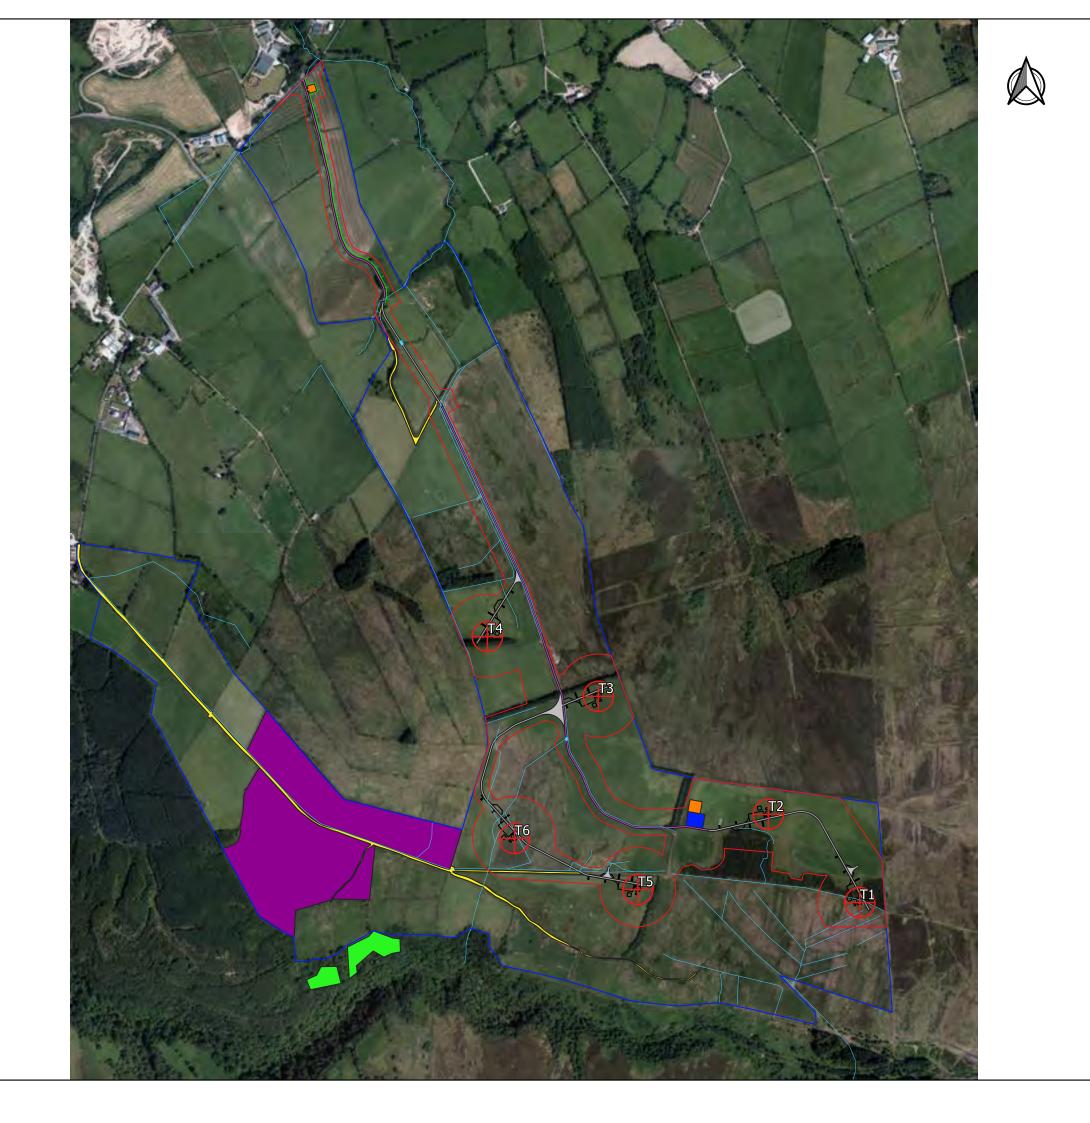HABITAT MANAGEMENT AREA (15.5ha)

TURBINE LOCATION

UPGRADED ACCESS TRACK

ACCESS TRACK (NEW)

CRANE HARDSTANDING AREA

EXISTING TRACK
WATERCOURSE

WATERCOURSE CROSSING

PROPOSED NEW HEDGING

TEMPORARY CONSTRUCTION COMPOUND

CONTROL BUILDING

SURVEYORS



DRAWING NUMBER

COORDS

TM65 IRISH GRID

PURPOSE

ENVIRONMENTAL IMPACT ASSESSMENT

SCALE 1:10,000

ORIGINAL PLOT SIZE A3

PROJECT TITLE

MAGHERAMORE WIND FARM

### FIGURE 6.8 HABITAT MANAGEMENT AREAS

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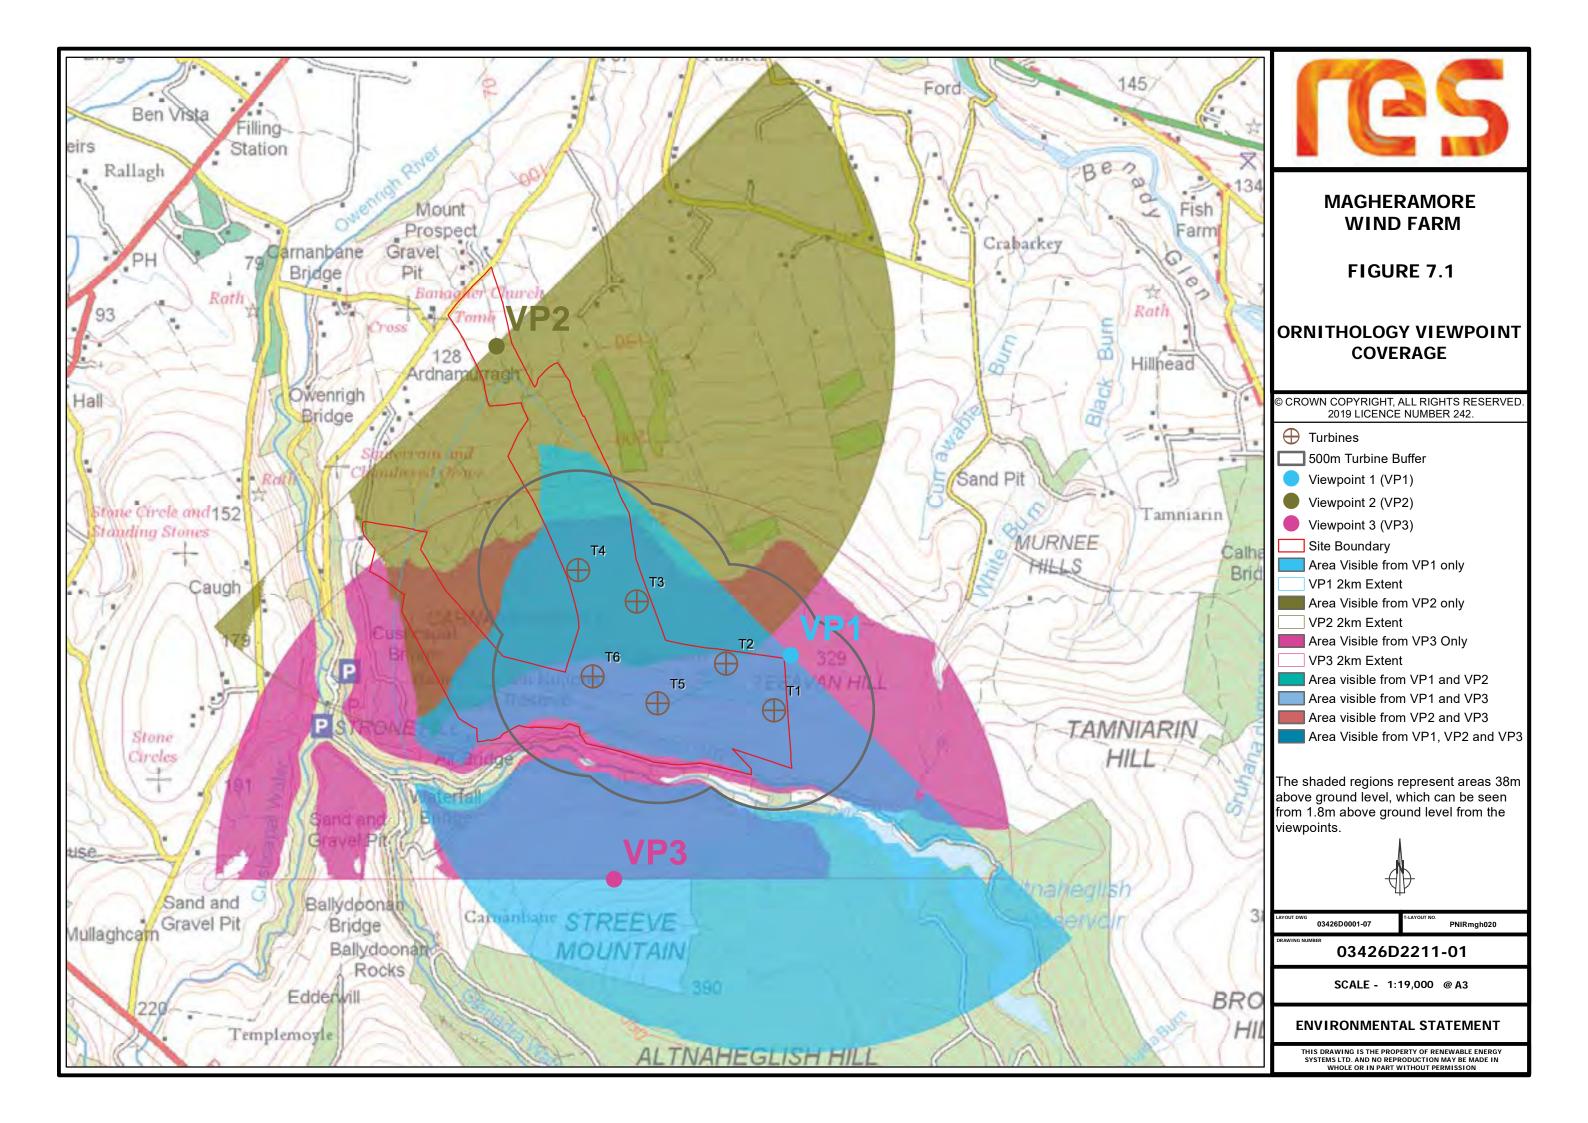












# Ornithology




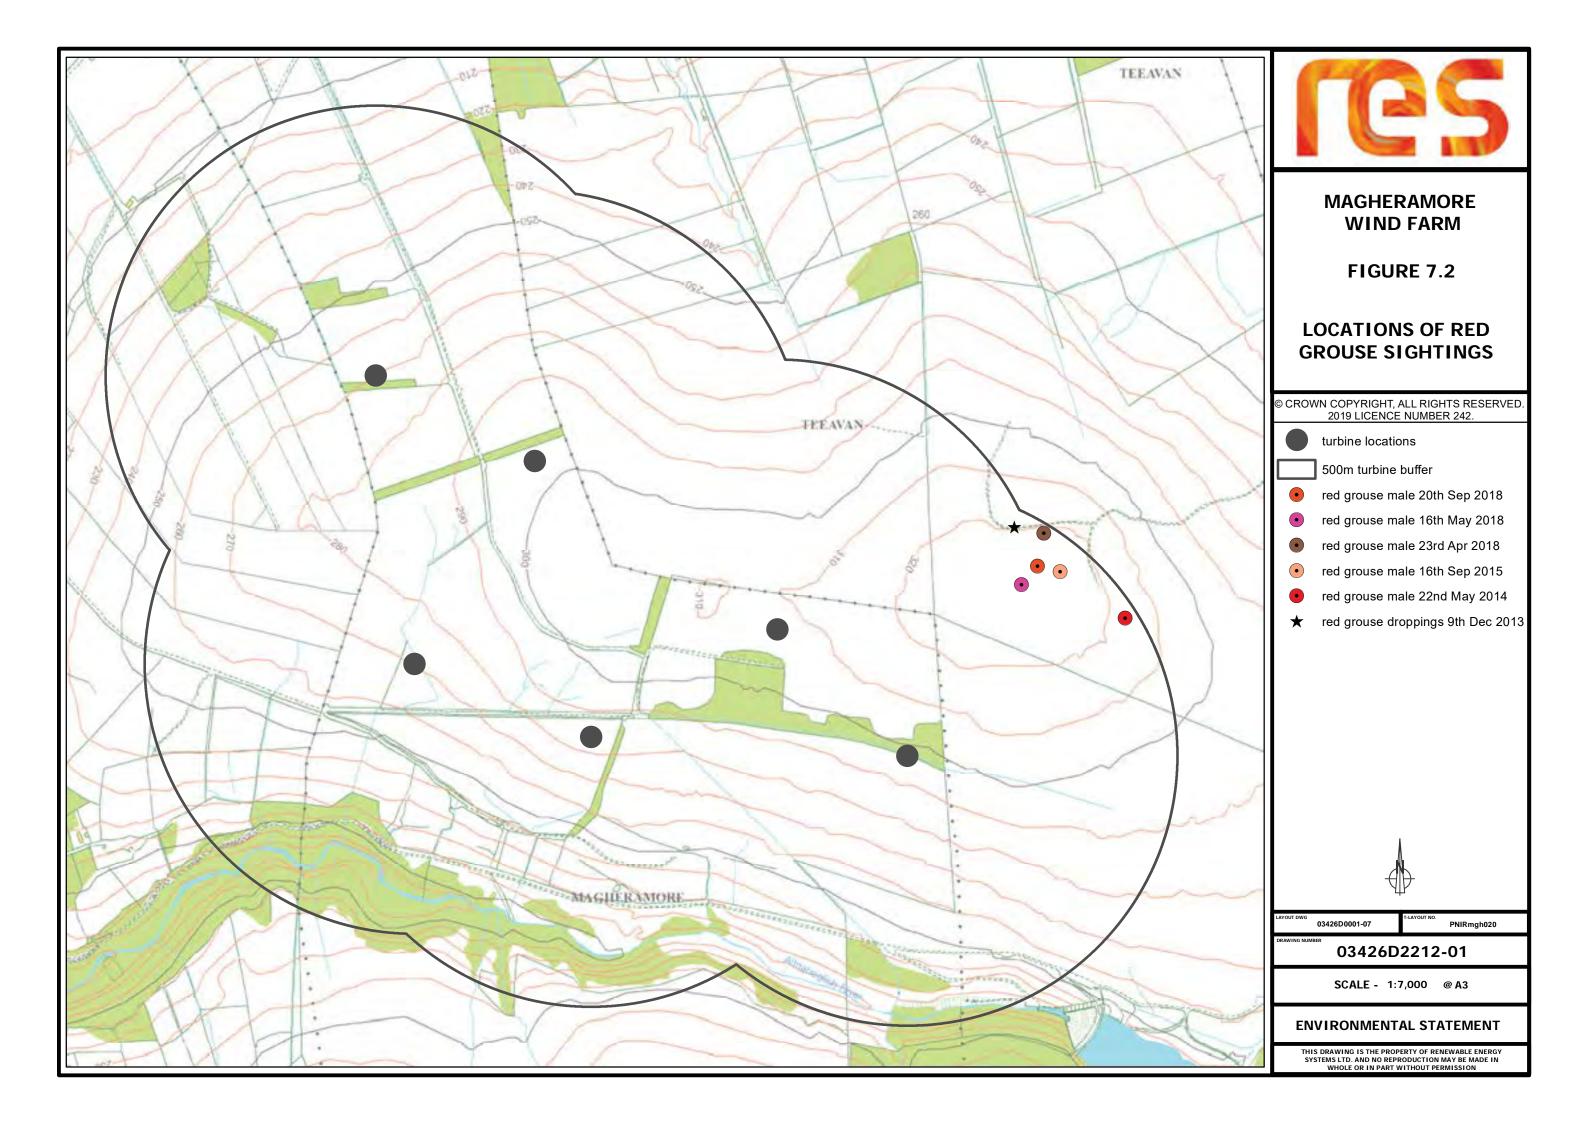


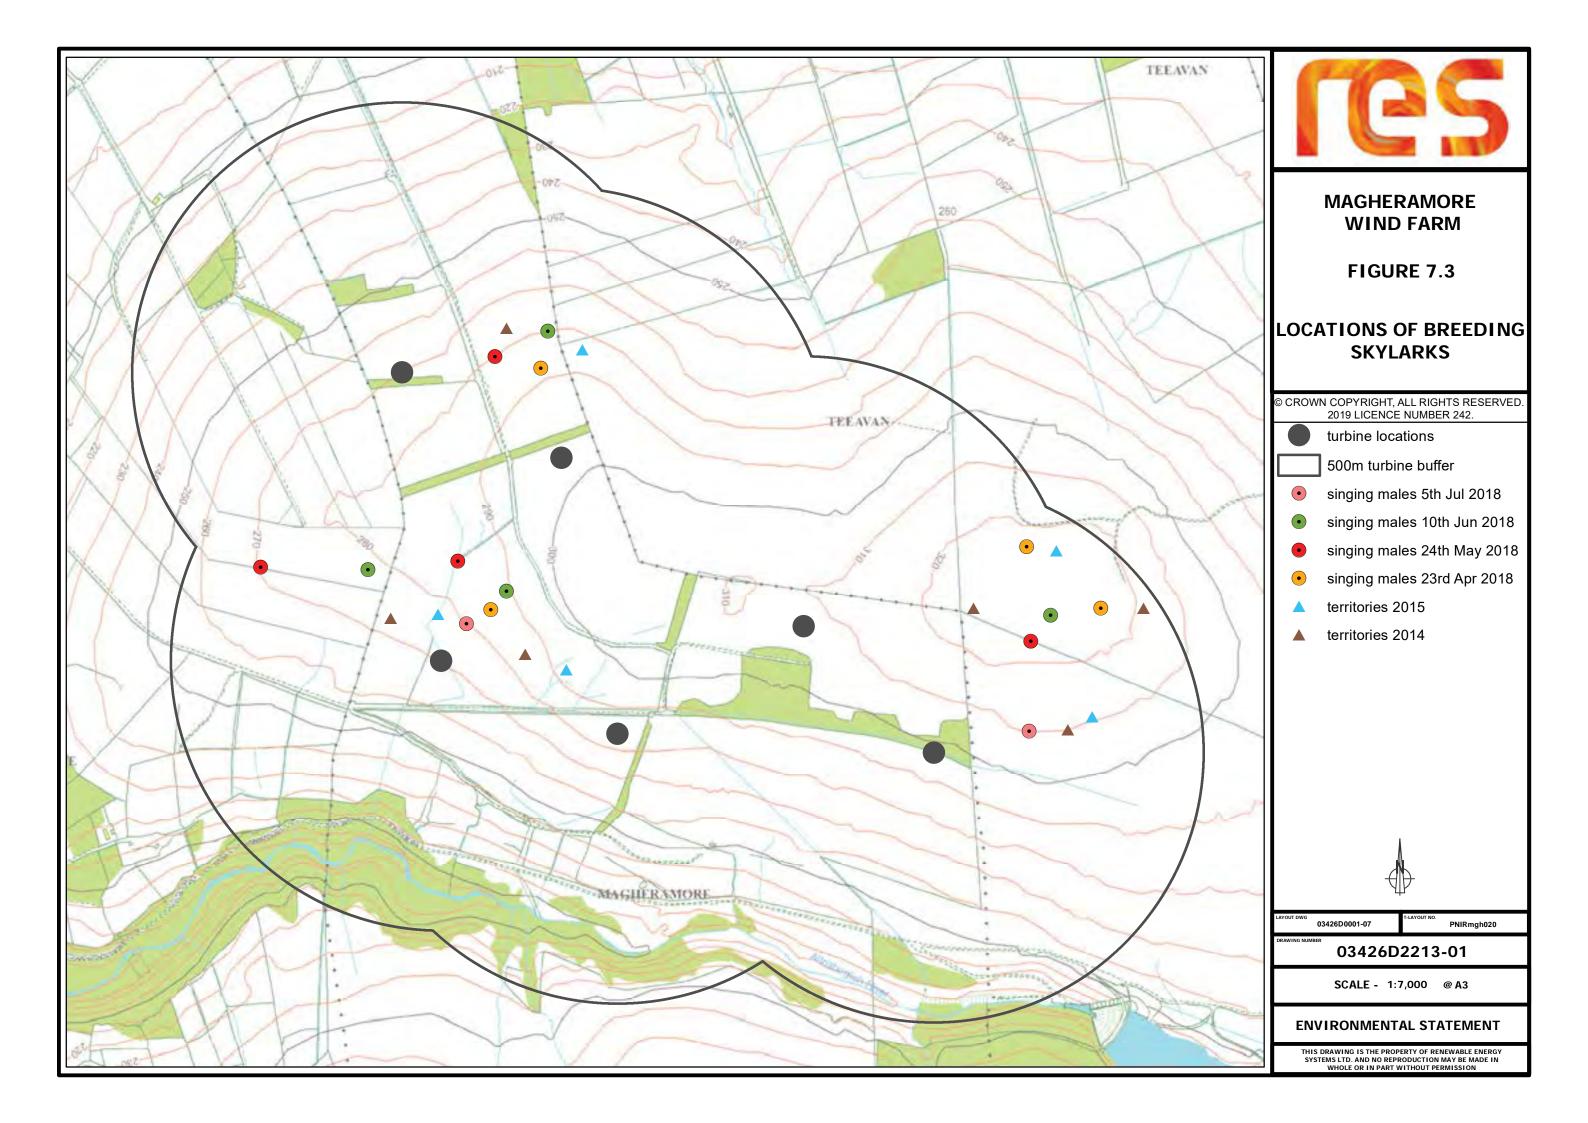


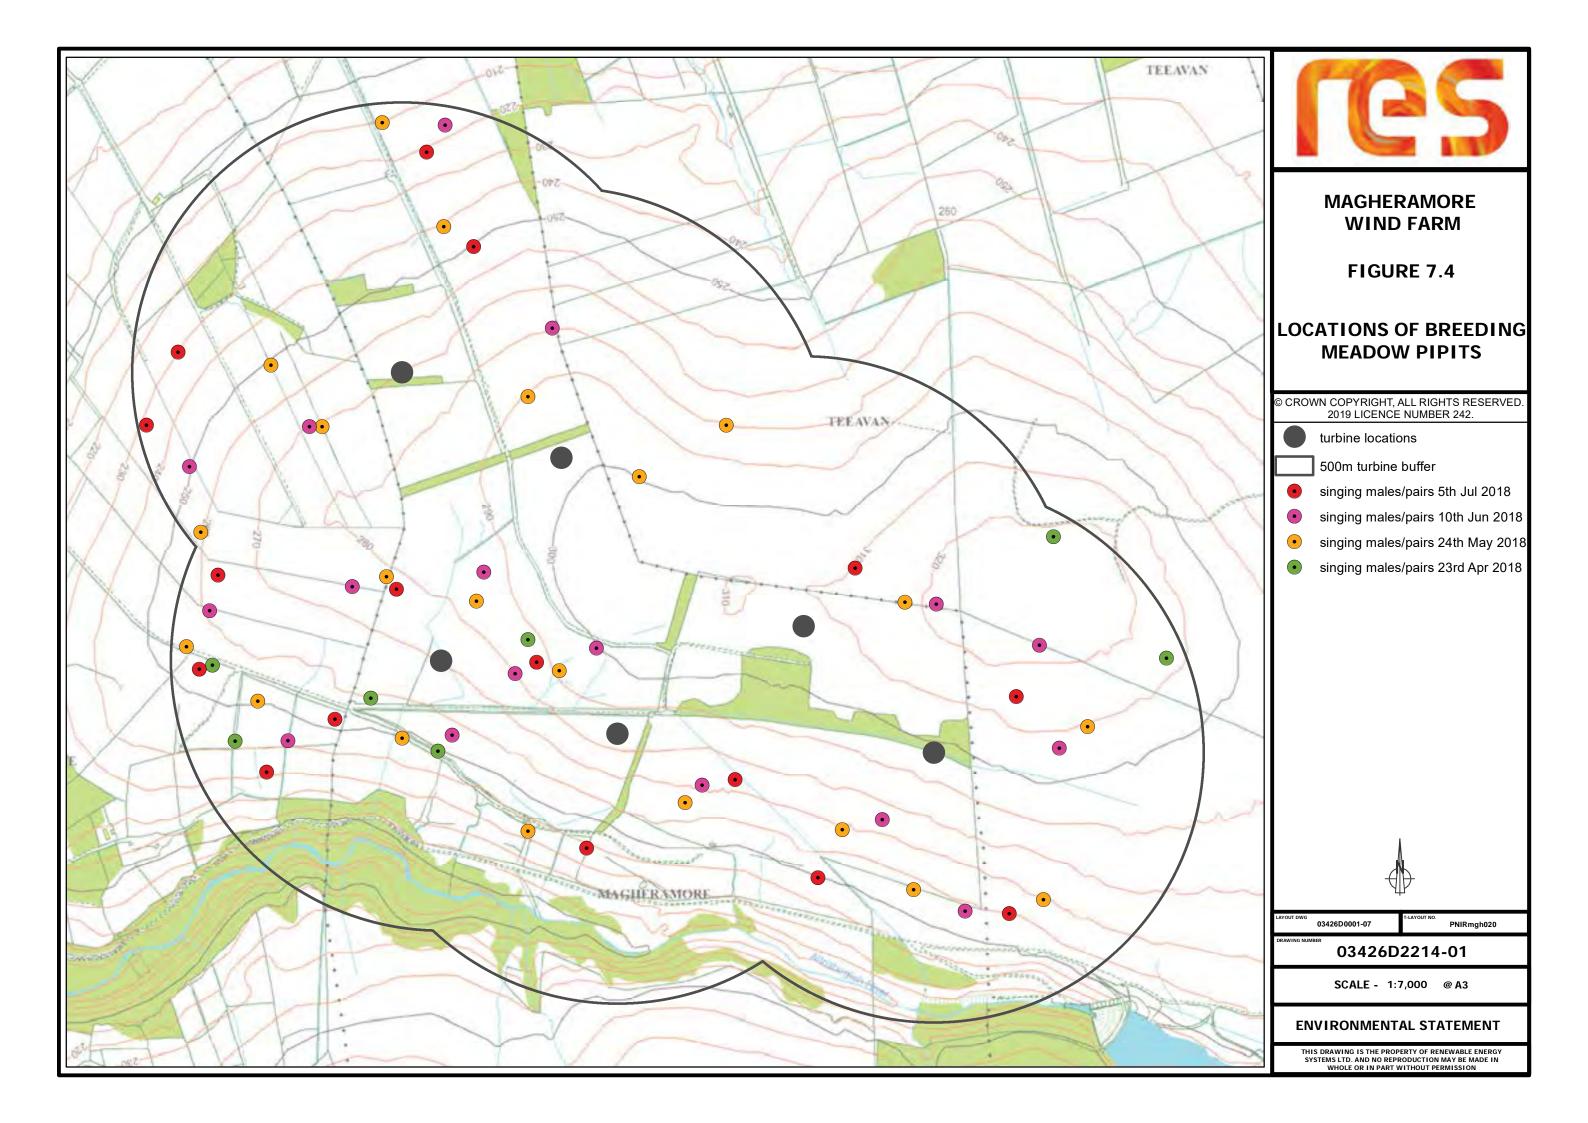


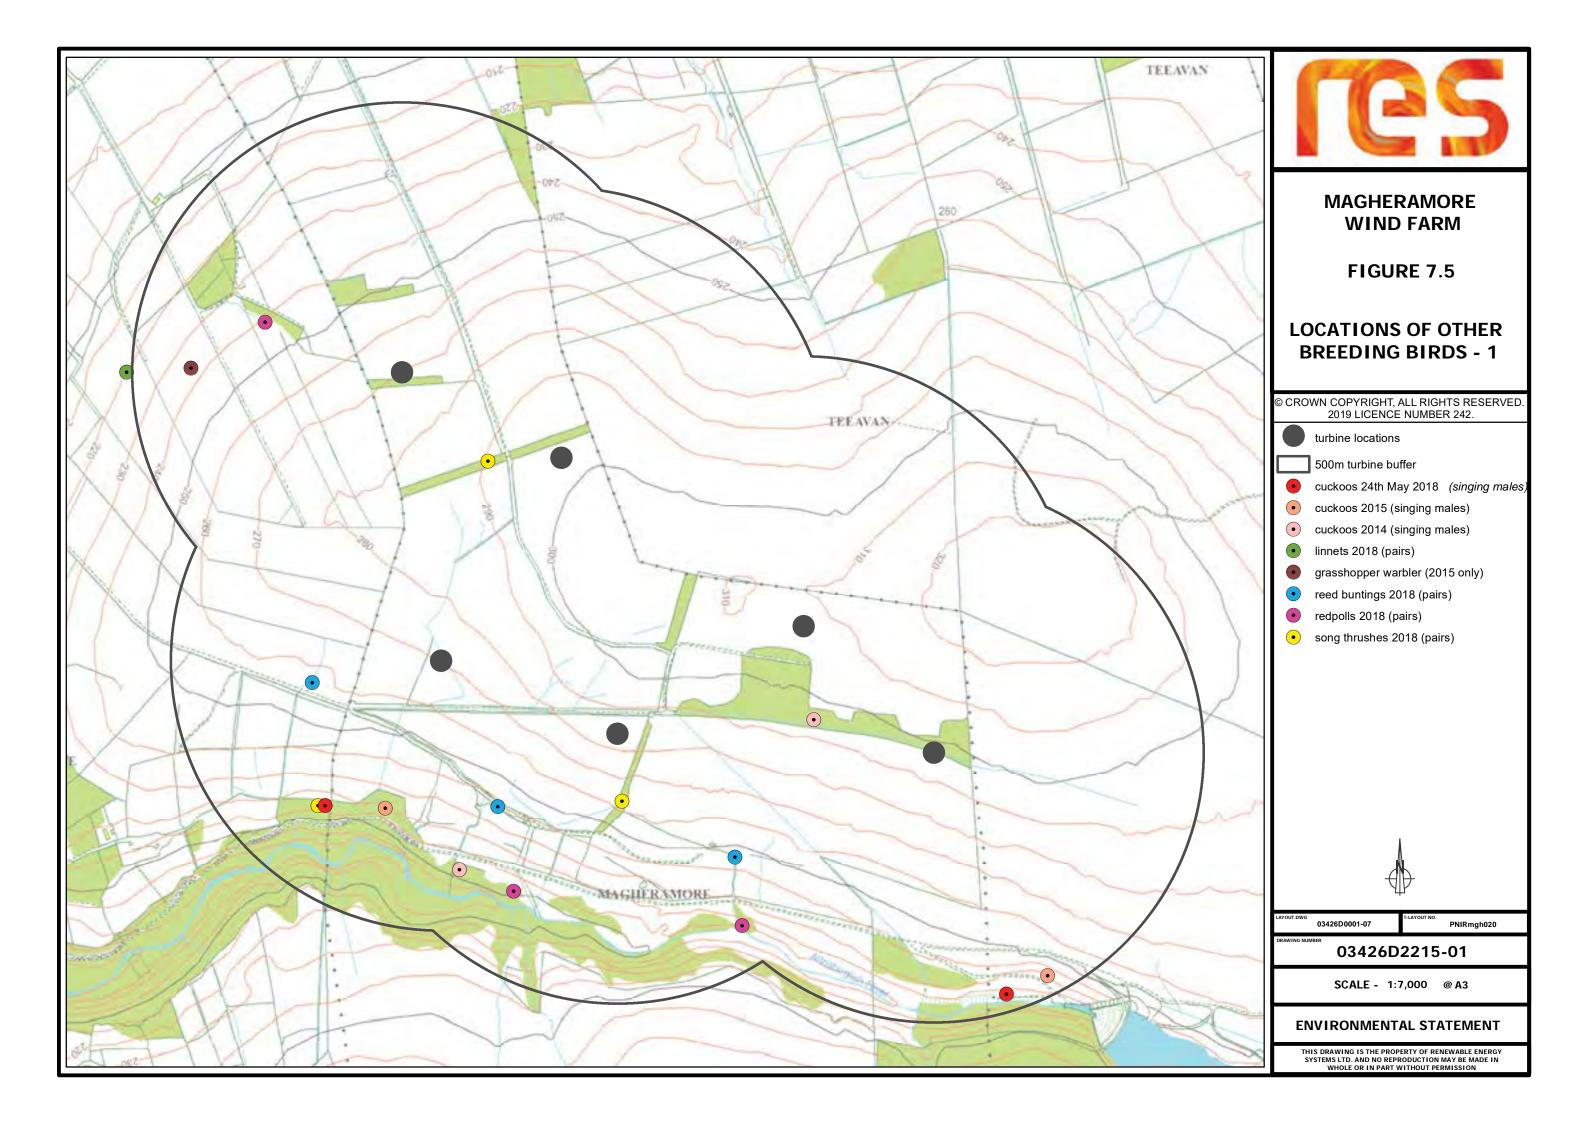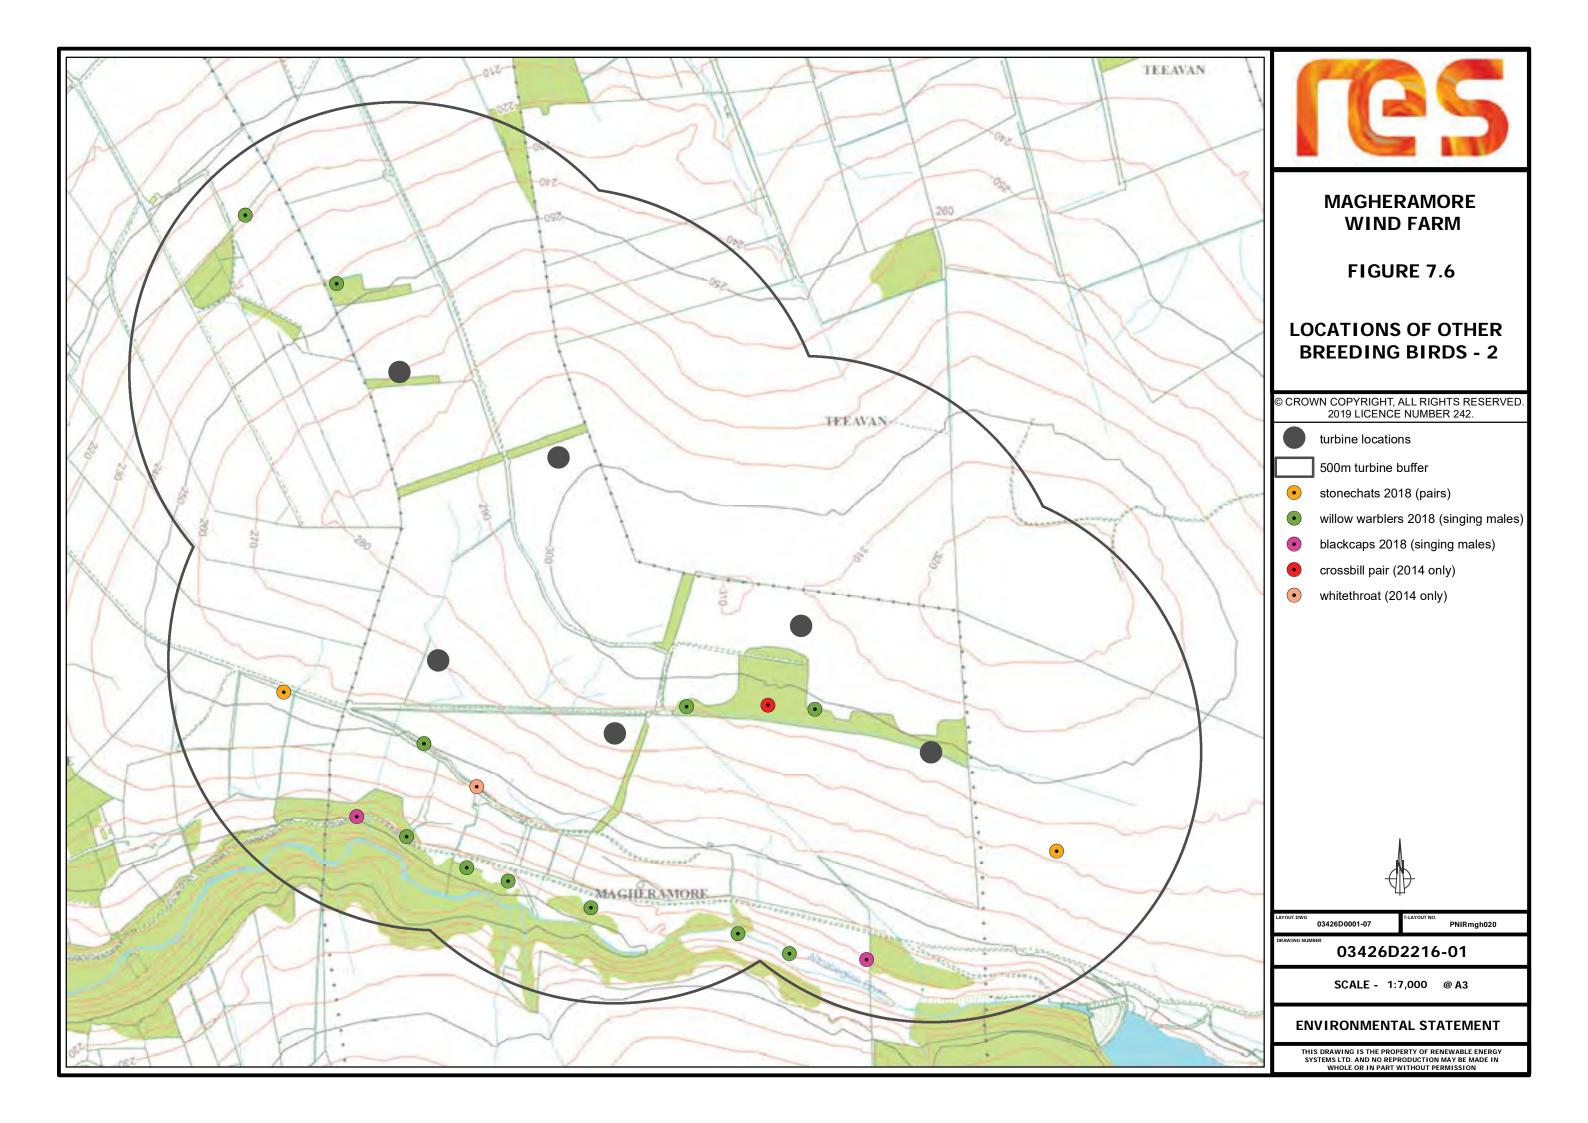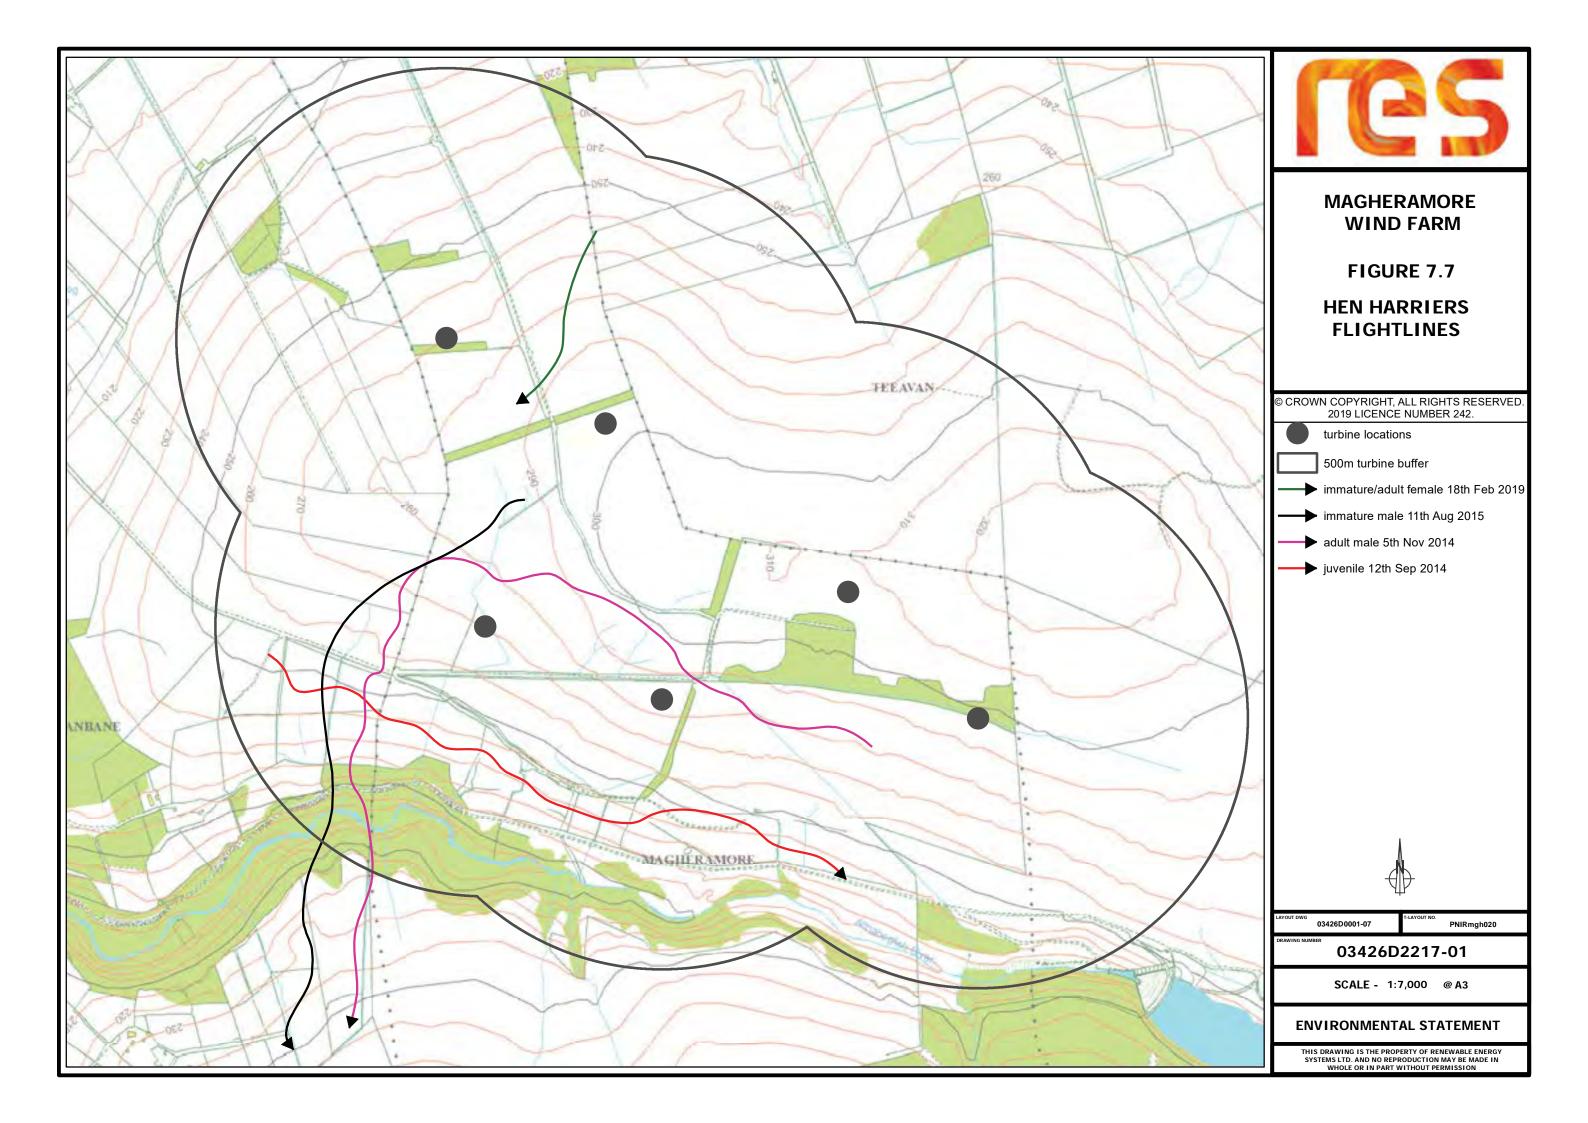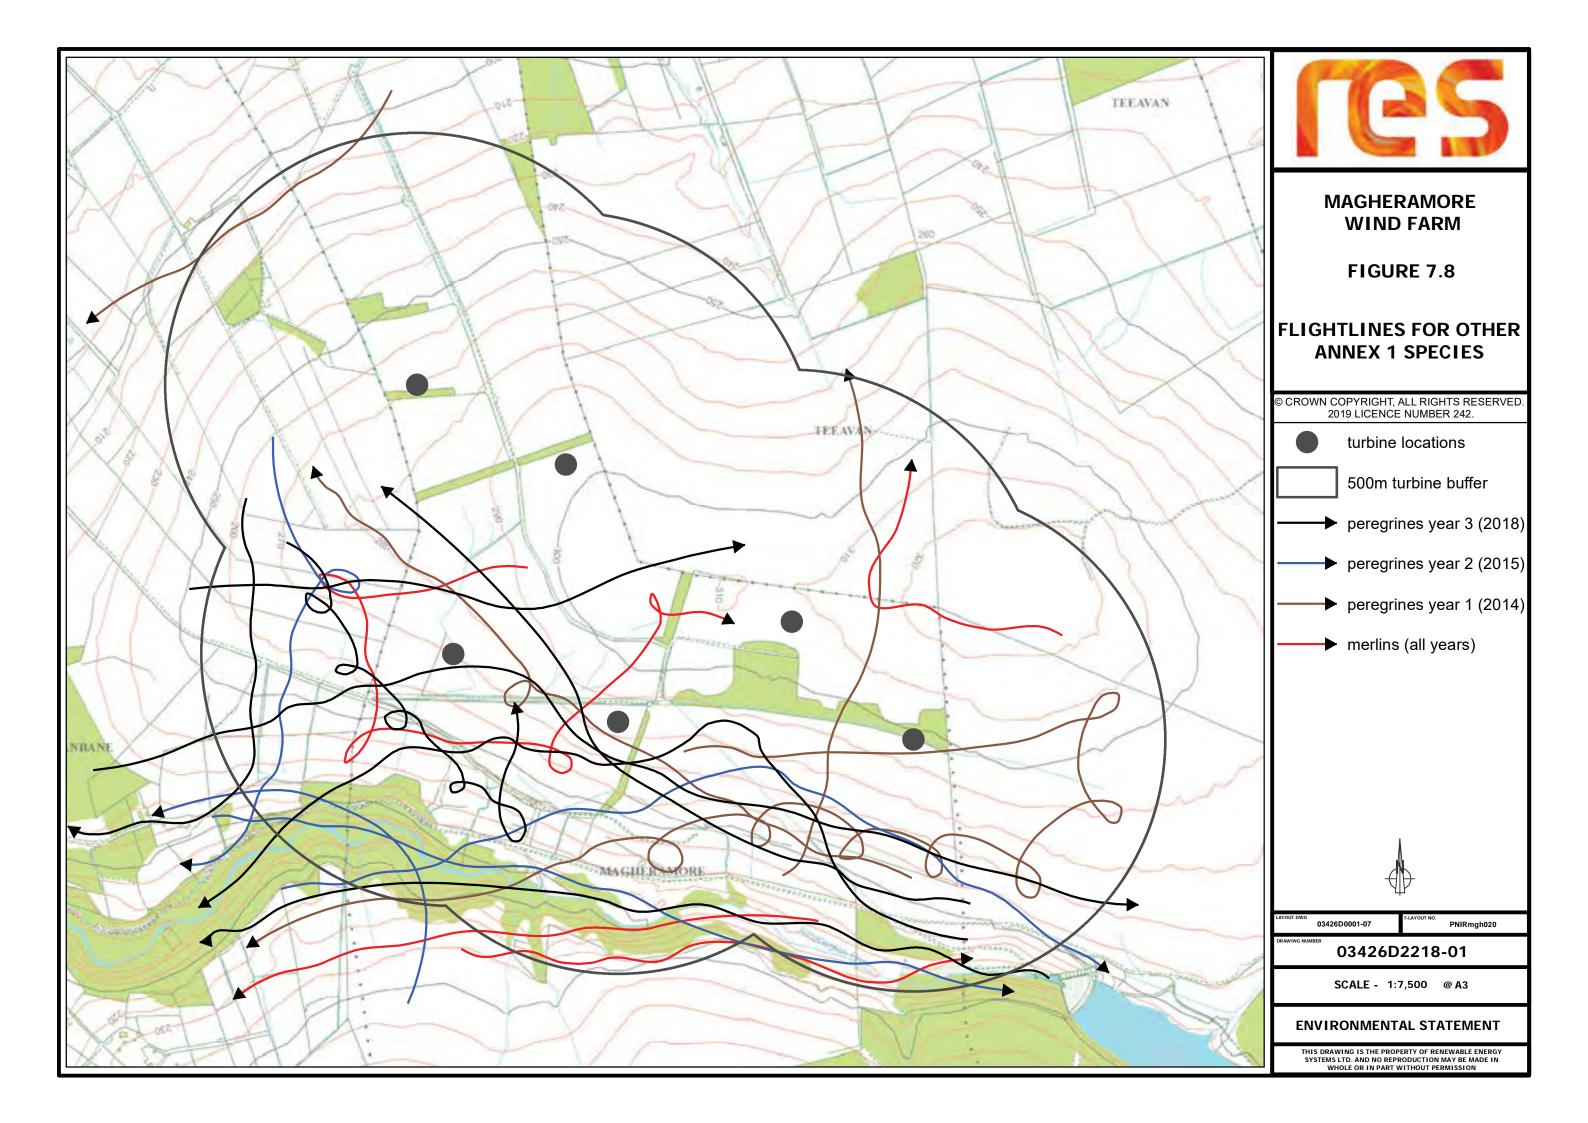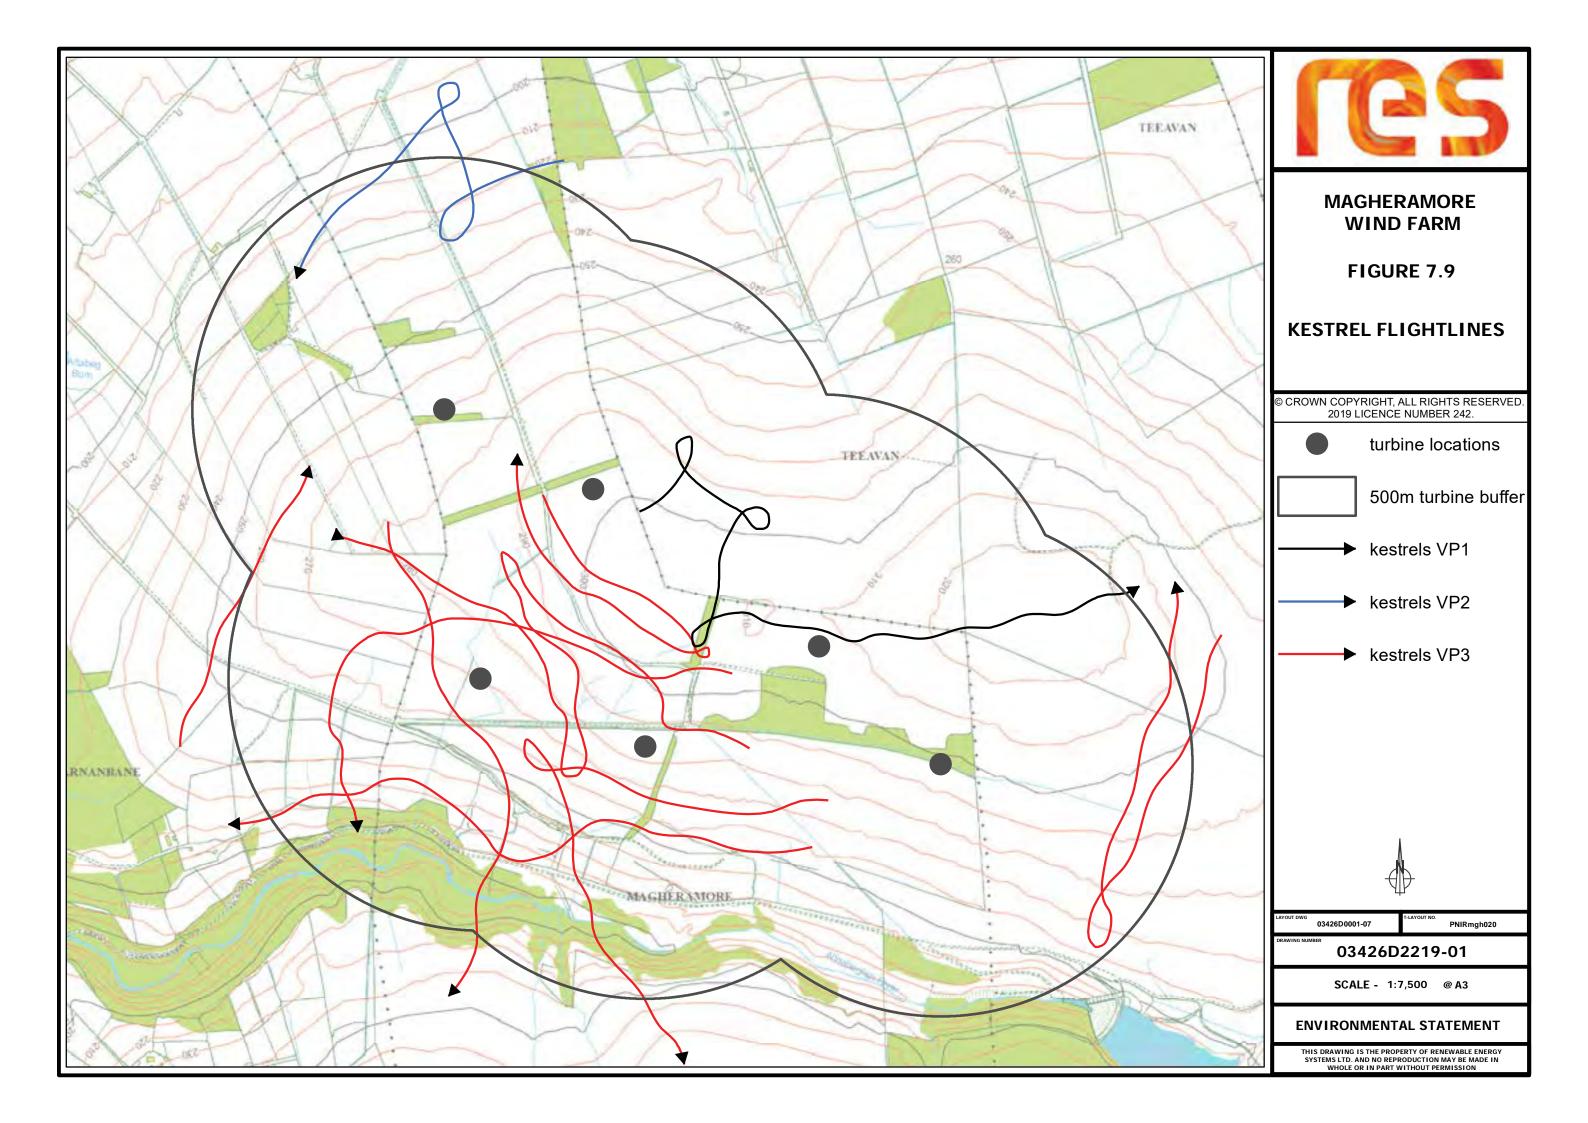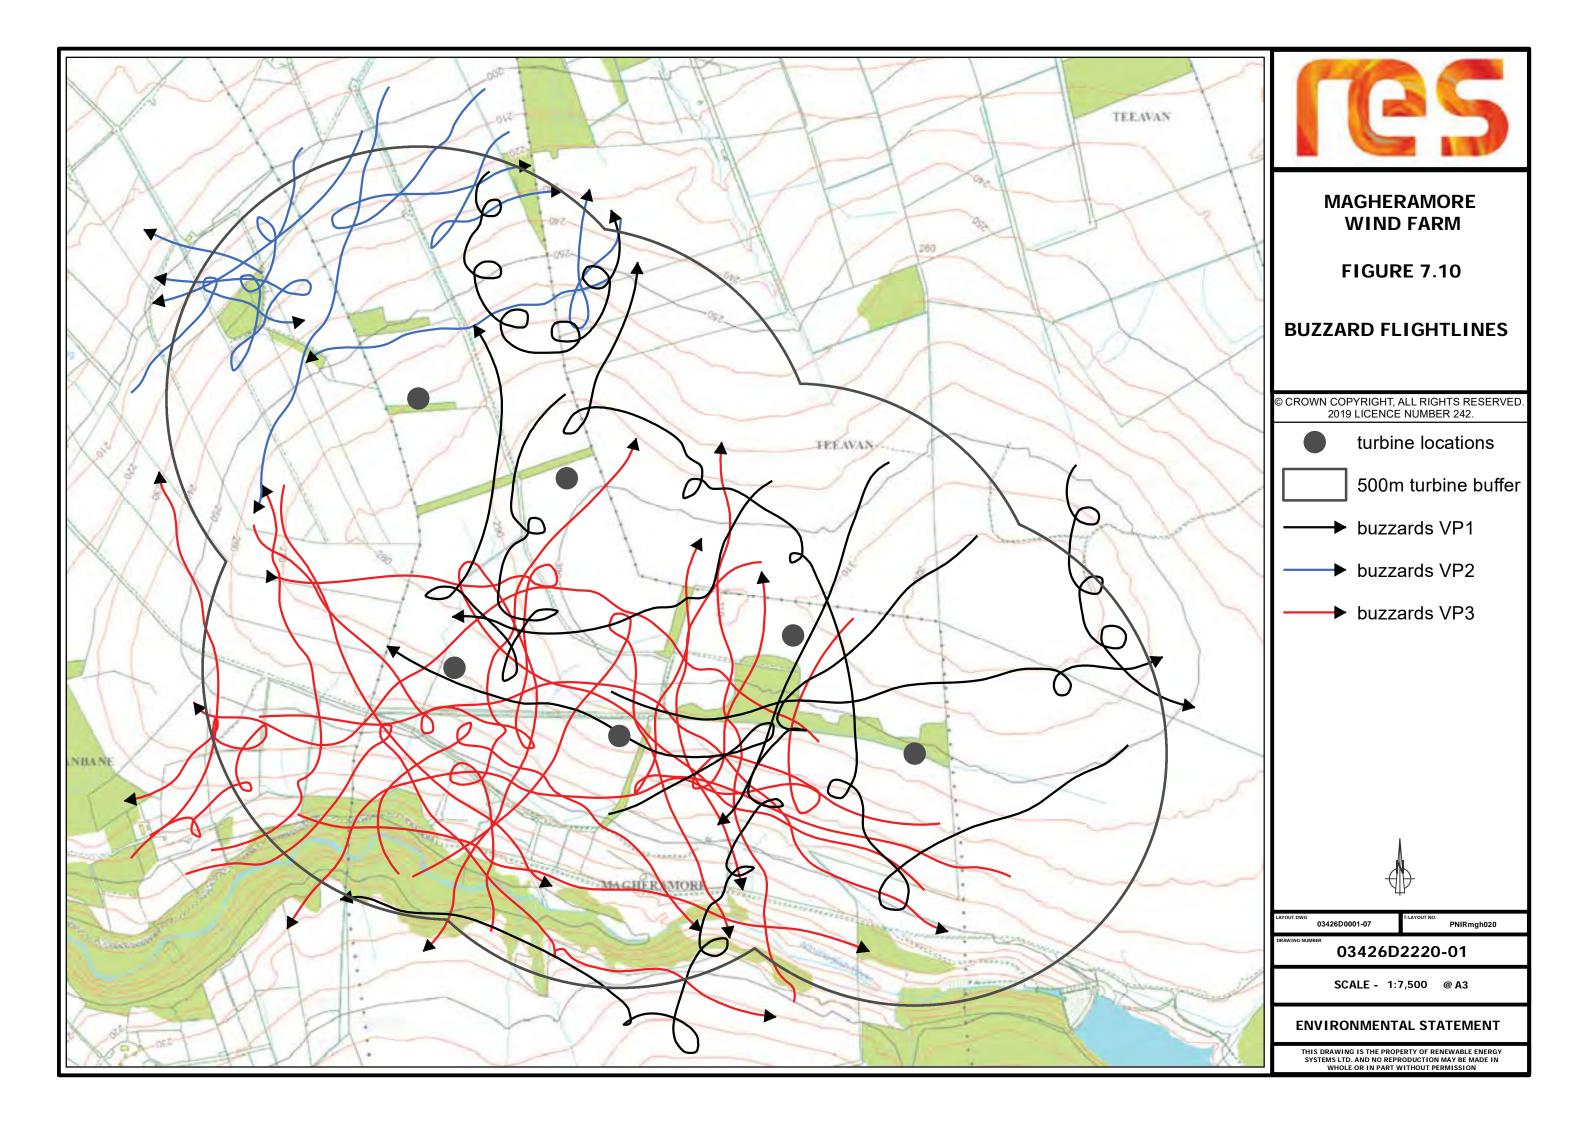


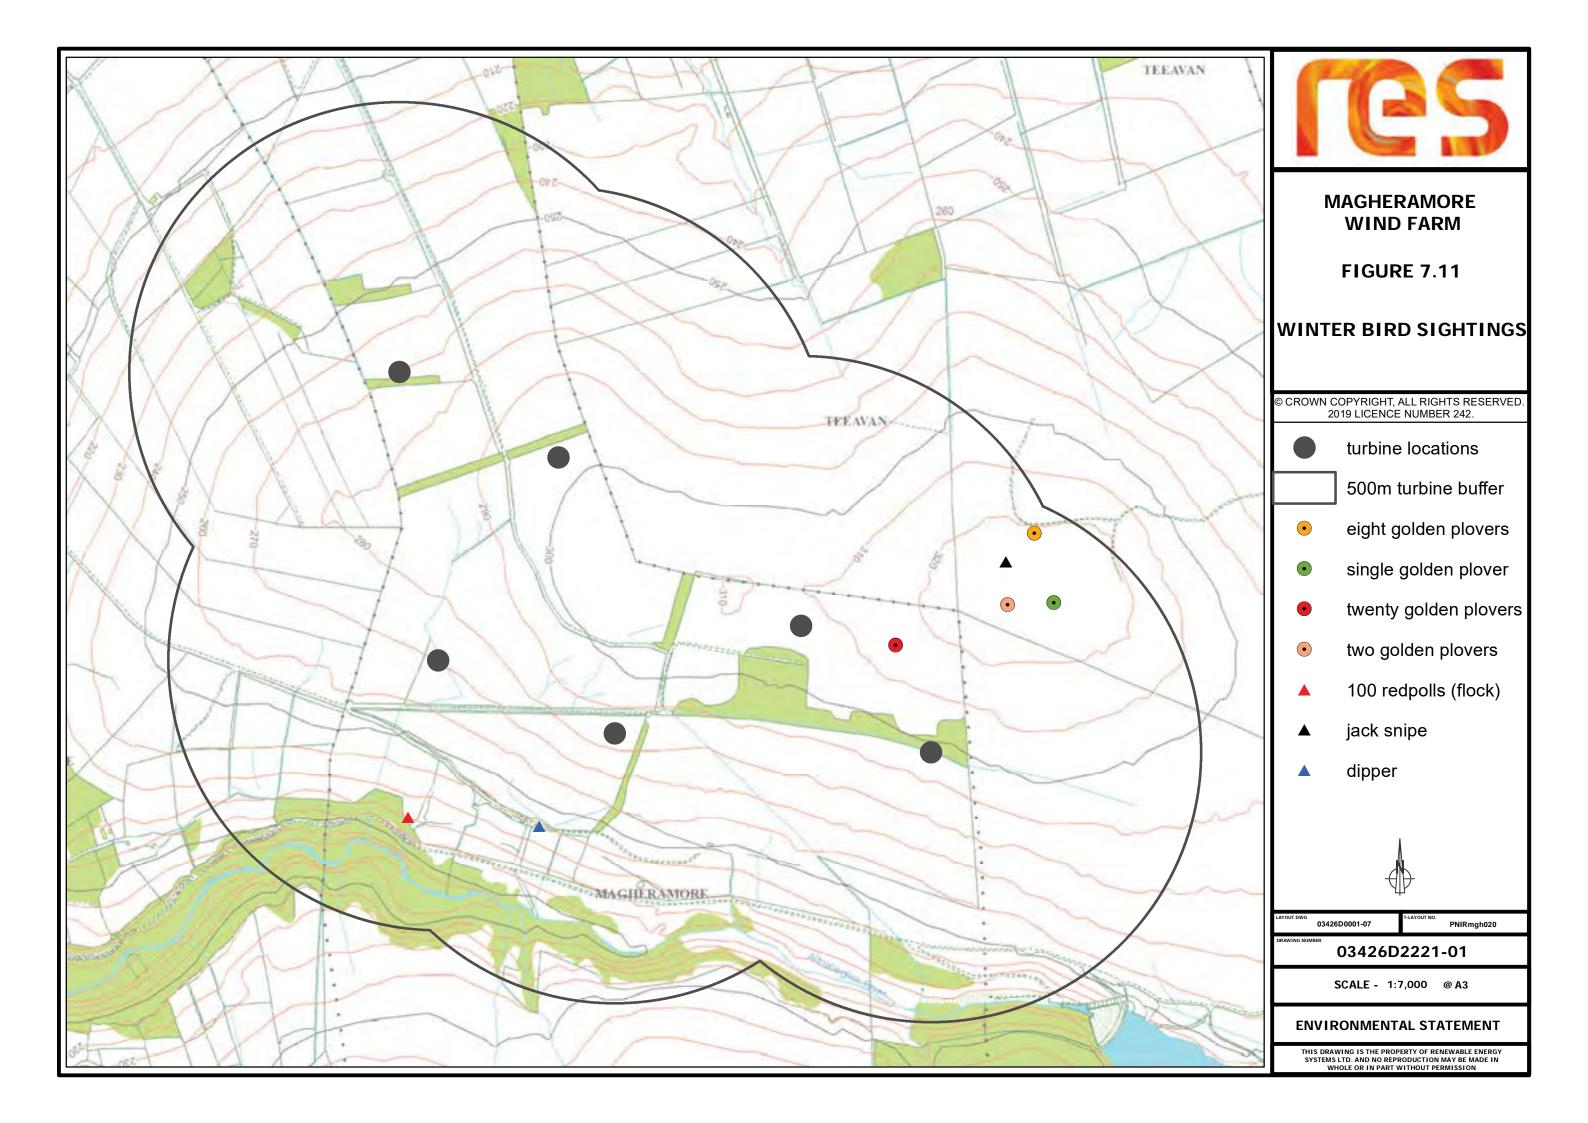















# Fisheries

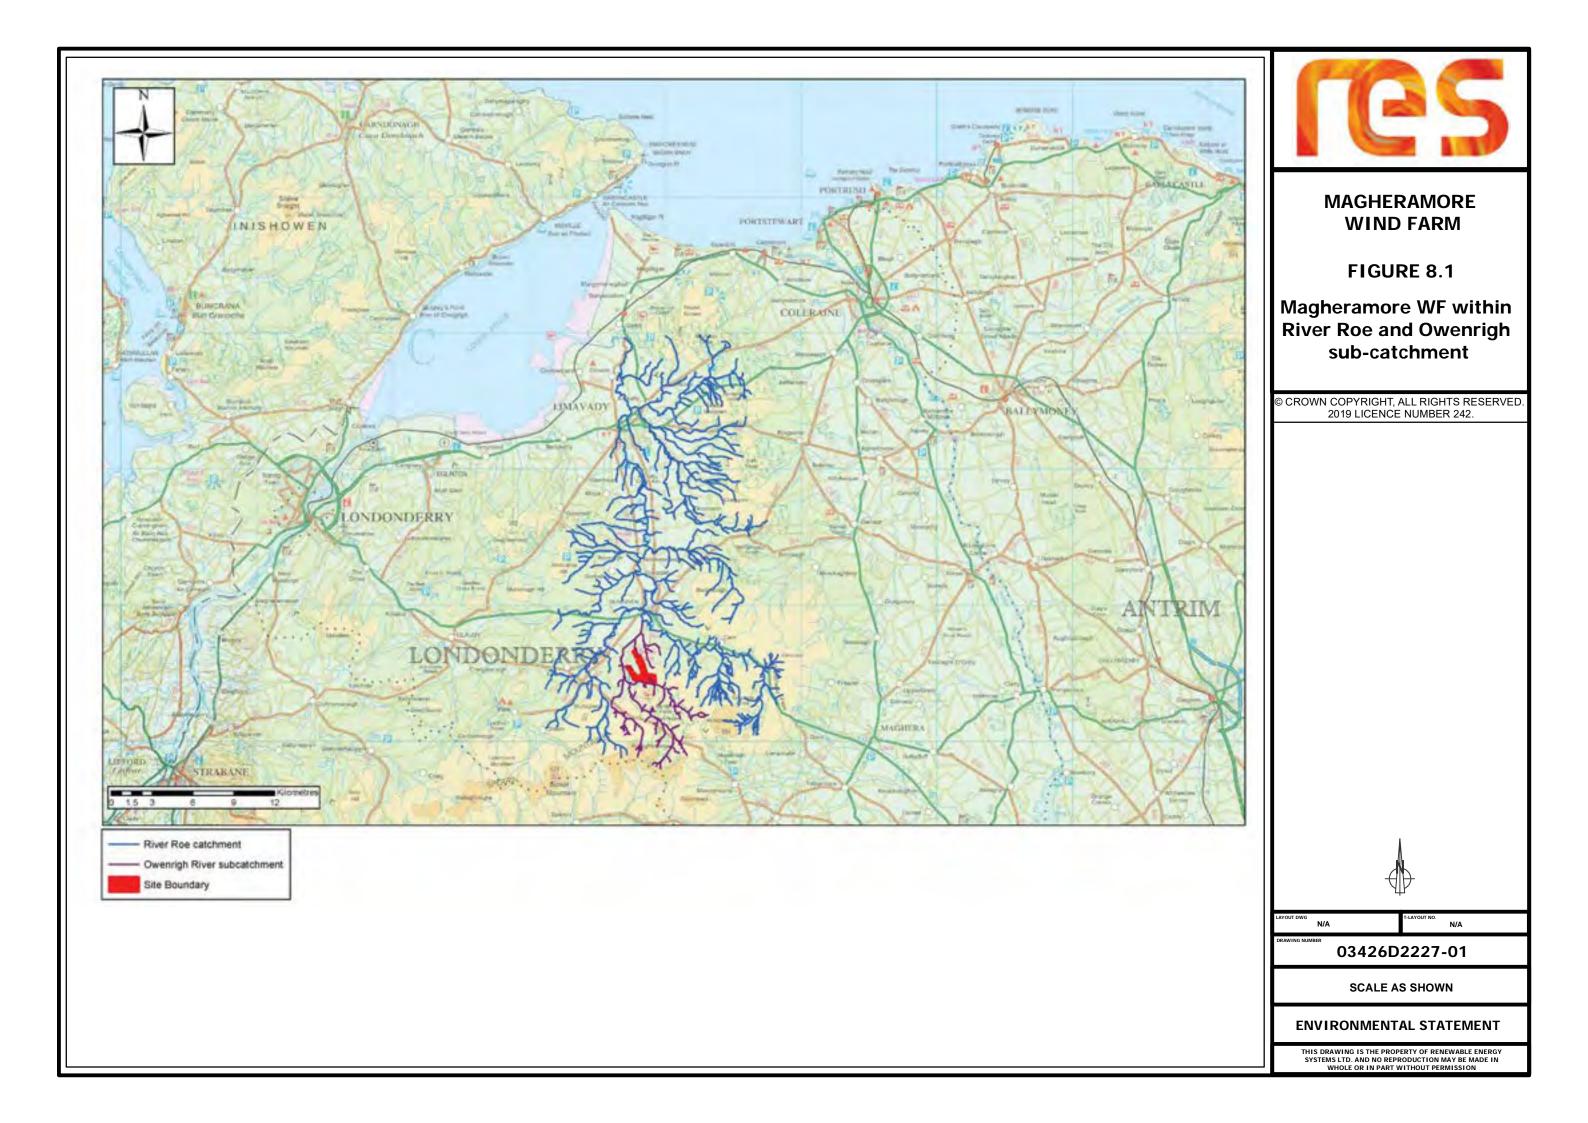

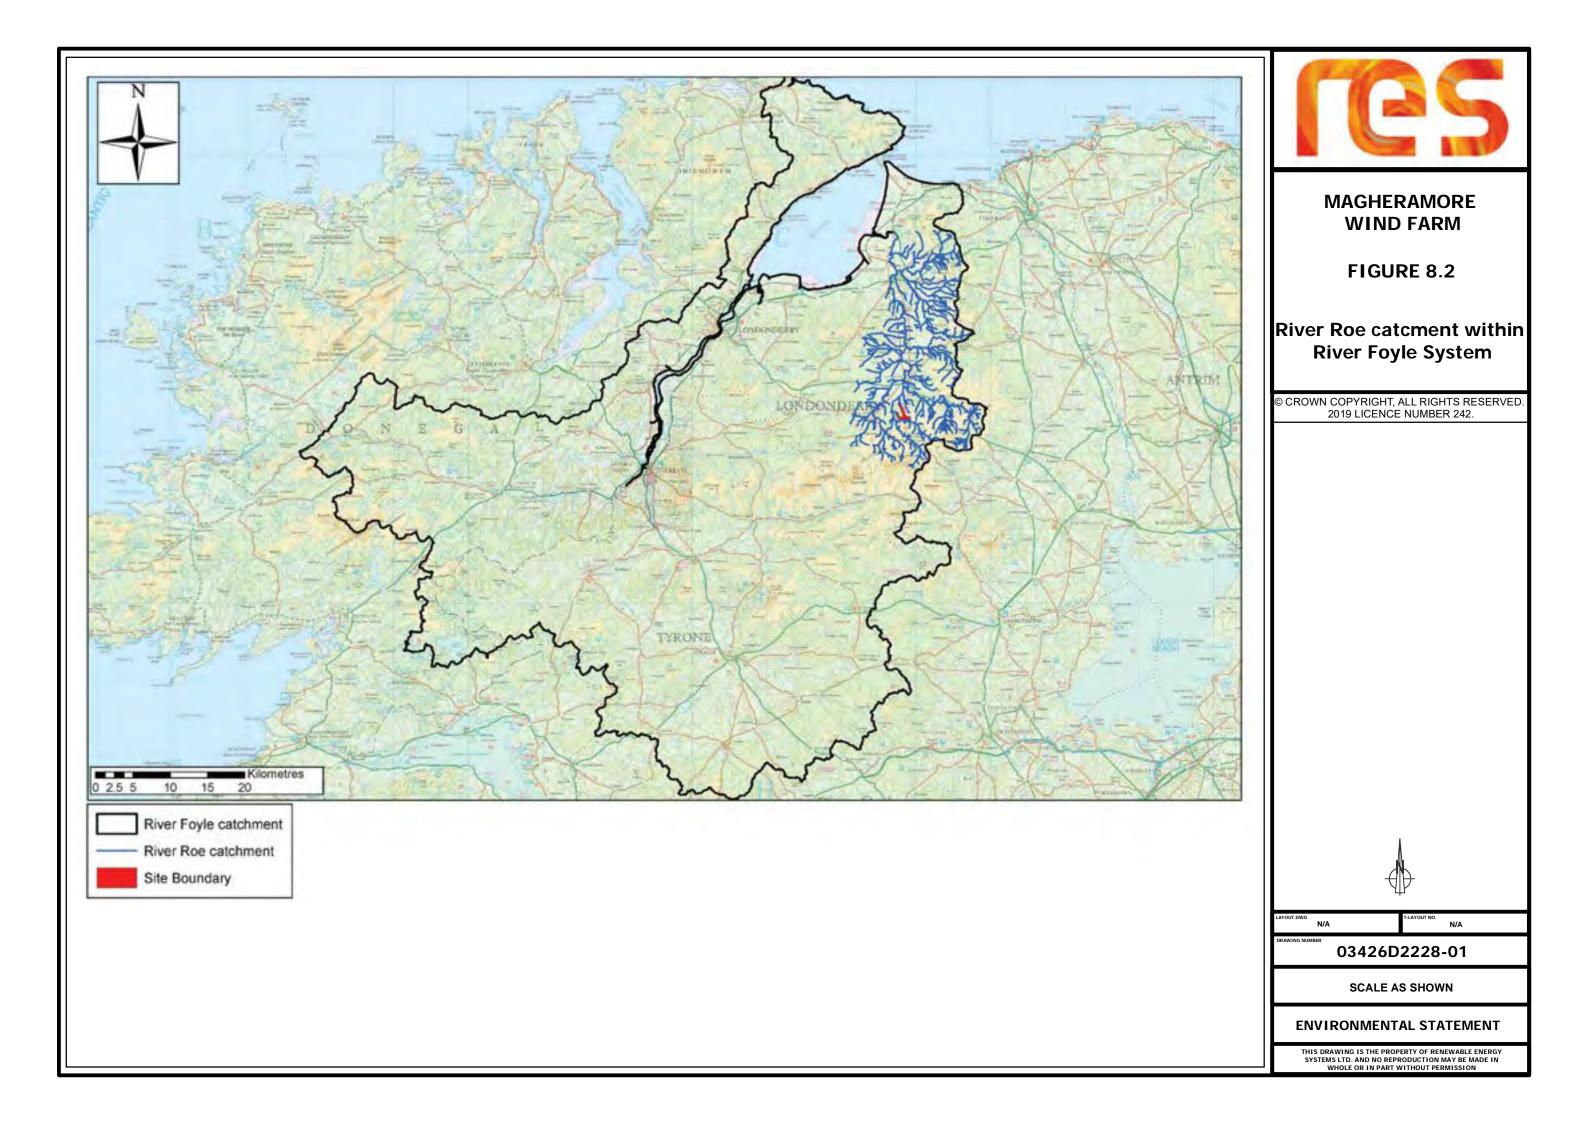

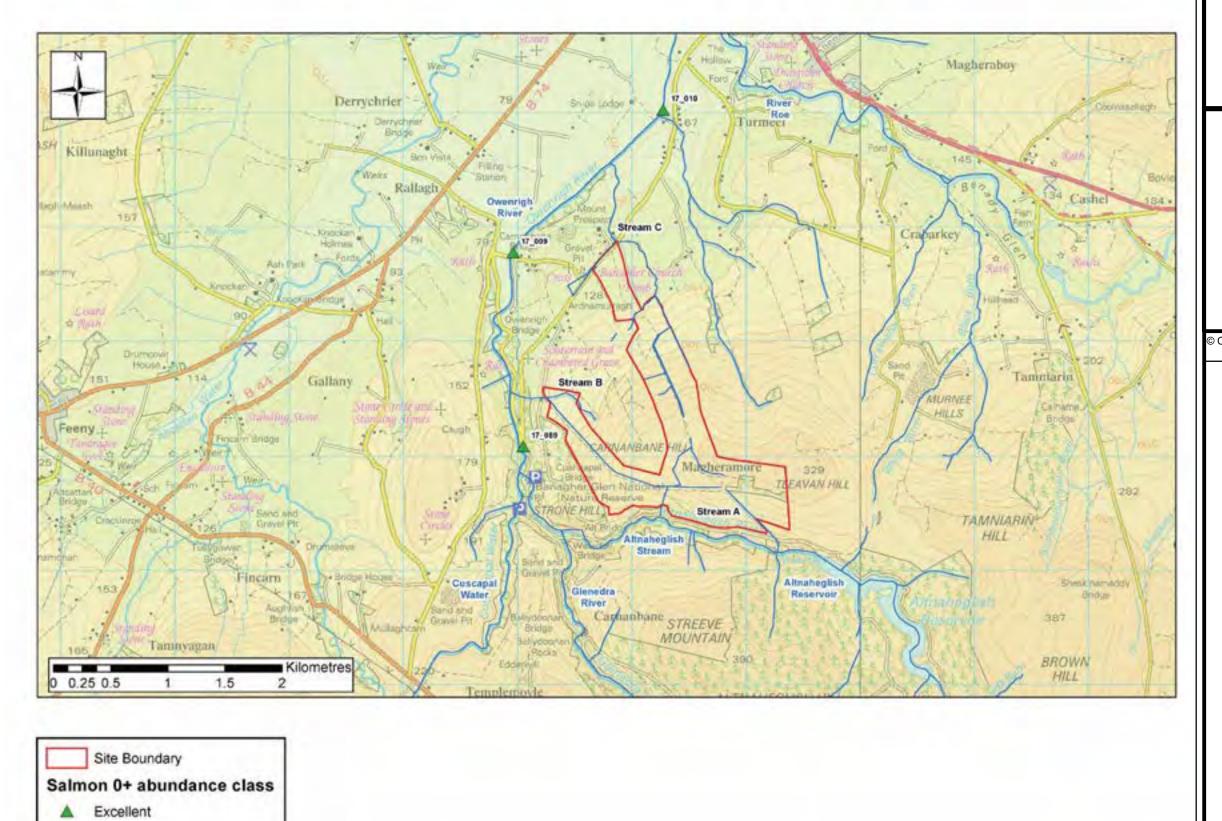



### MAGHERAMORE WIND FARM

FIGURE 8.3

Salmon fry (Age 0) abundance indices in Owenrigh River

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YOUT DWG N/A

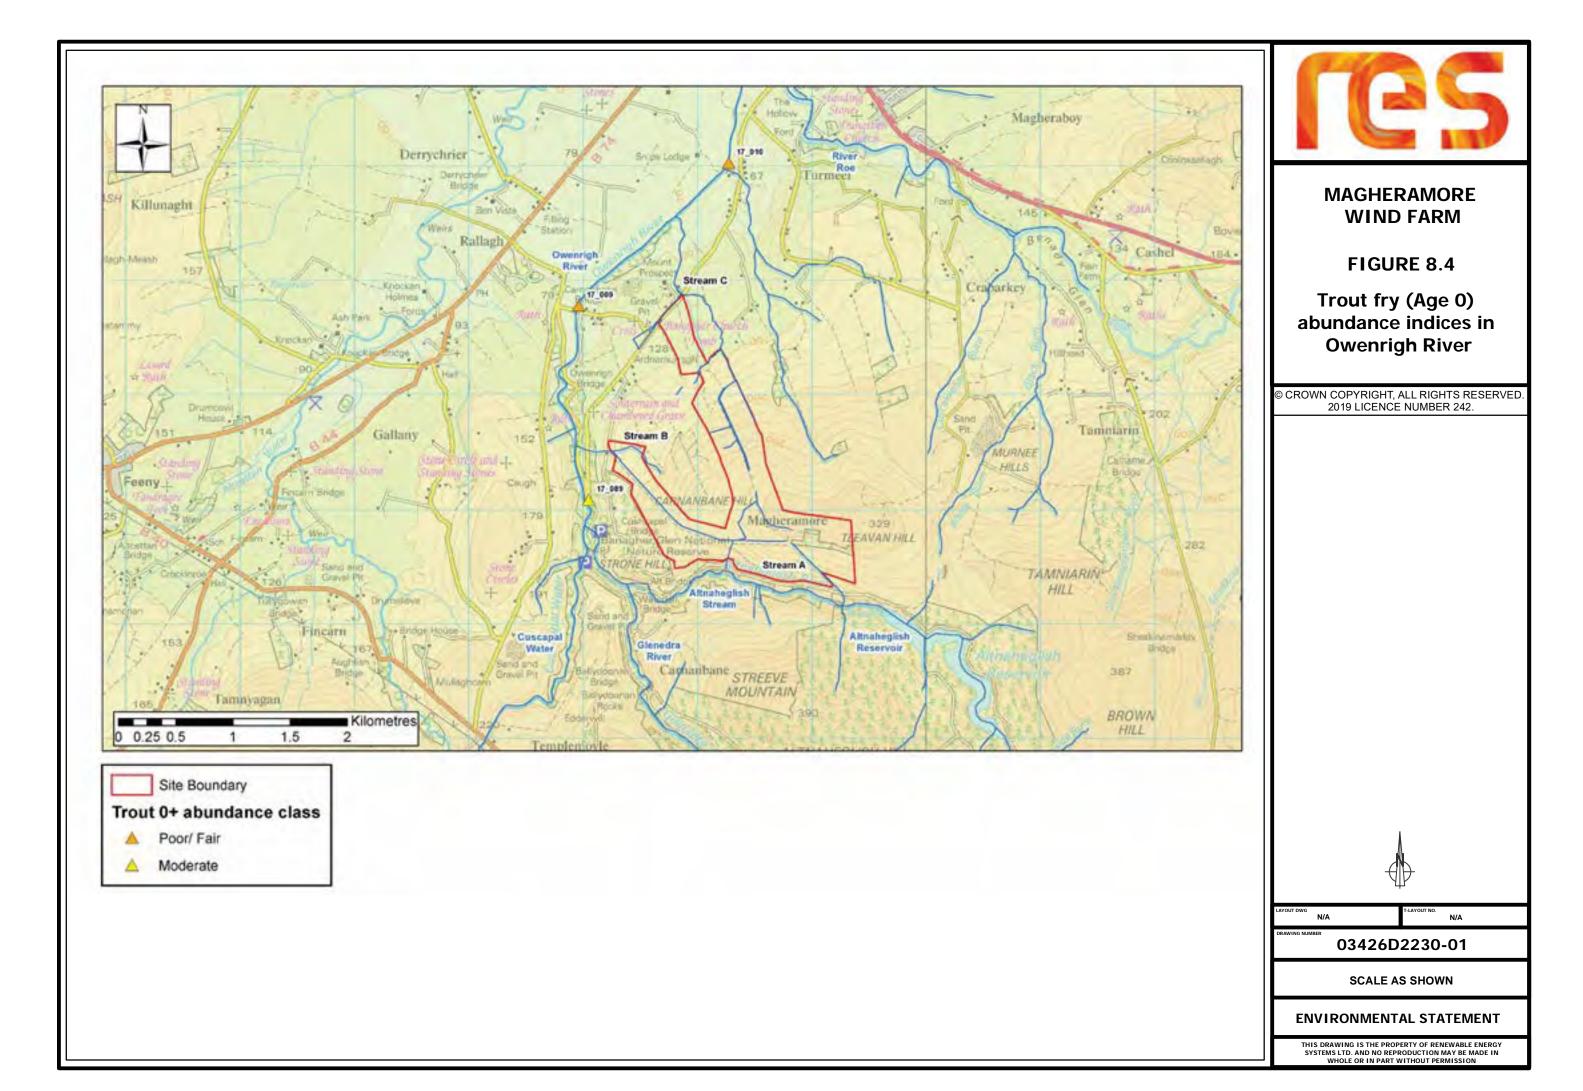
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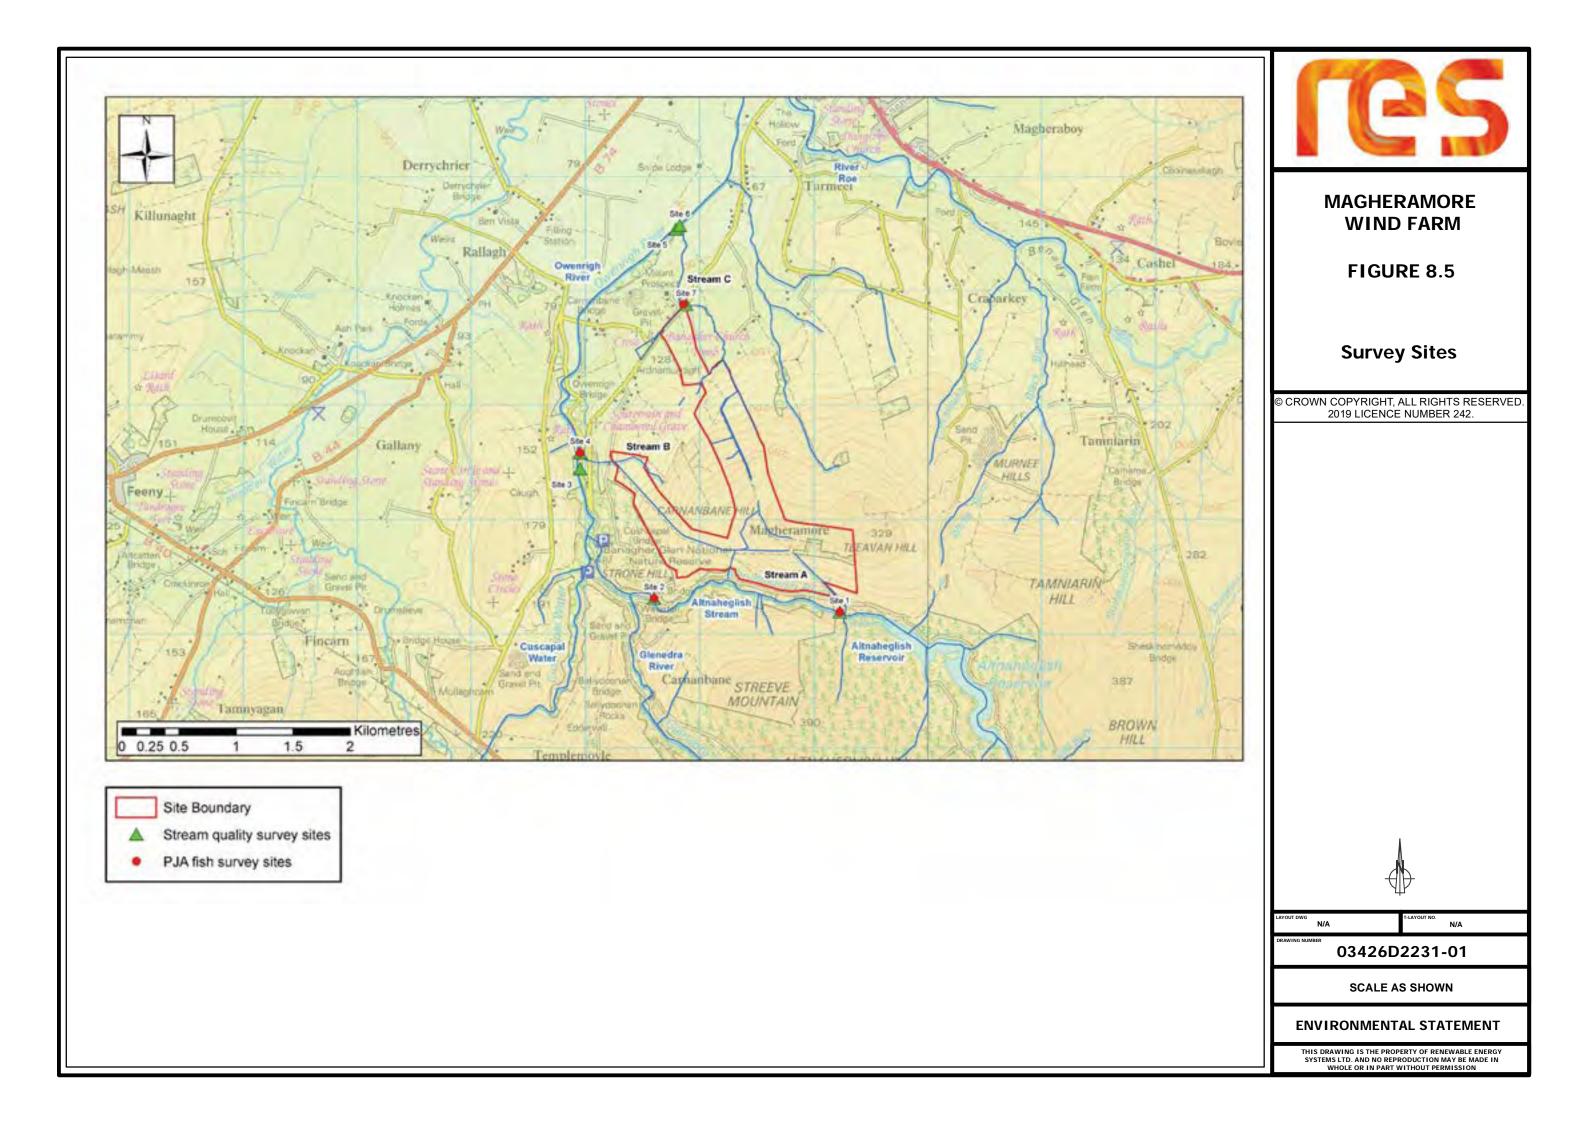
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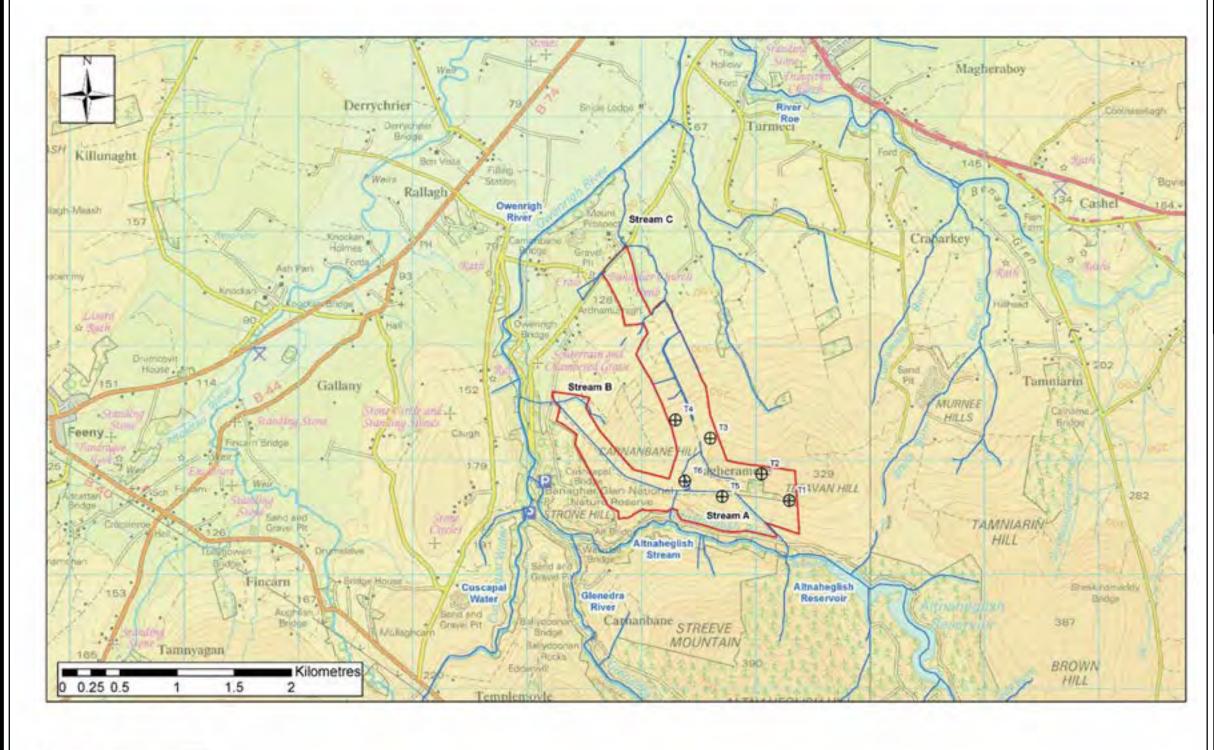
SCALE AS SHOWN

**ENVIRONMENTAL STATEMENT** 

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Wind\_Turbines

Site Boundary



### MAGHERAMORE WIND FARM

FIGURE 8.6

Site drainage to Altnaheglish/Owenrigh River

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YOUT DWG N/A

LAYOUT NO.

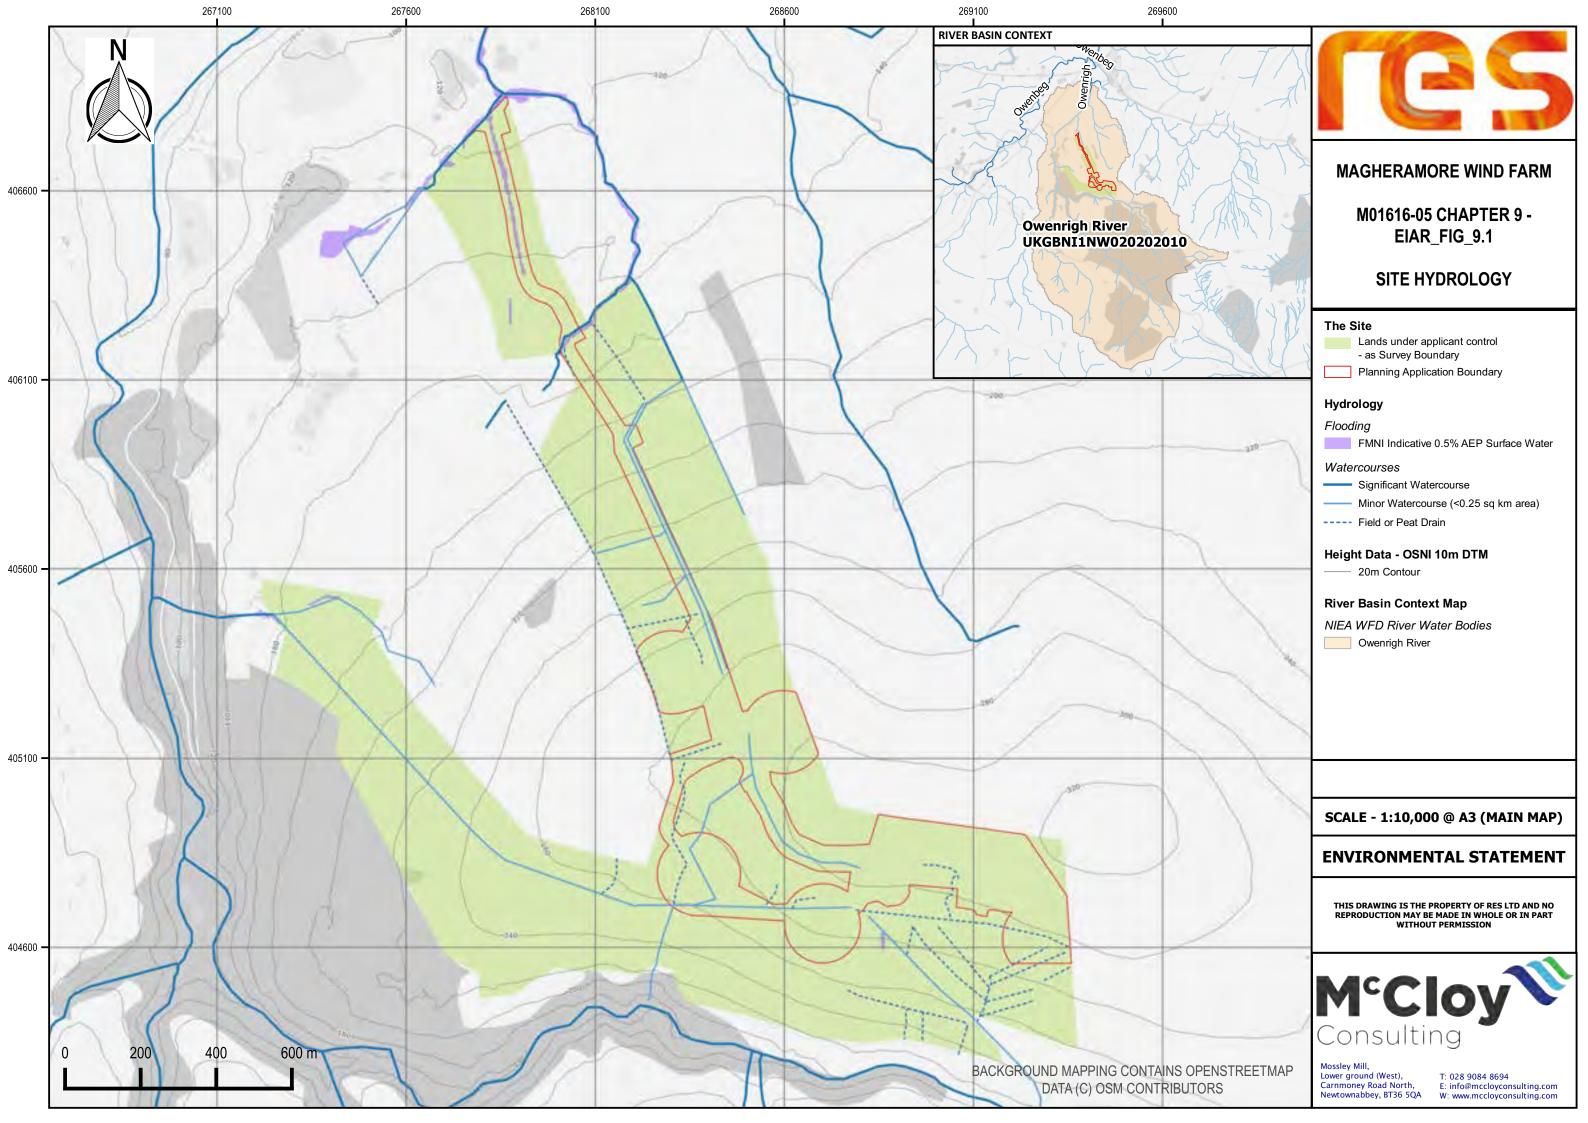
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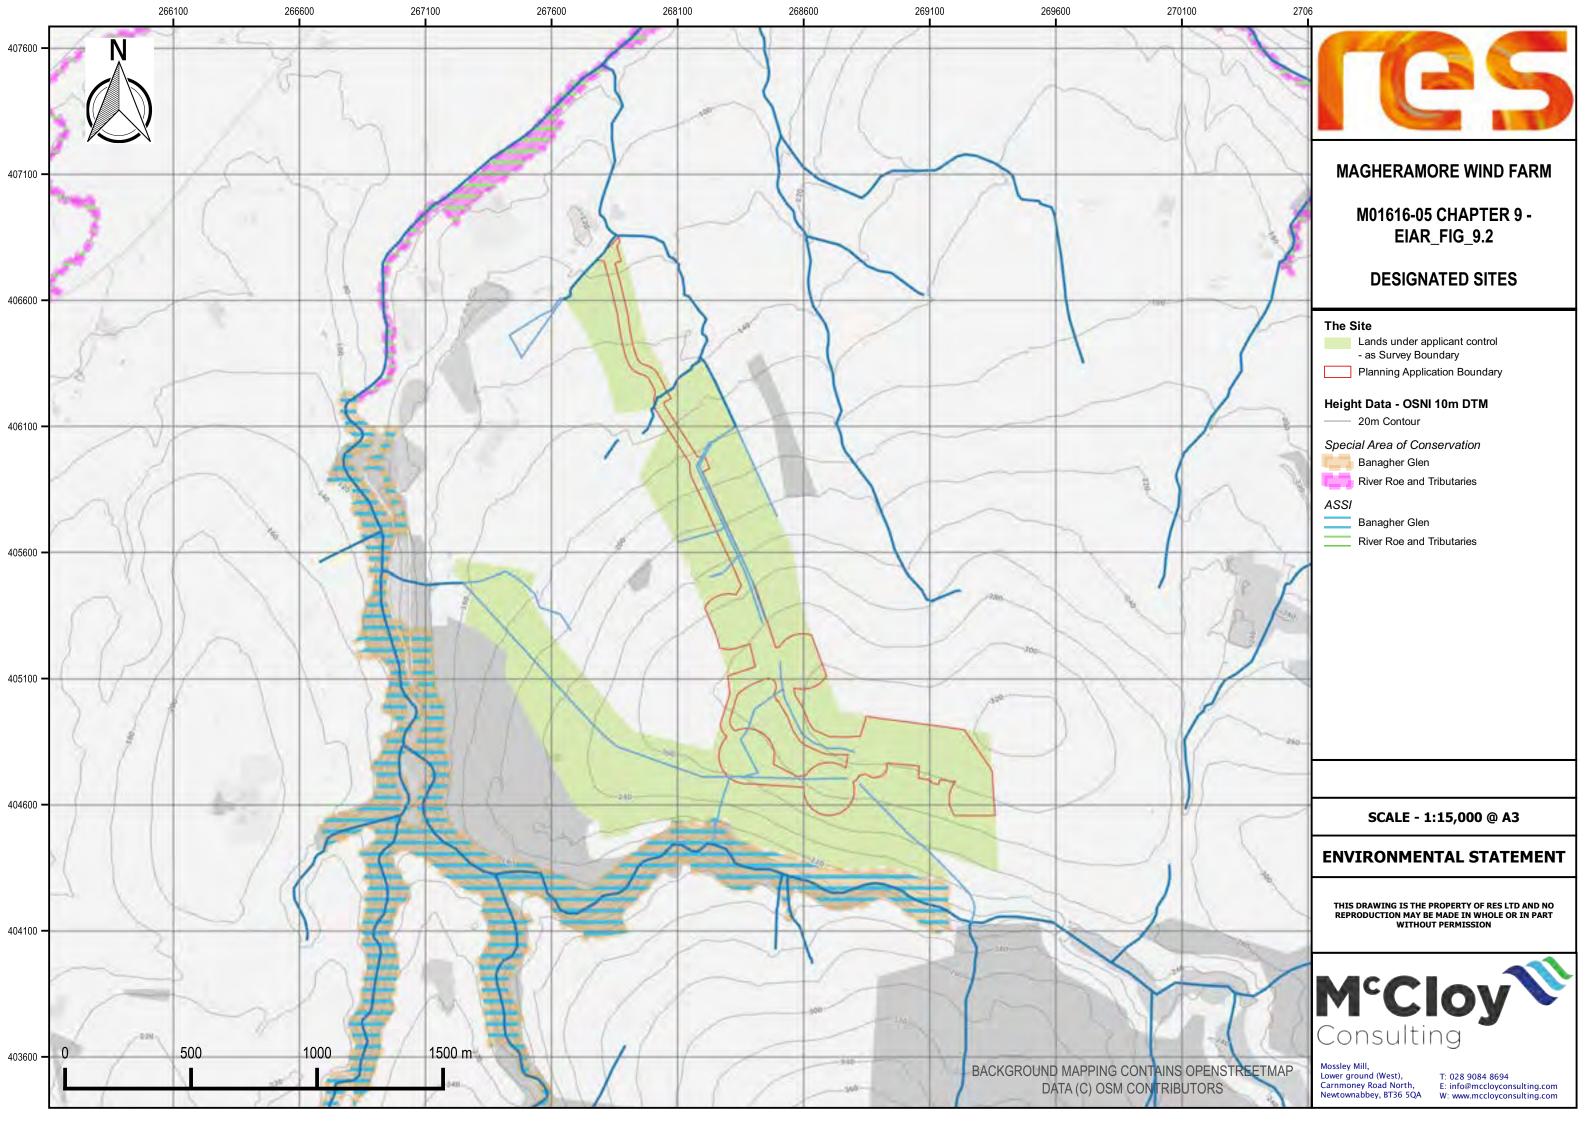
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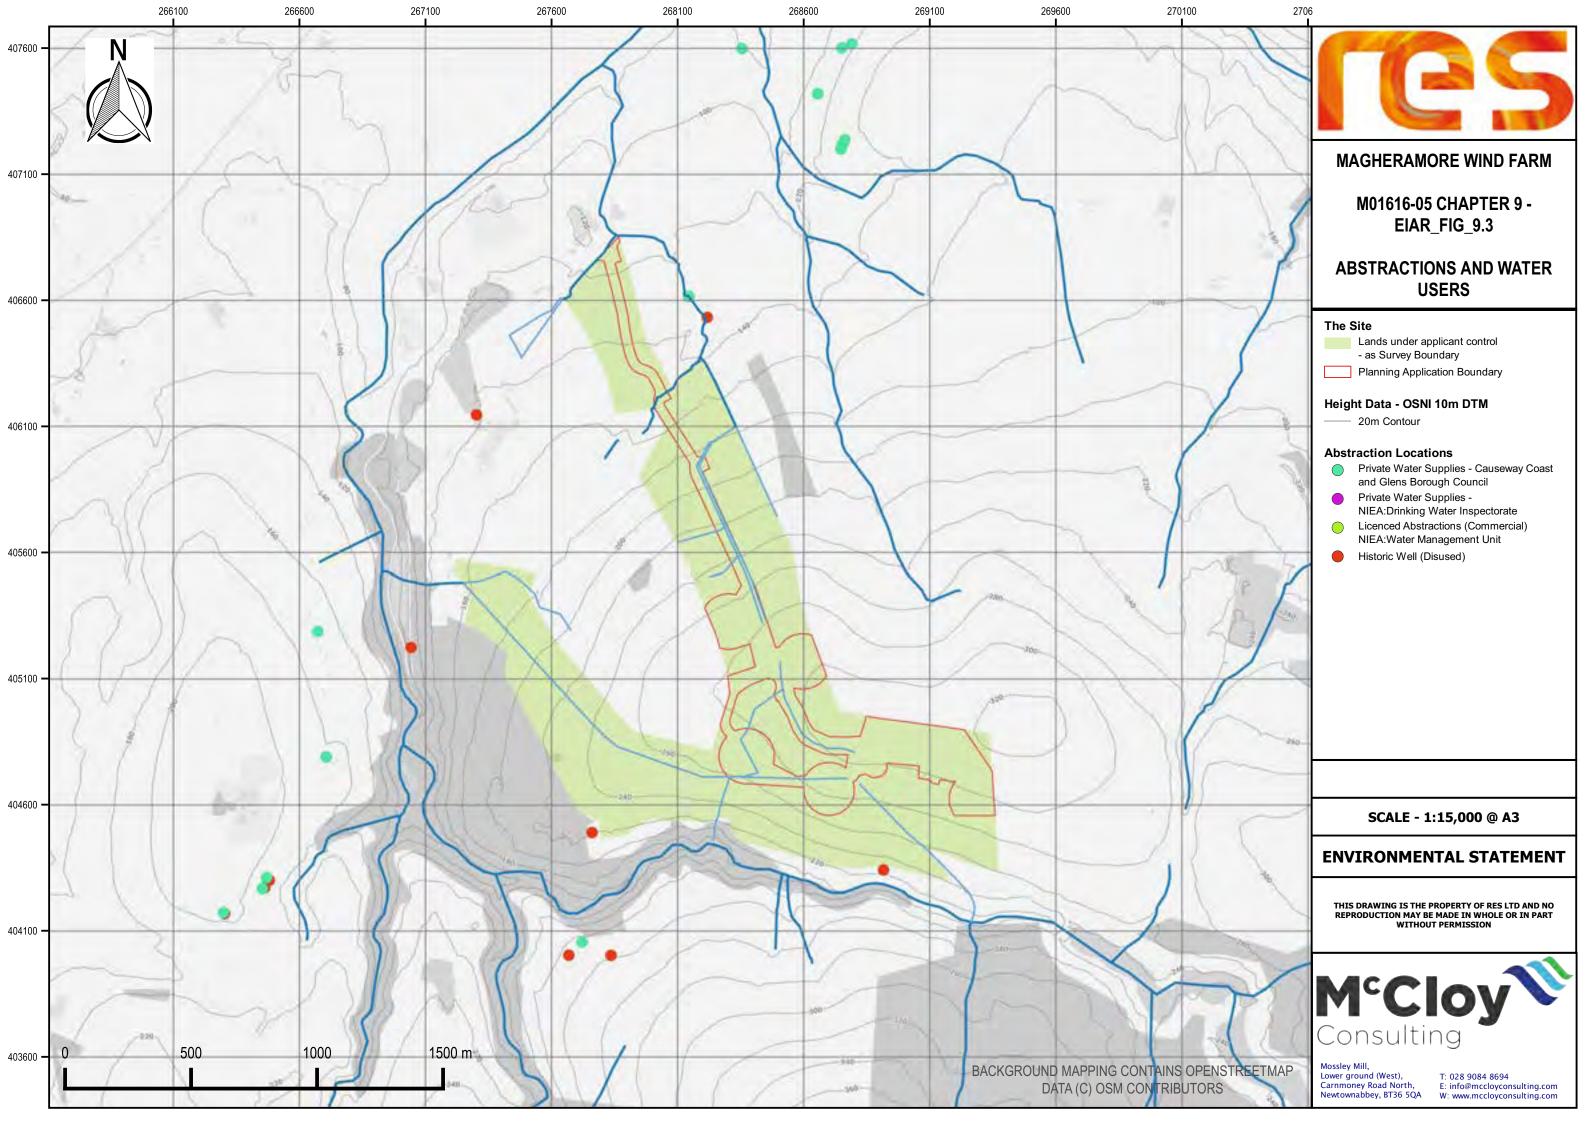
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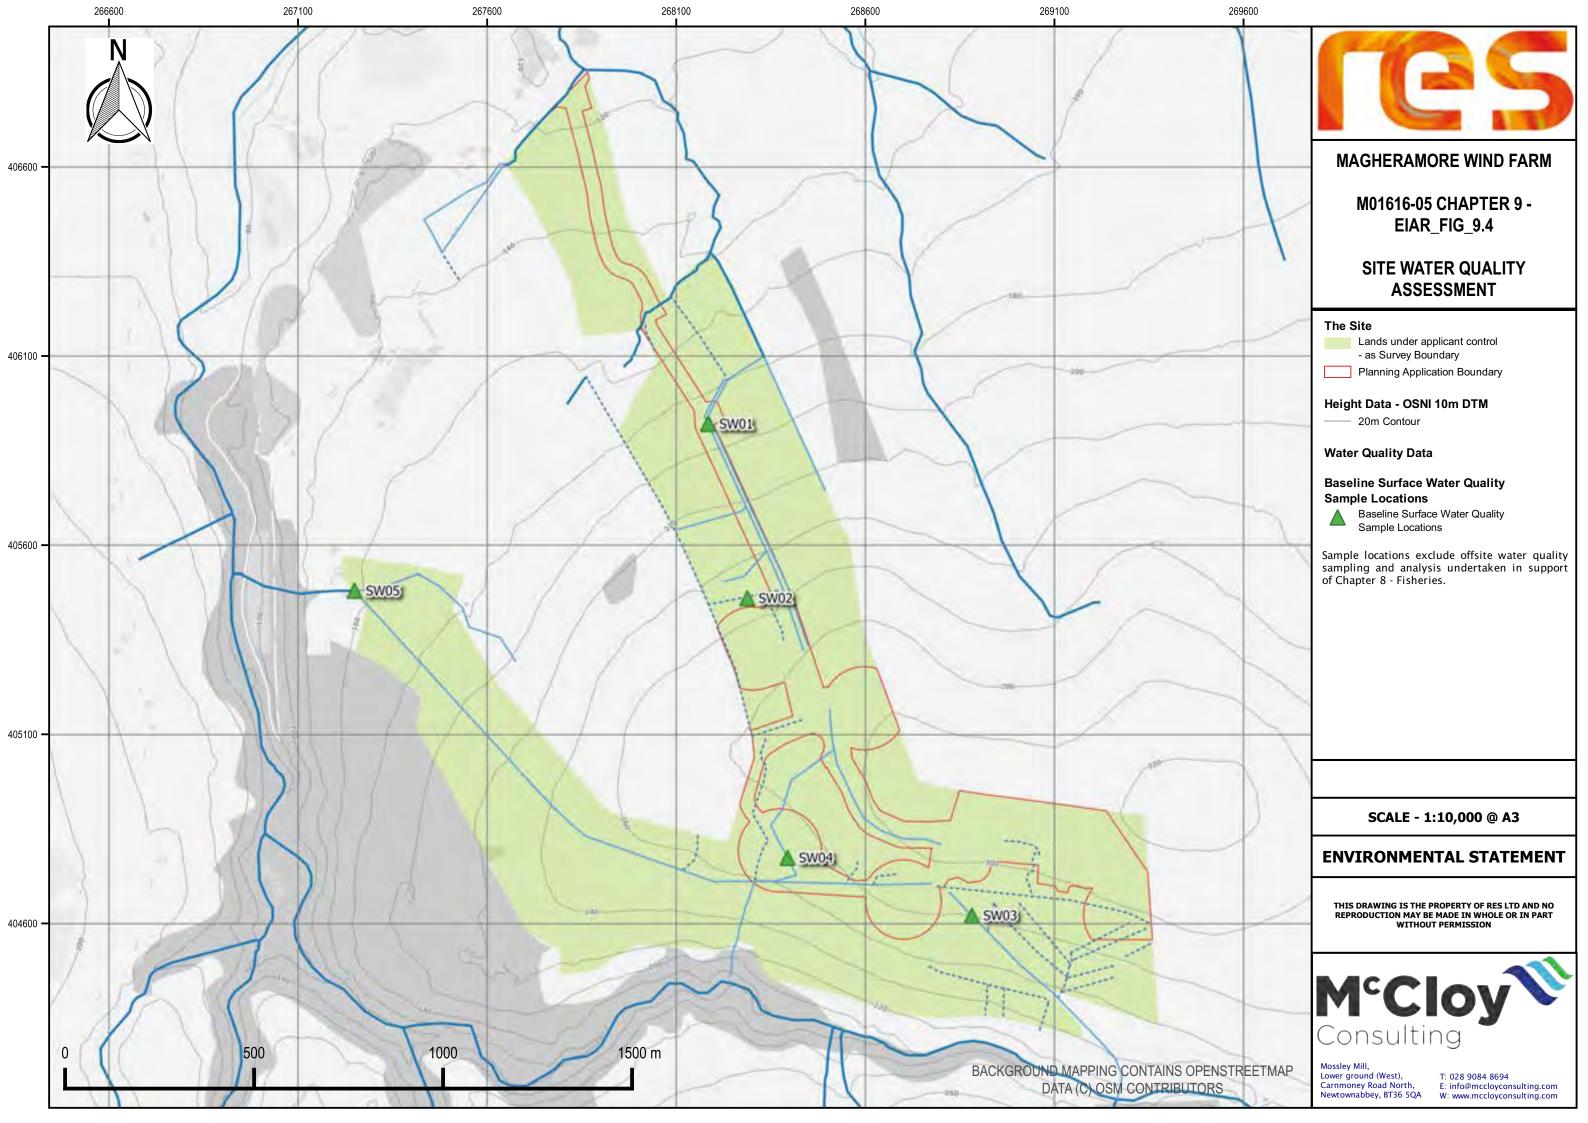
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## **Geology & Water Environment**











# 
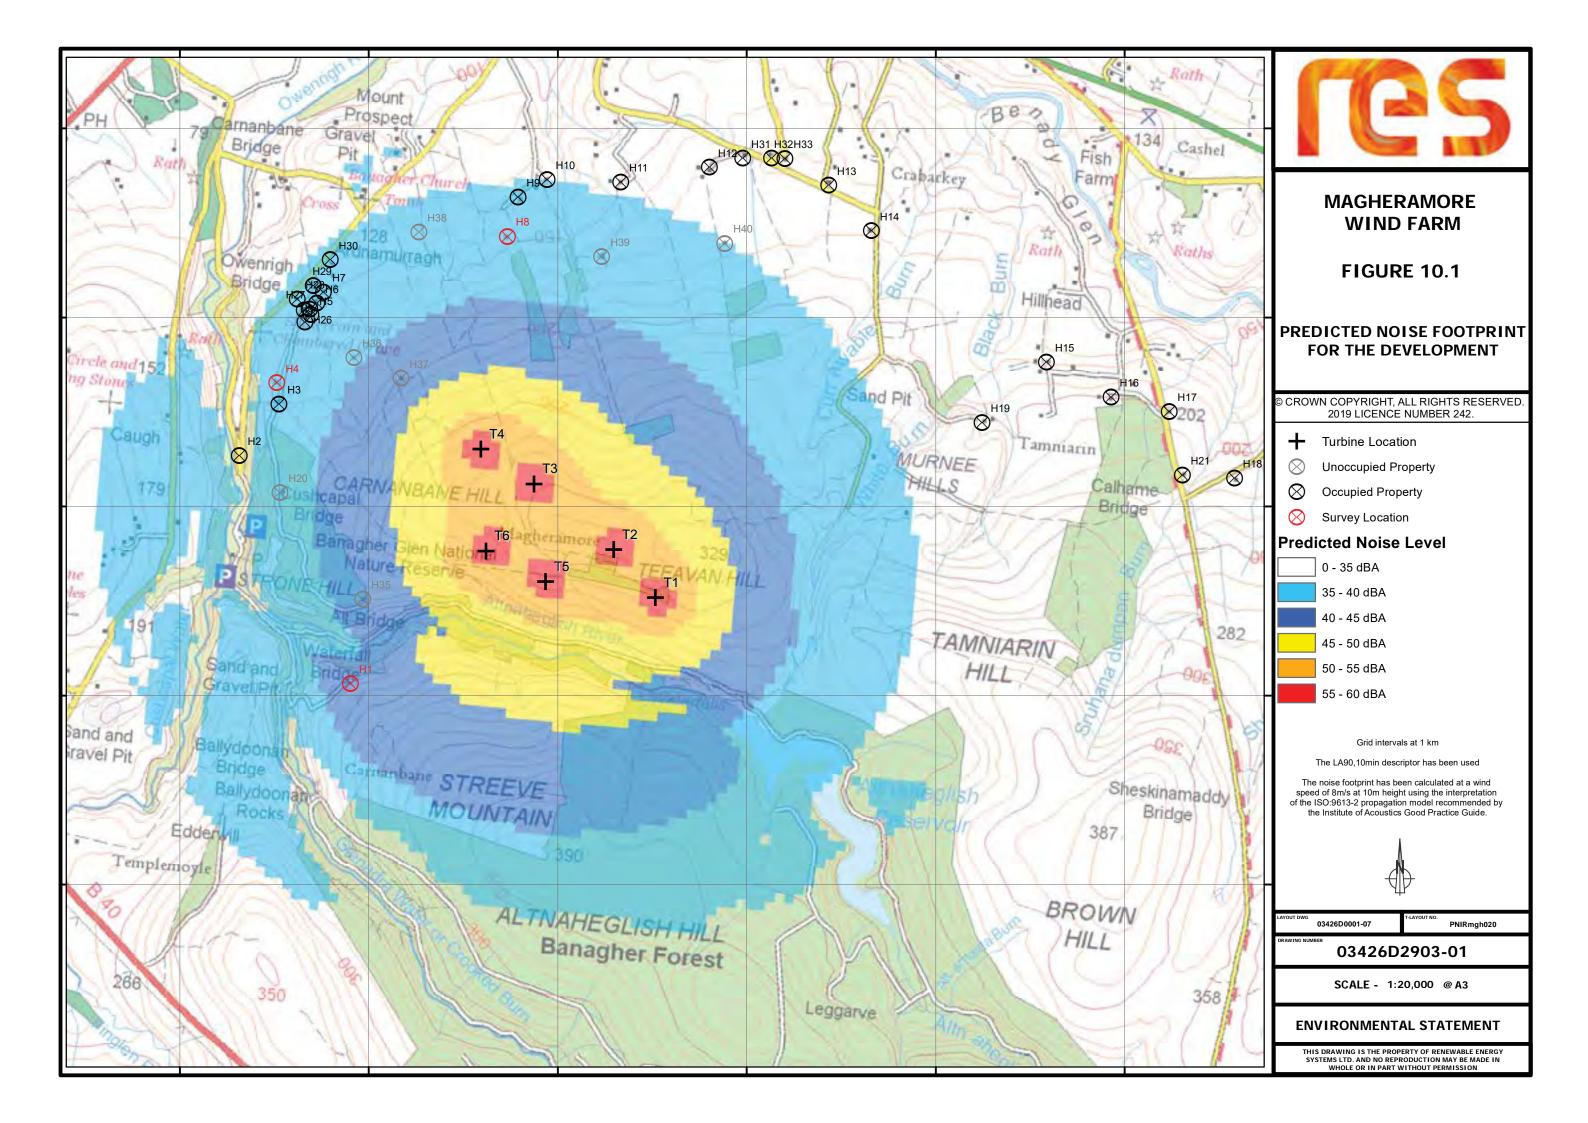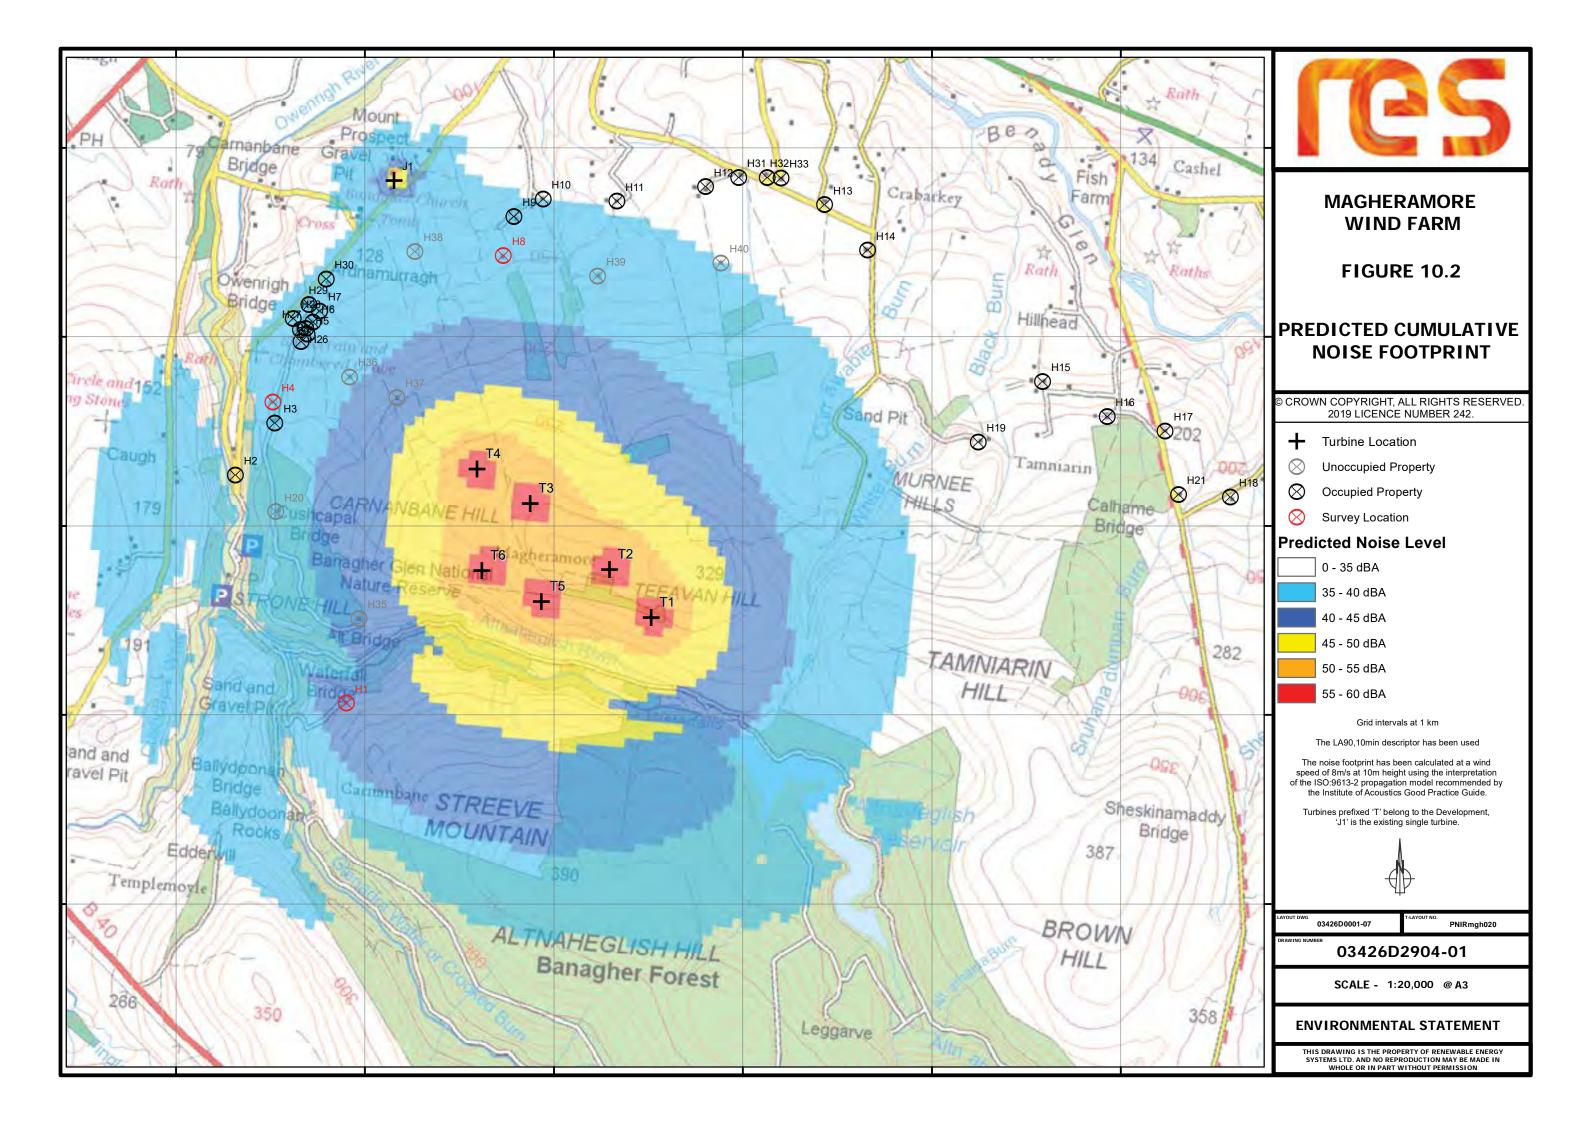
## Noise





Traffic & Transport

